



Transportation and Engineering

DRAWIN (G LIST
DRAWING NO.	DESCRIPTION
001	ST. GREGORY THE GREAT CES — REMOVALS PLAN
002	ST. GREGORY THE GREAT CES — NEW CONSTRUCTION
003	ST. GREGORY THE GREAT CES — PAVEMENT MARKING PLAN
004	ST. GREGORY THE GREAT CES — DETAILS
005	ST. BERNADETTE CES — REMOVALS PLAN — 10+000 TO 10+290
006	ST. BERNADETTE CES — REMOVALS PLAN — 10+290 TO 10+400
007	ST. BERNADETTE CES - NEW CONSTRUCTION - 10+000 TO 10+290
008	ST. BERNADETTE CES - NEW CONSTRUCTION - 10+290 TO 10+400
009	ST. BERNADETTE CES - PAVEMENT MARKING PLAN - 10+000 TO 10+290
010	ST. BERNADETTE CES — PAVEMENT MARKING PLAN — 10+290 TO 10+400
011	HERITAGE GLEN PS — REMOVALS PLAN
012	HERITAGE GLEN PS - NEW CONSTRUCTION
013	HERITAGE GLEN PS — PAVEMENT MARKING PLAN
014	DETAILS
TPP-1	ST. GREGORY THE GREAT CES — TREE PROTECTION PLAN
TPP-2	ST. GREGORY THE GREAT CES — TREE PROTECTION PLAN
TPP-3	ST. BERNADETTE CES - TREE PROTECTION PLAN
TPP-4	ST. BERNADETTE CES - TREE PROTECTION PLAN
TPP-5	HERITAGE GLEN PS - TREE PROTECTION PLAN
TPP-6	HERITAGE GLEN PS - TREE PROTECTION PLAN

TRAFFIC CALMING MEASURES SIXTEEN MILE ROAD & HERITAGE WAY RFT##-####

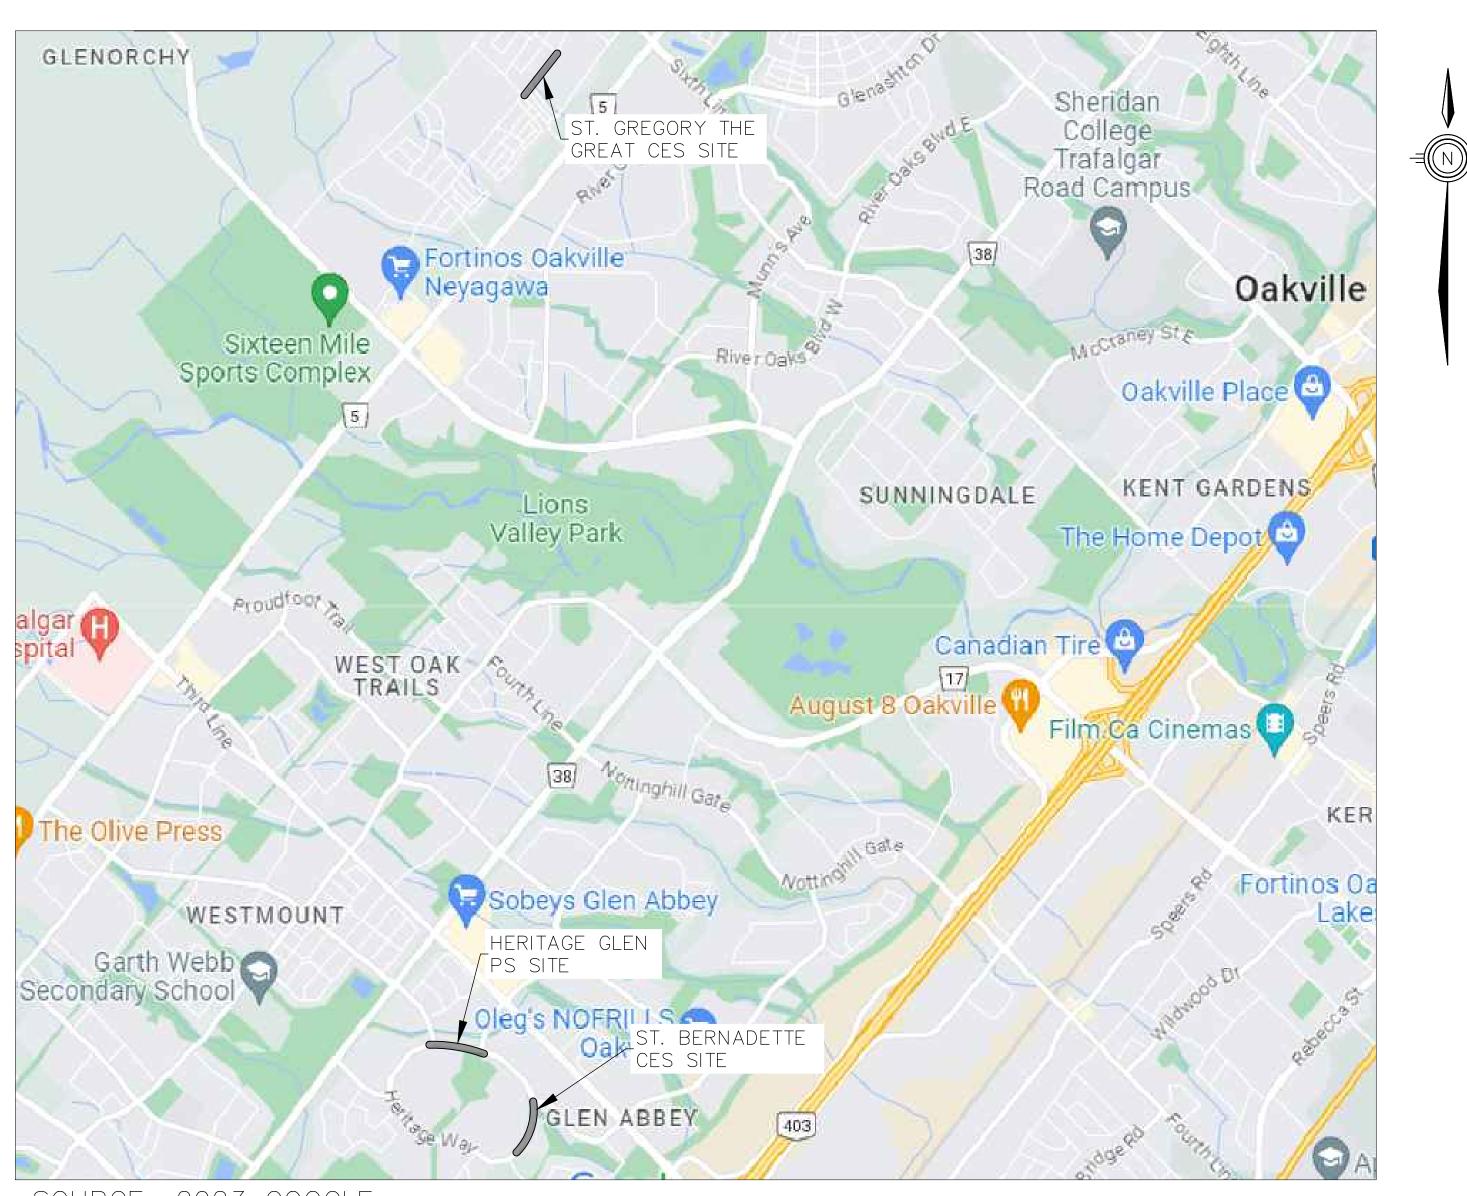



SOURCE: 2023 GOOGLE

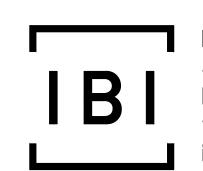



IBI GROUP
Suite 203 – 350 Oxford Street West
London ON N6H 1T3 Canada
tel 519 472 7328

ibigroup.com

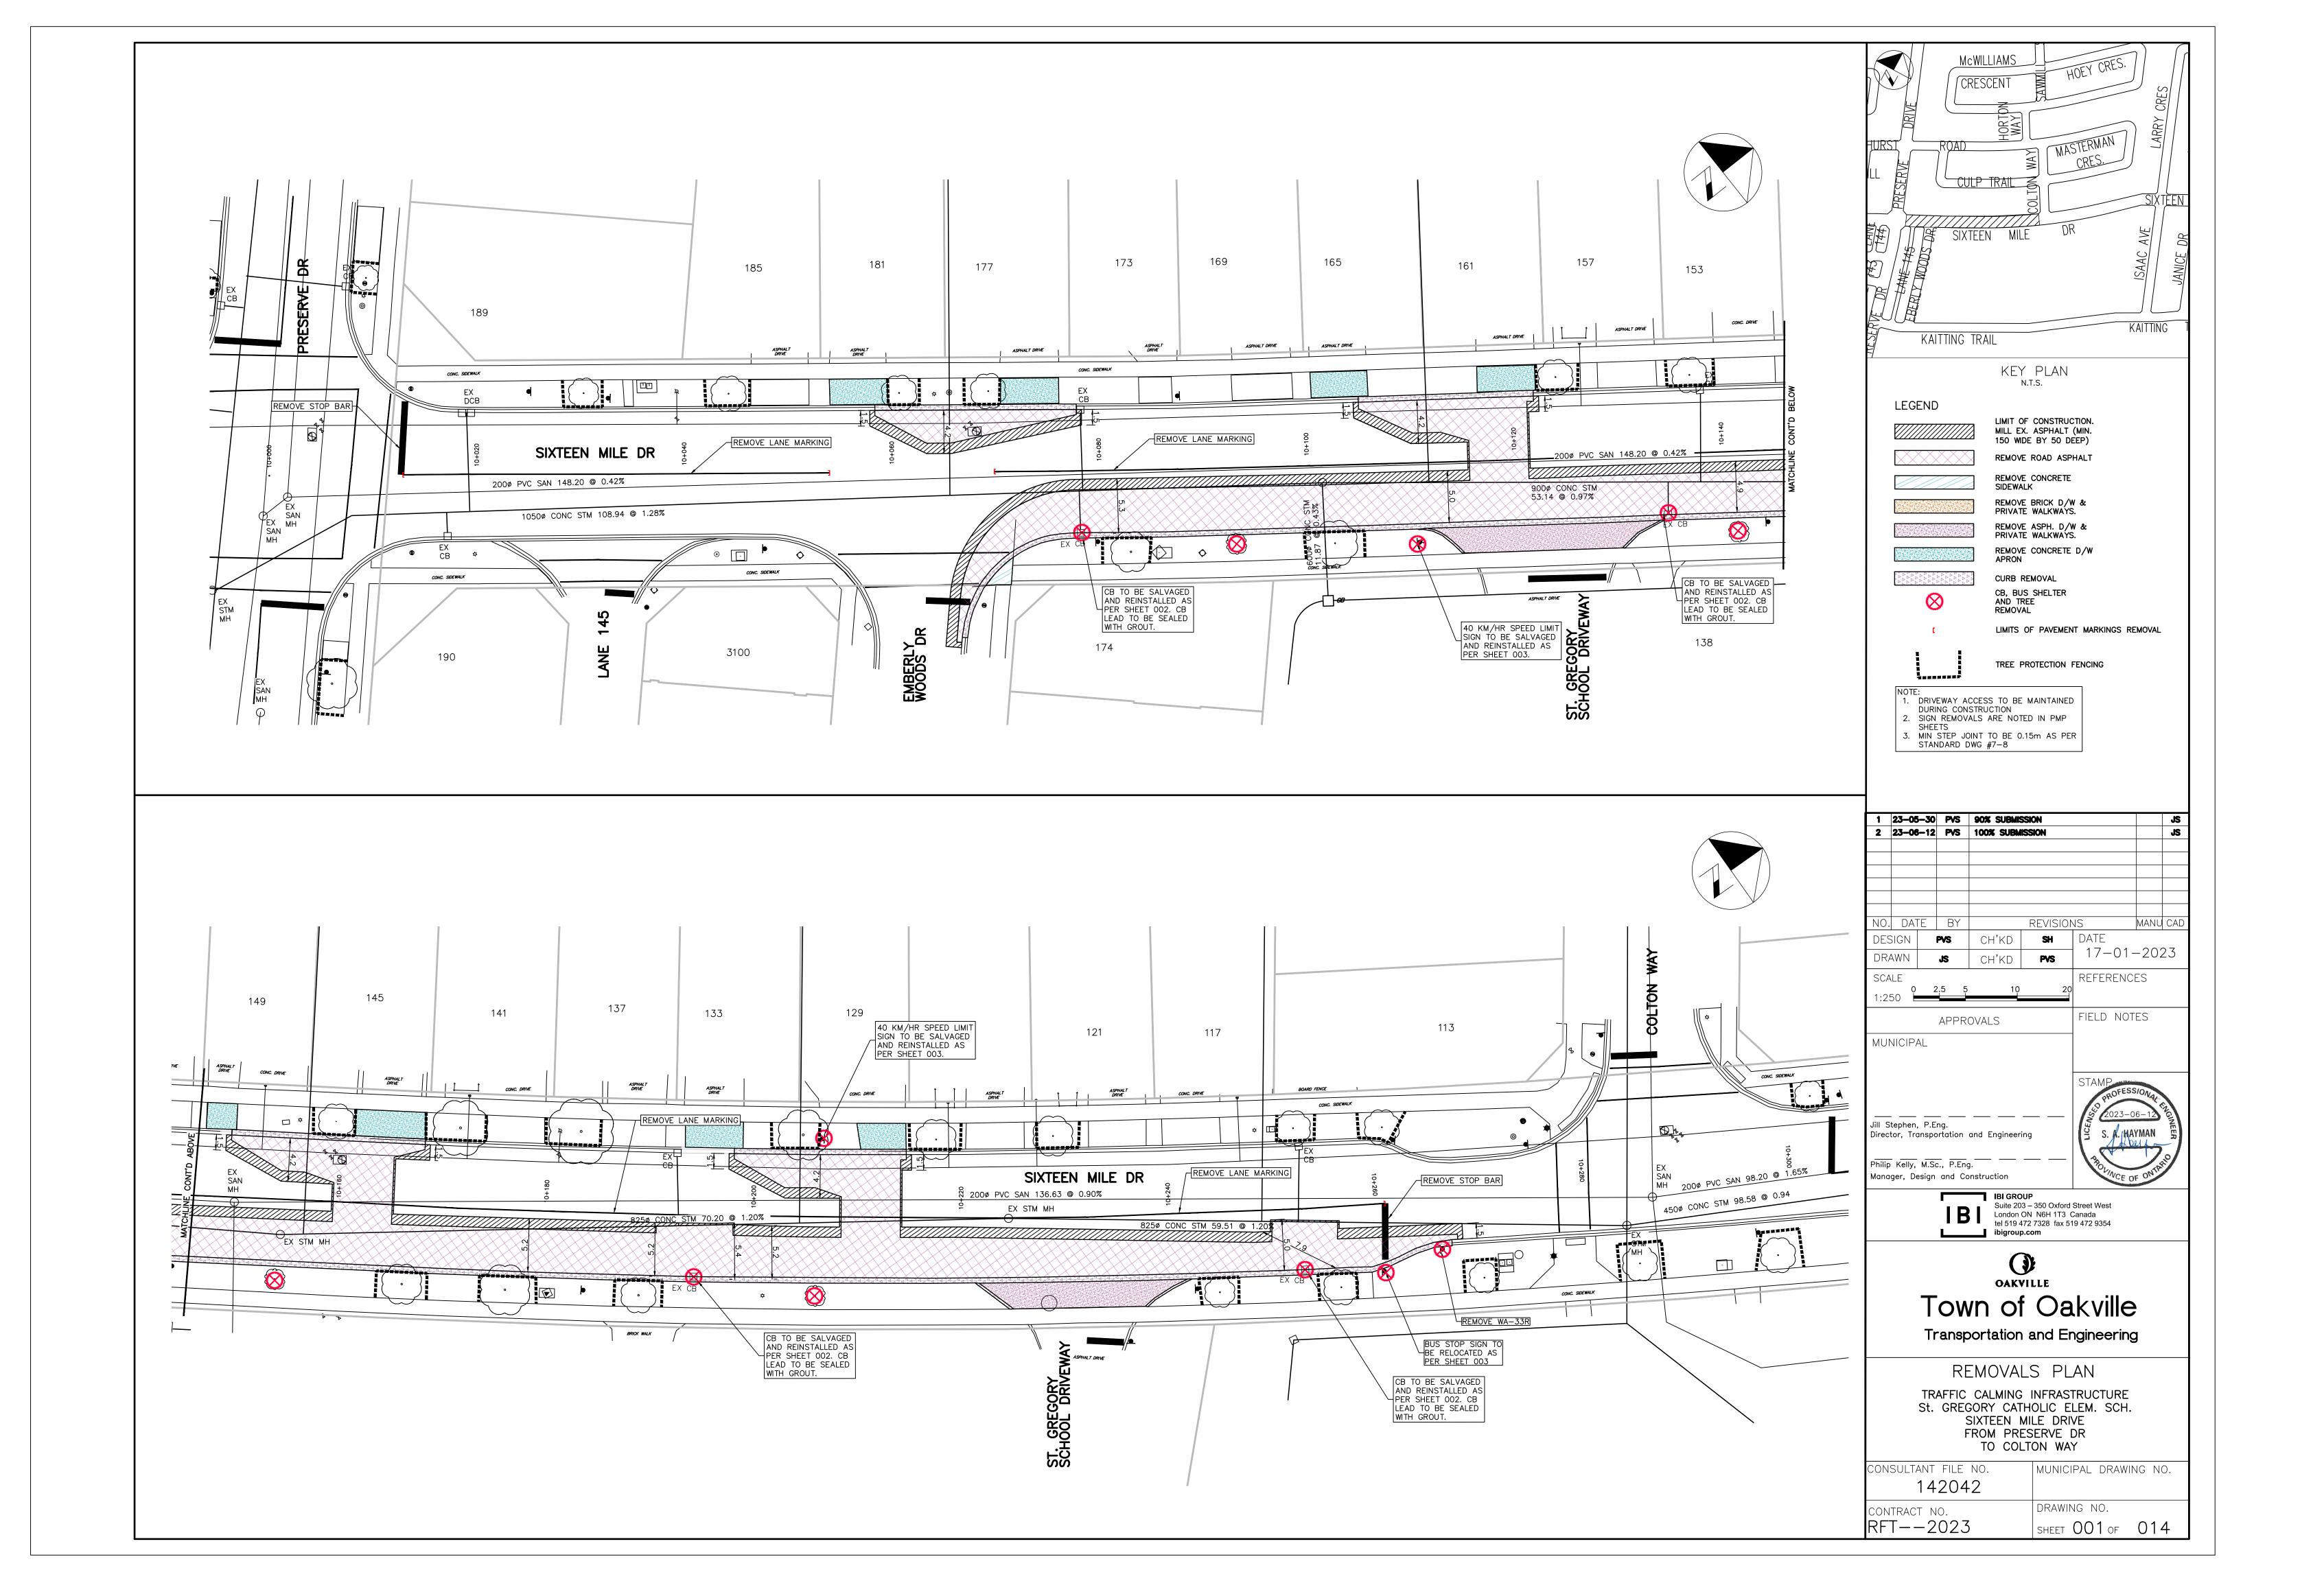

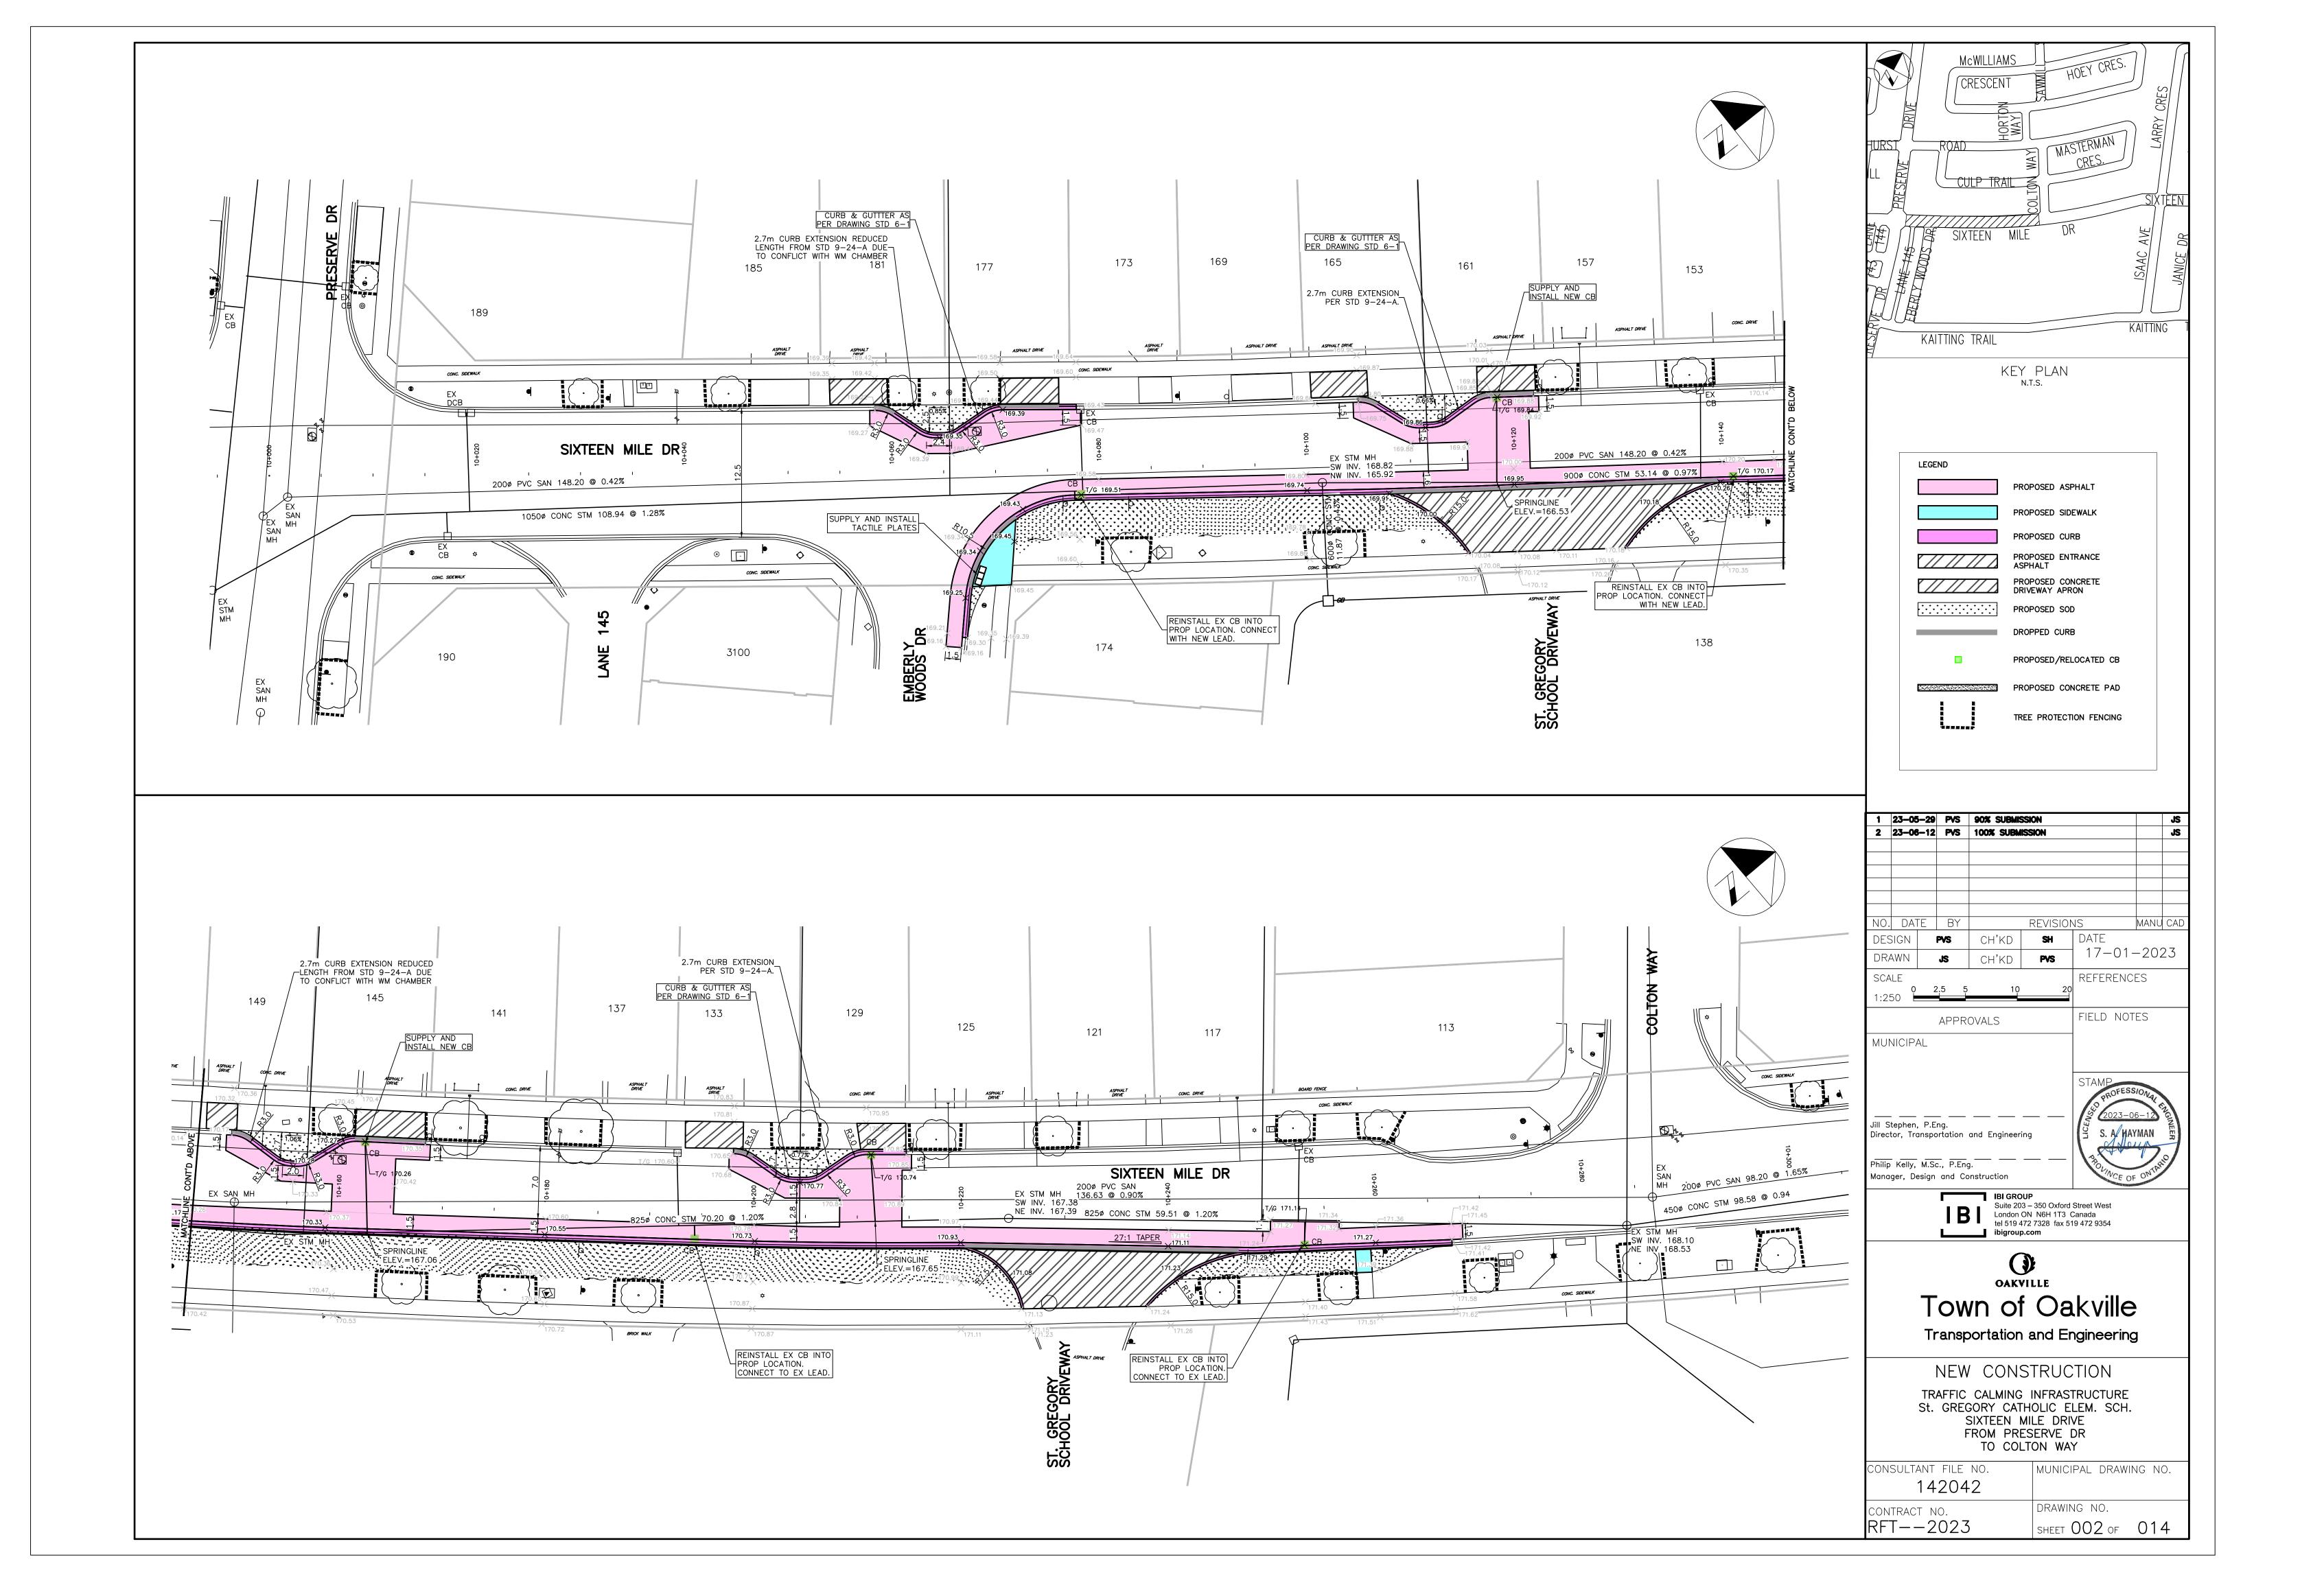

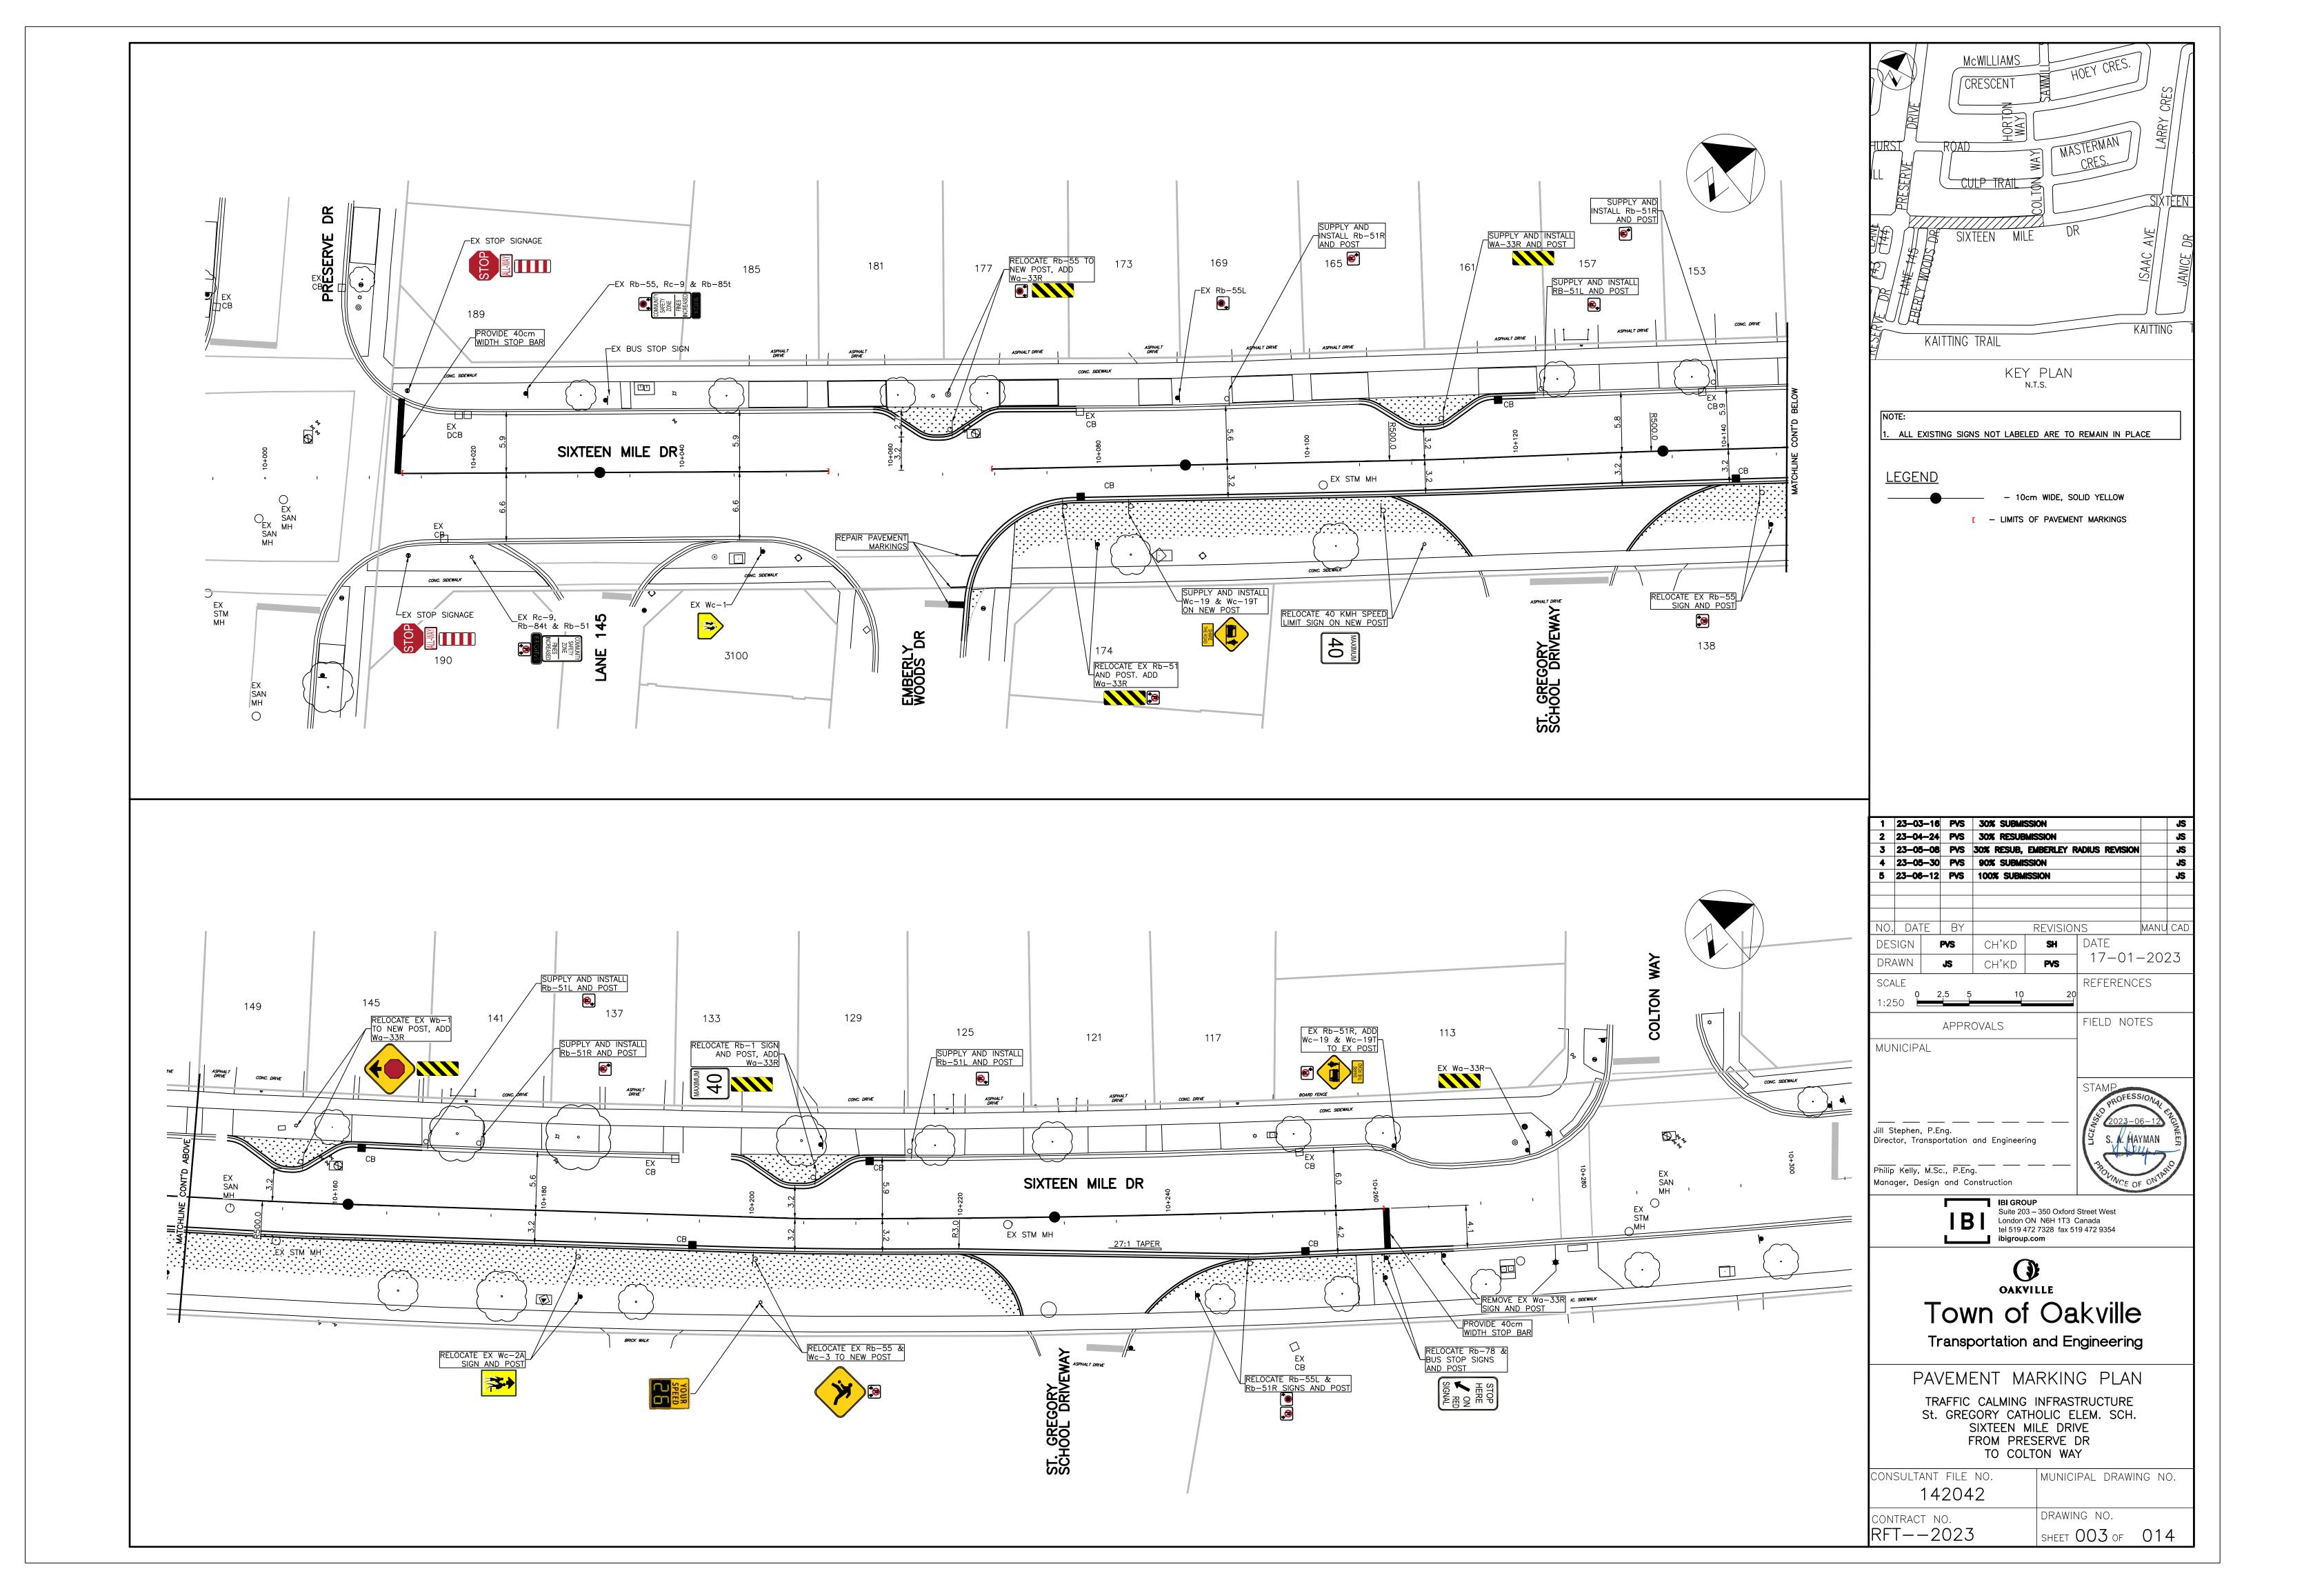

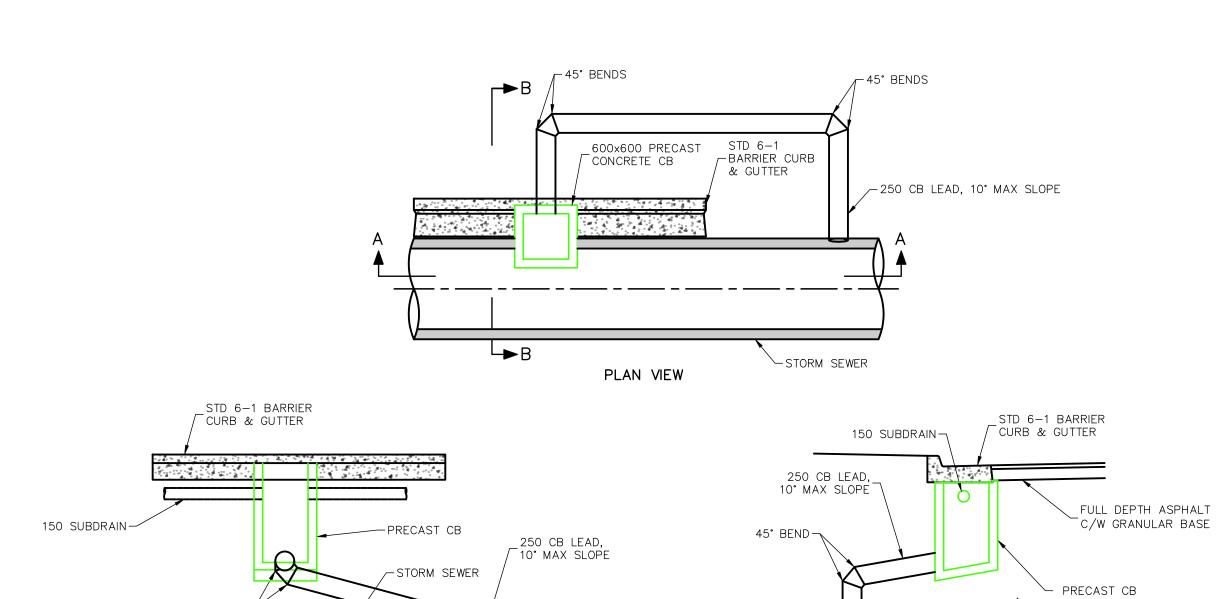

PRECAST CATCHBASIN CONNECTION DETAIL SCALE: N.T.S.


SECTION A-A


√-45° BEND


45° BEND -


_STORM SEWER


SECTION B-B

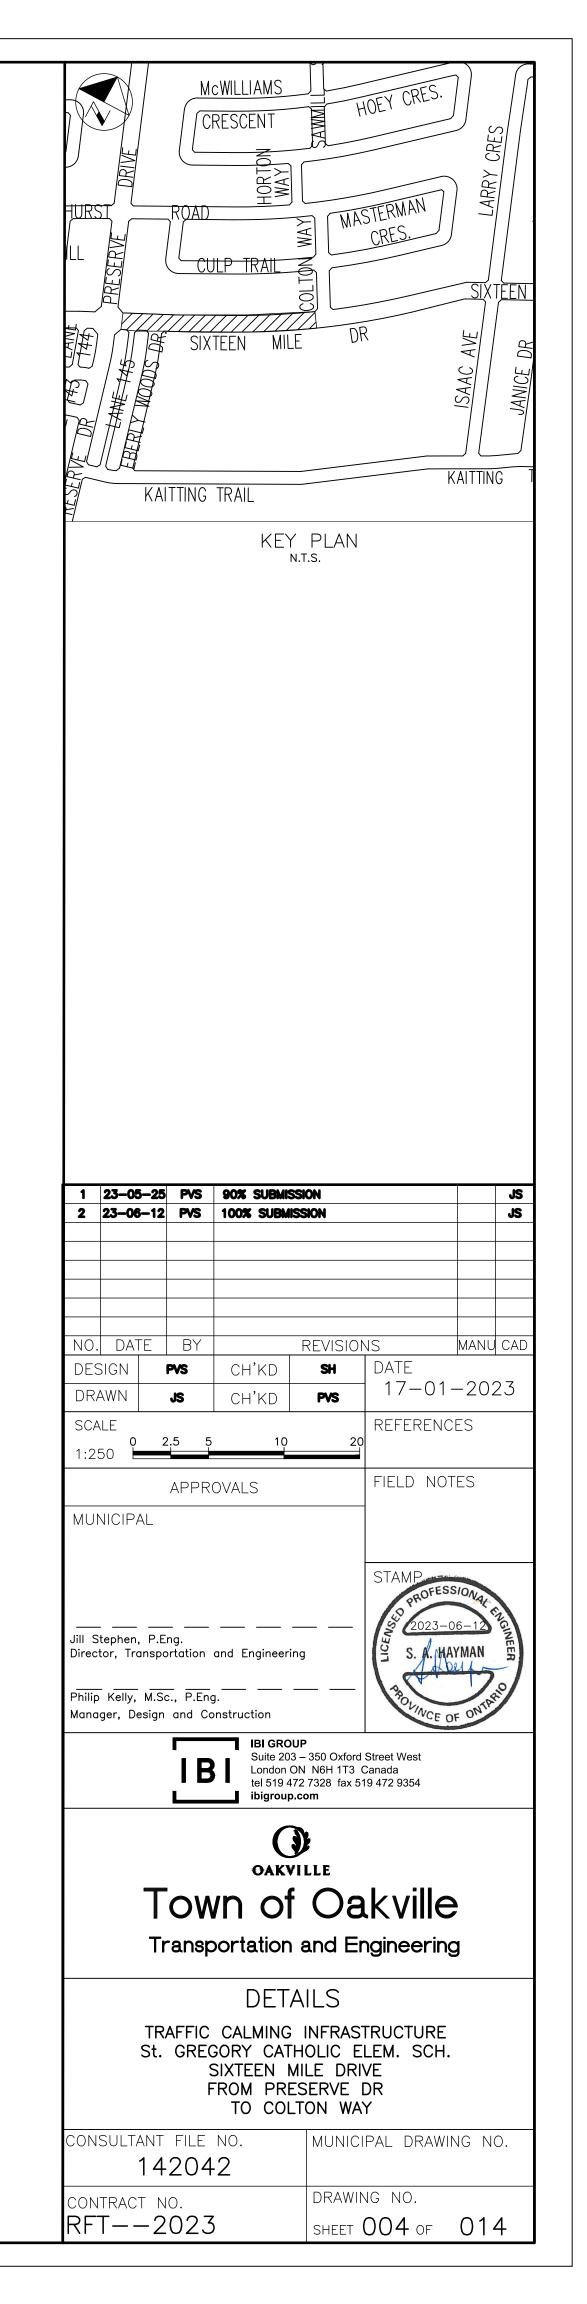


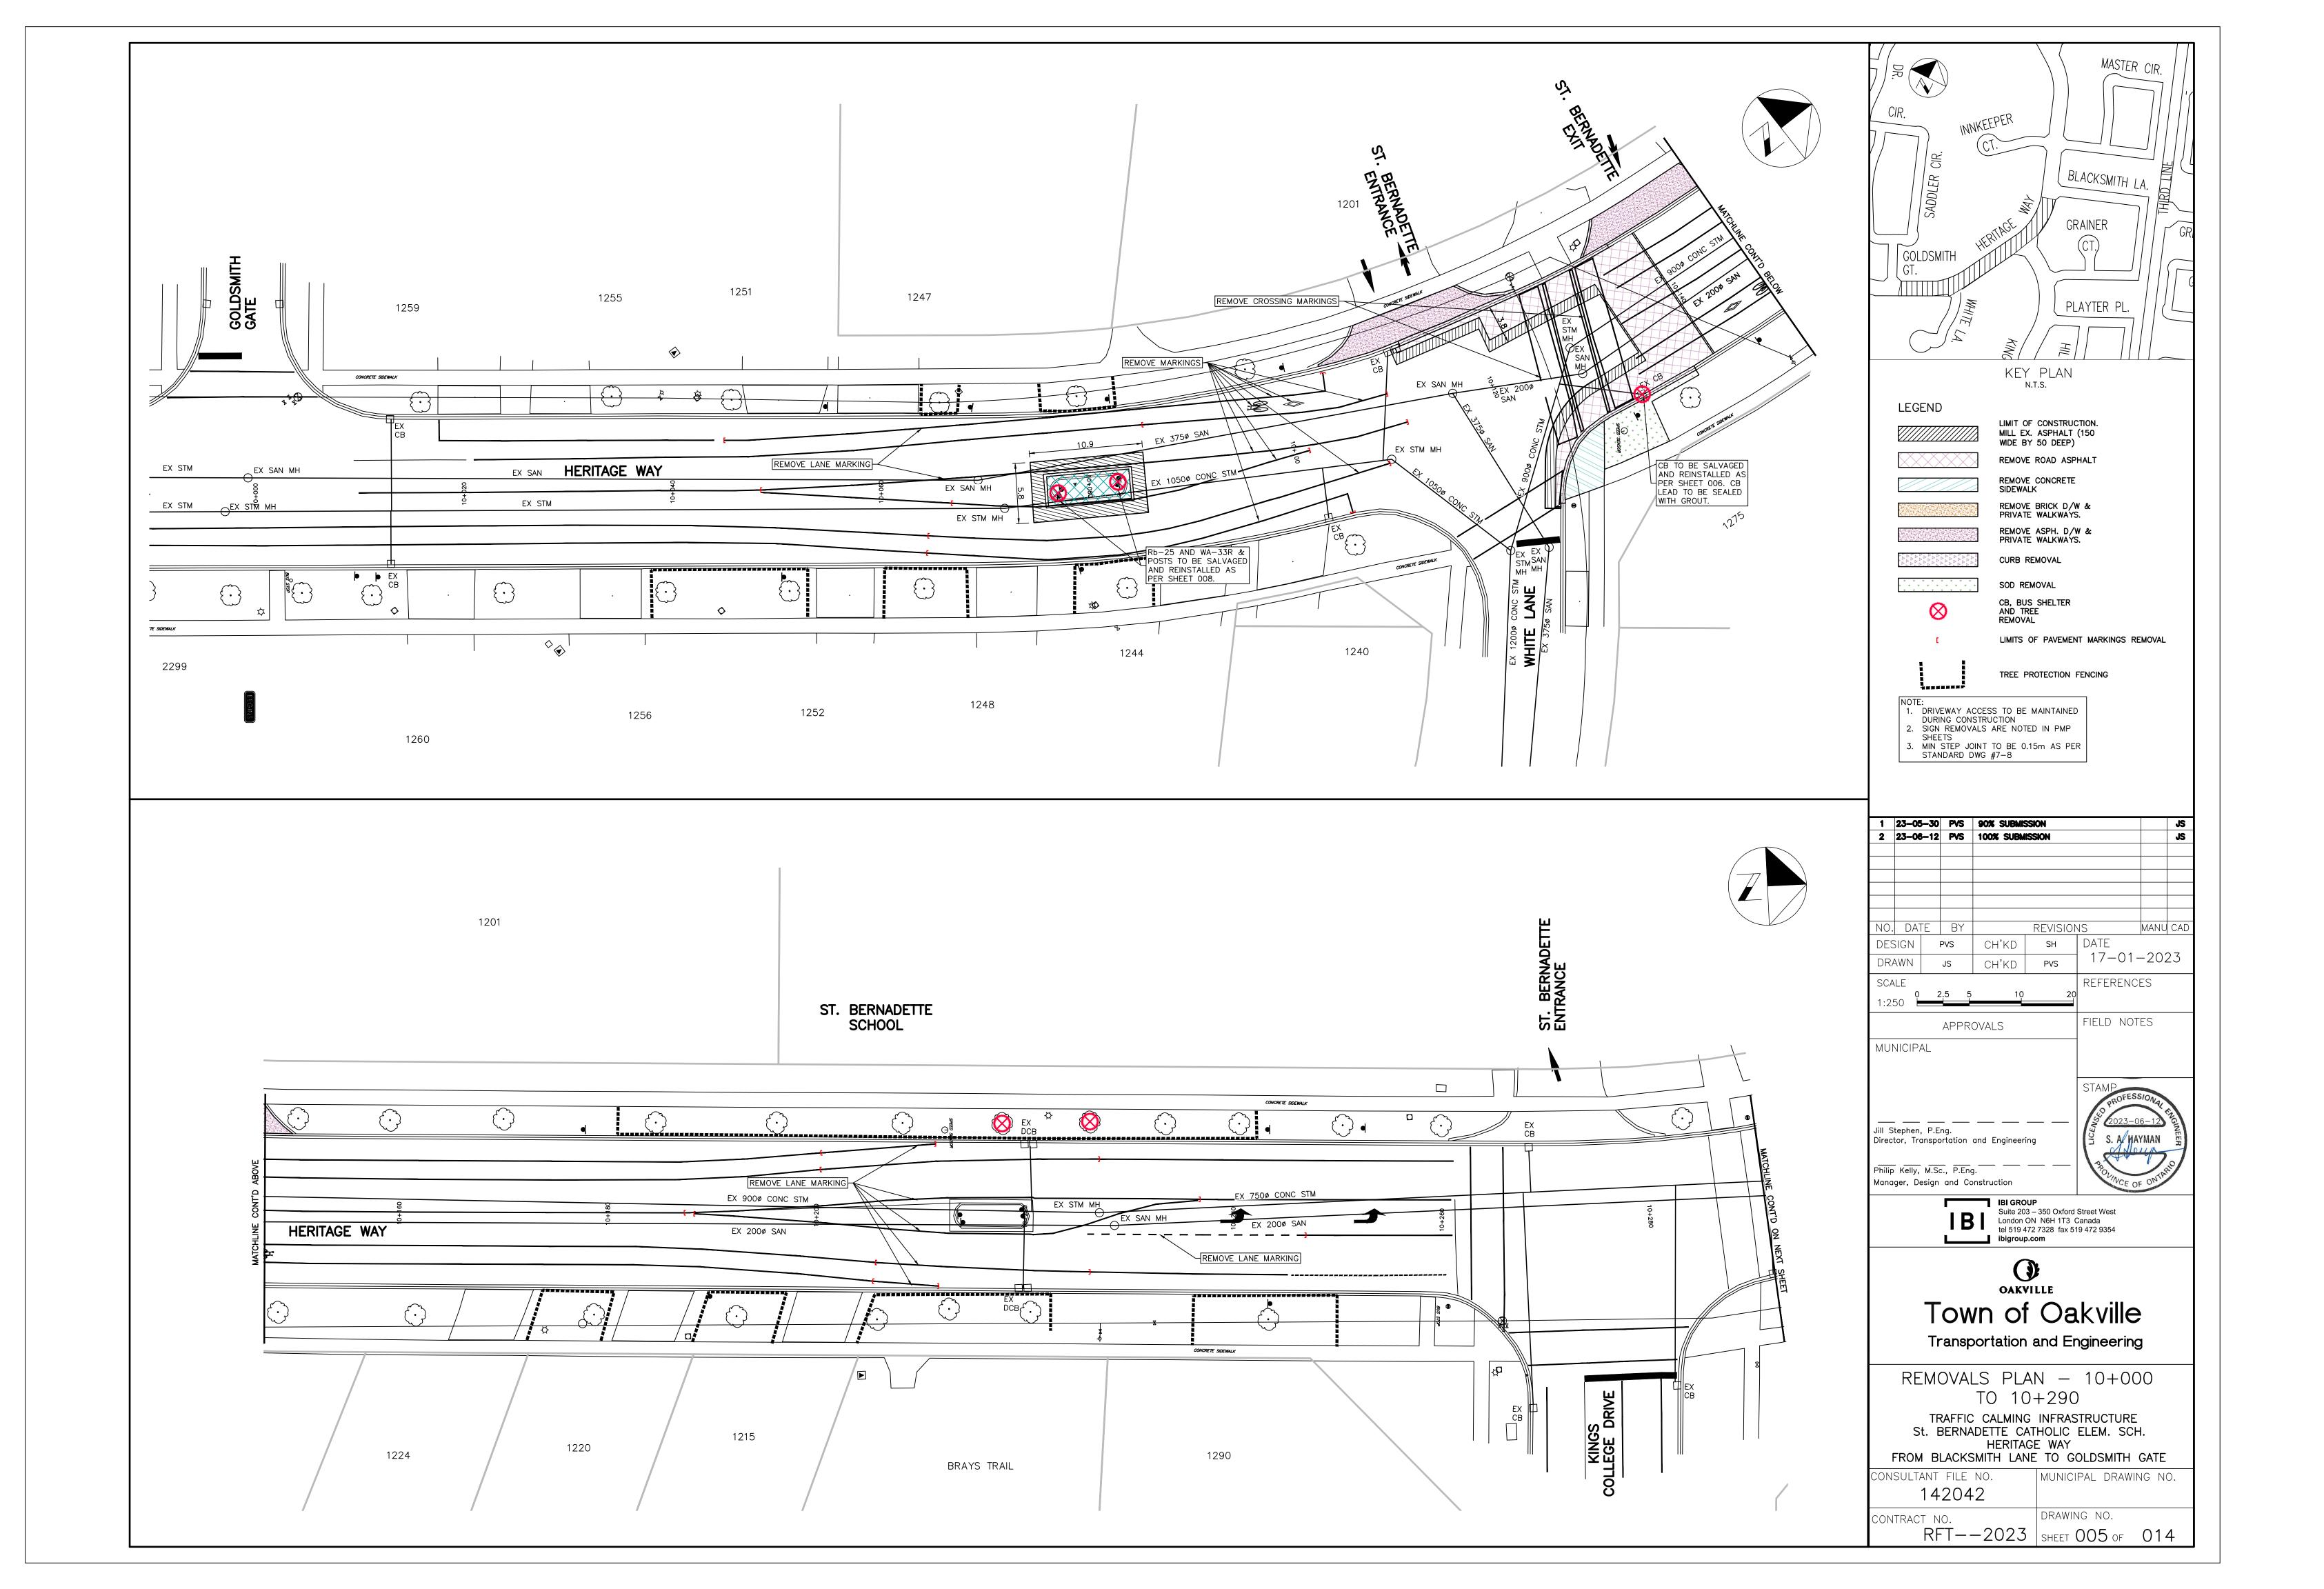


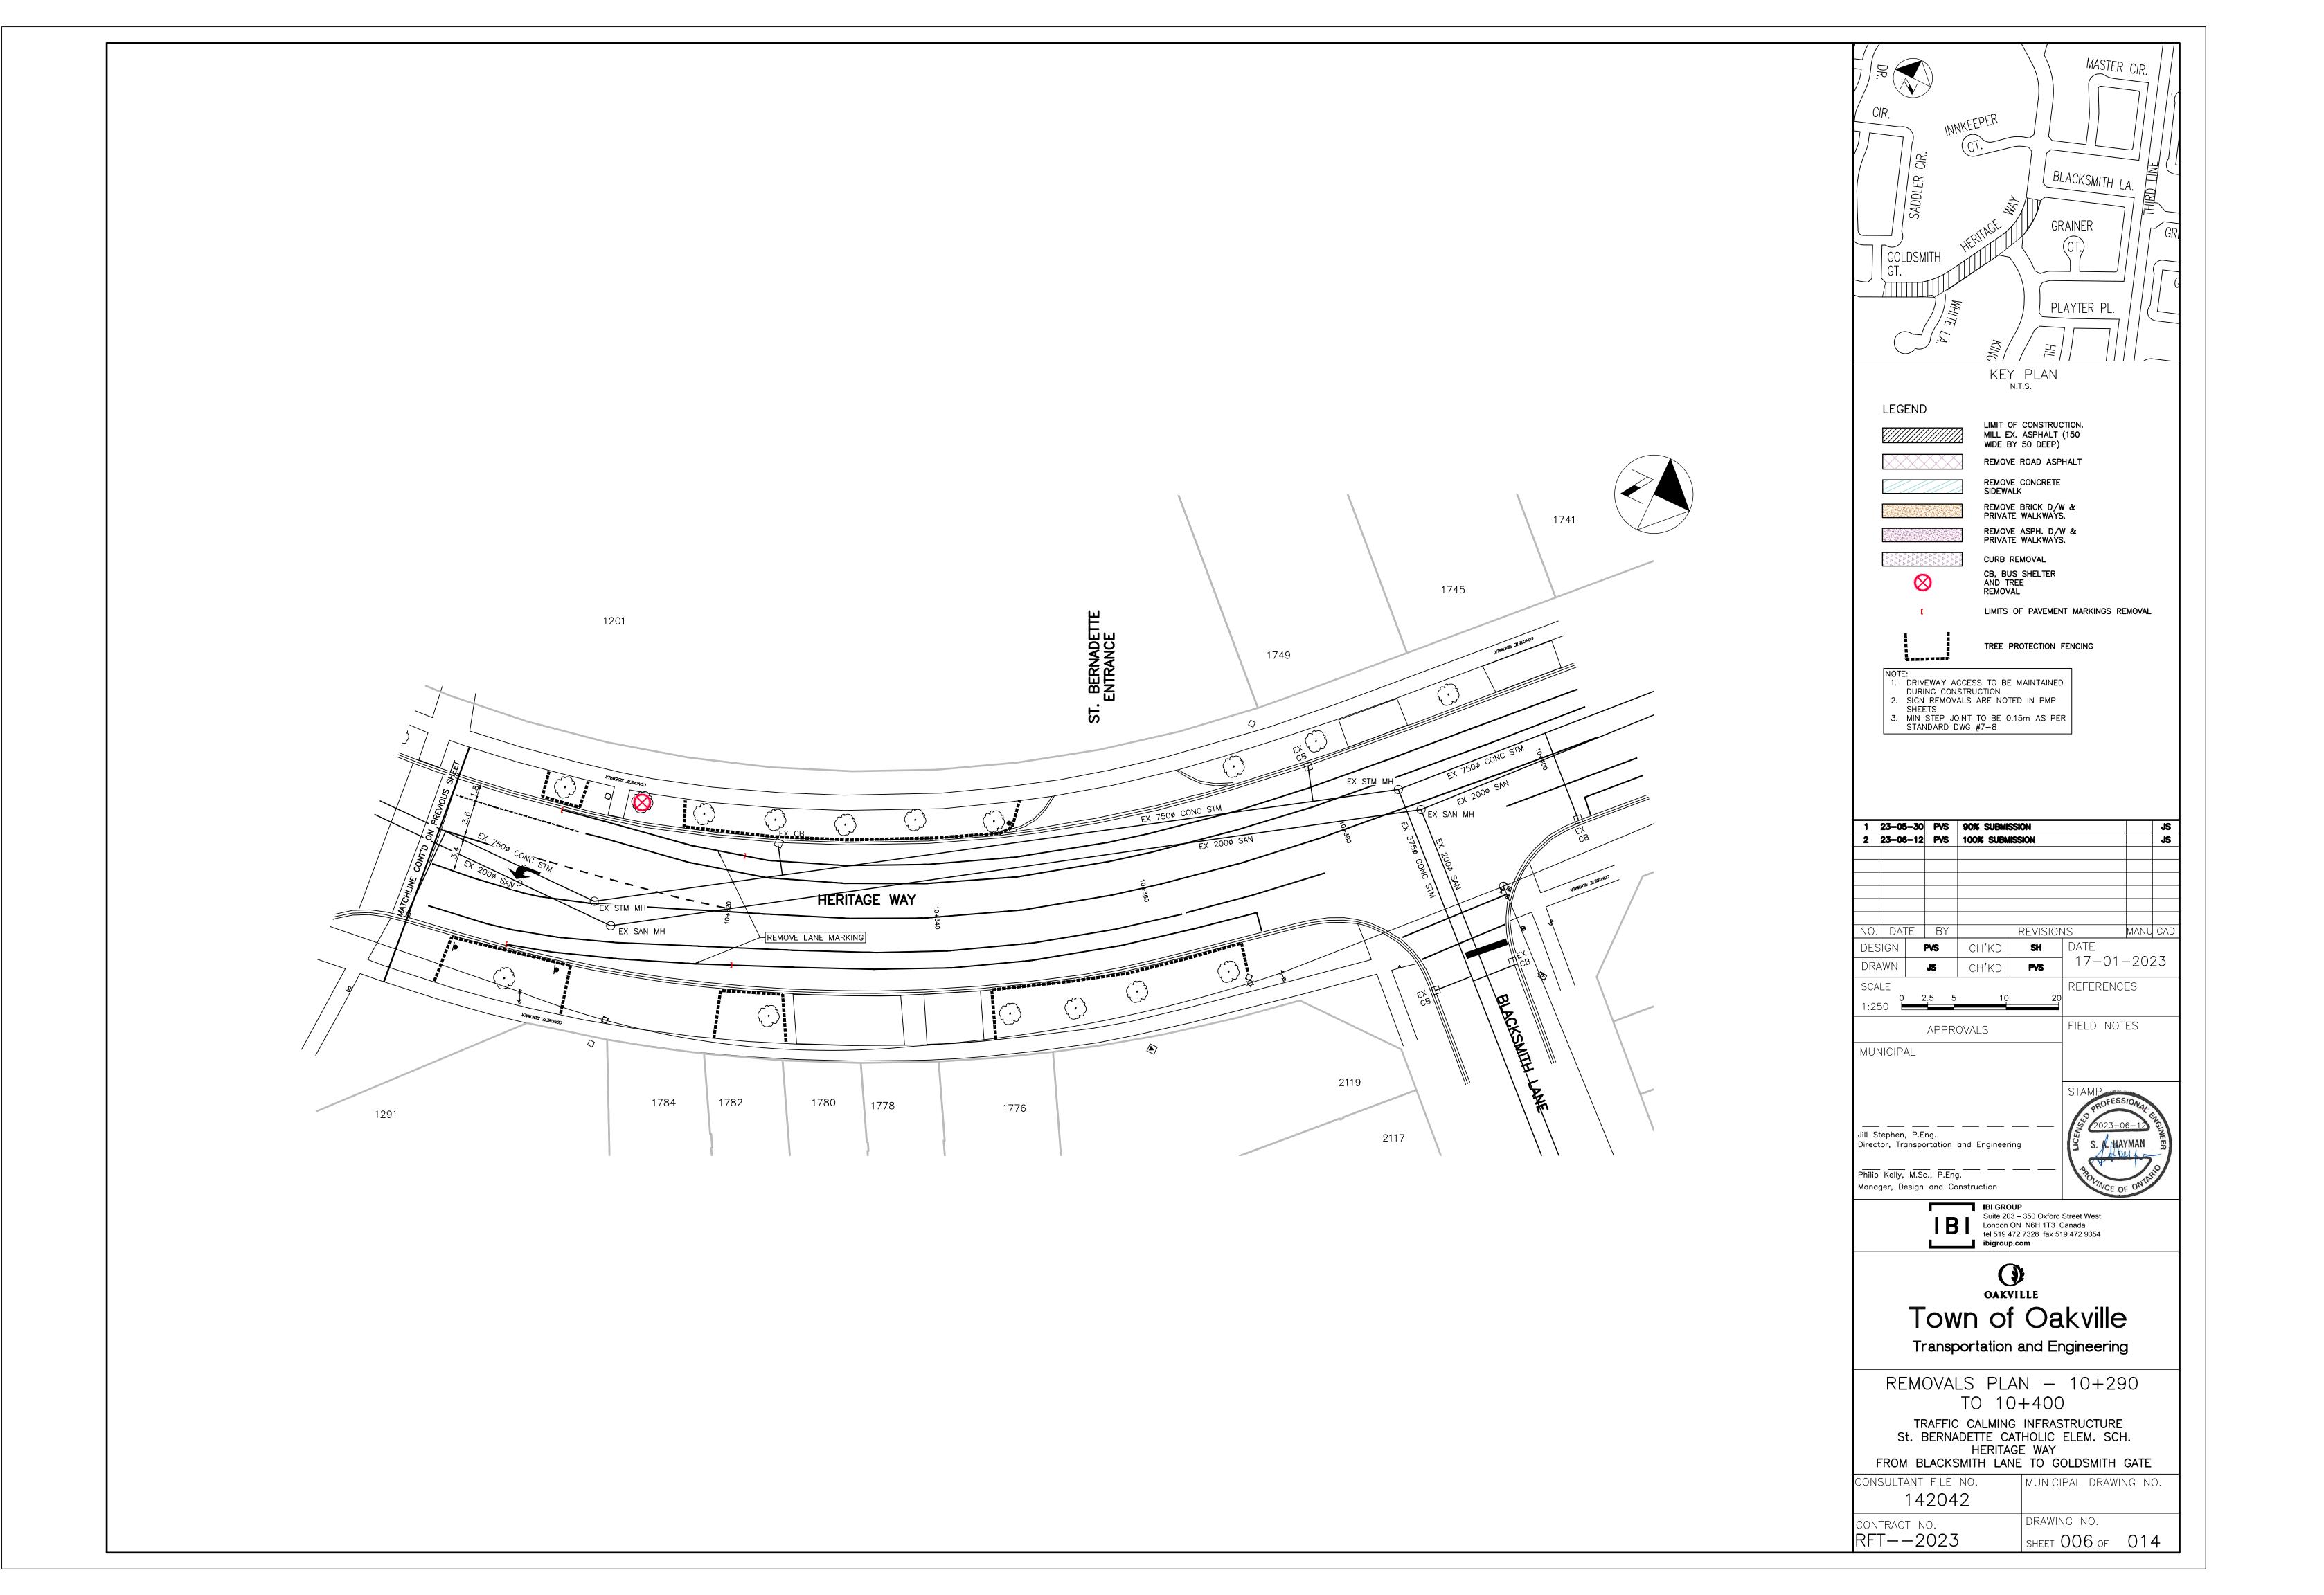


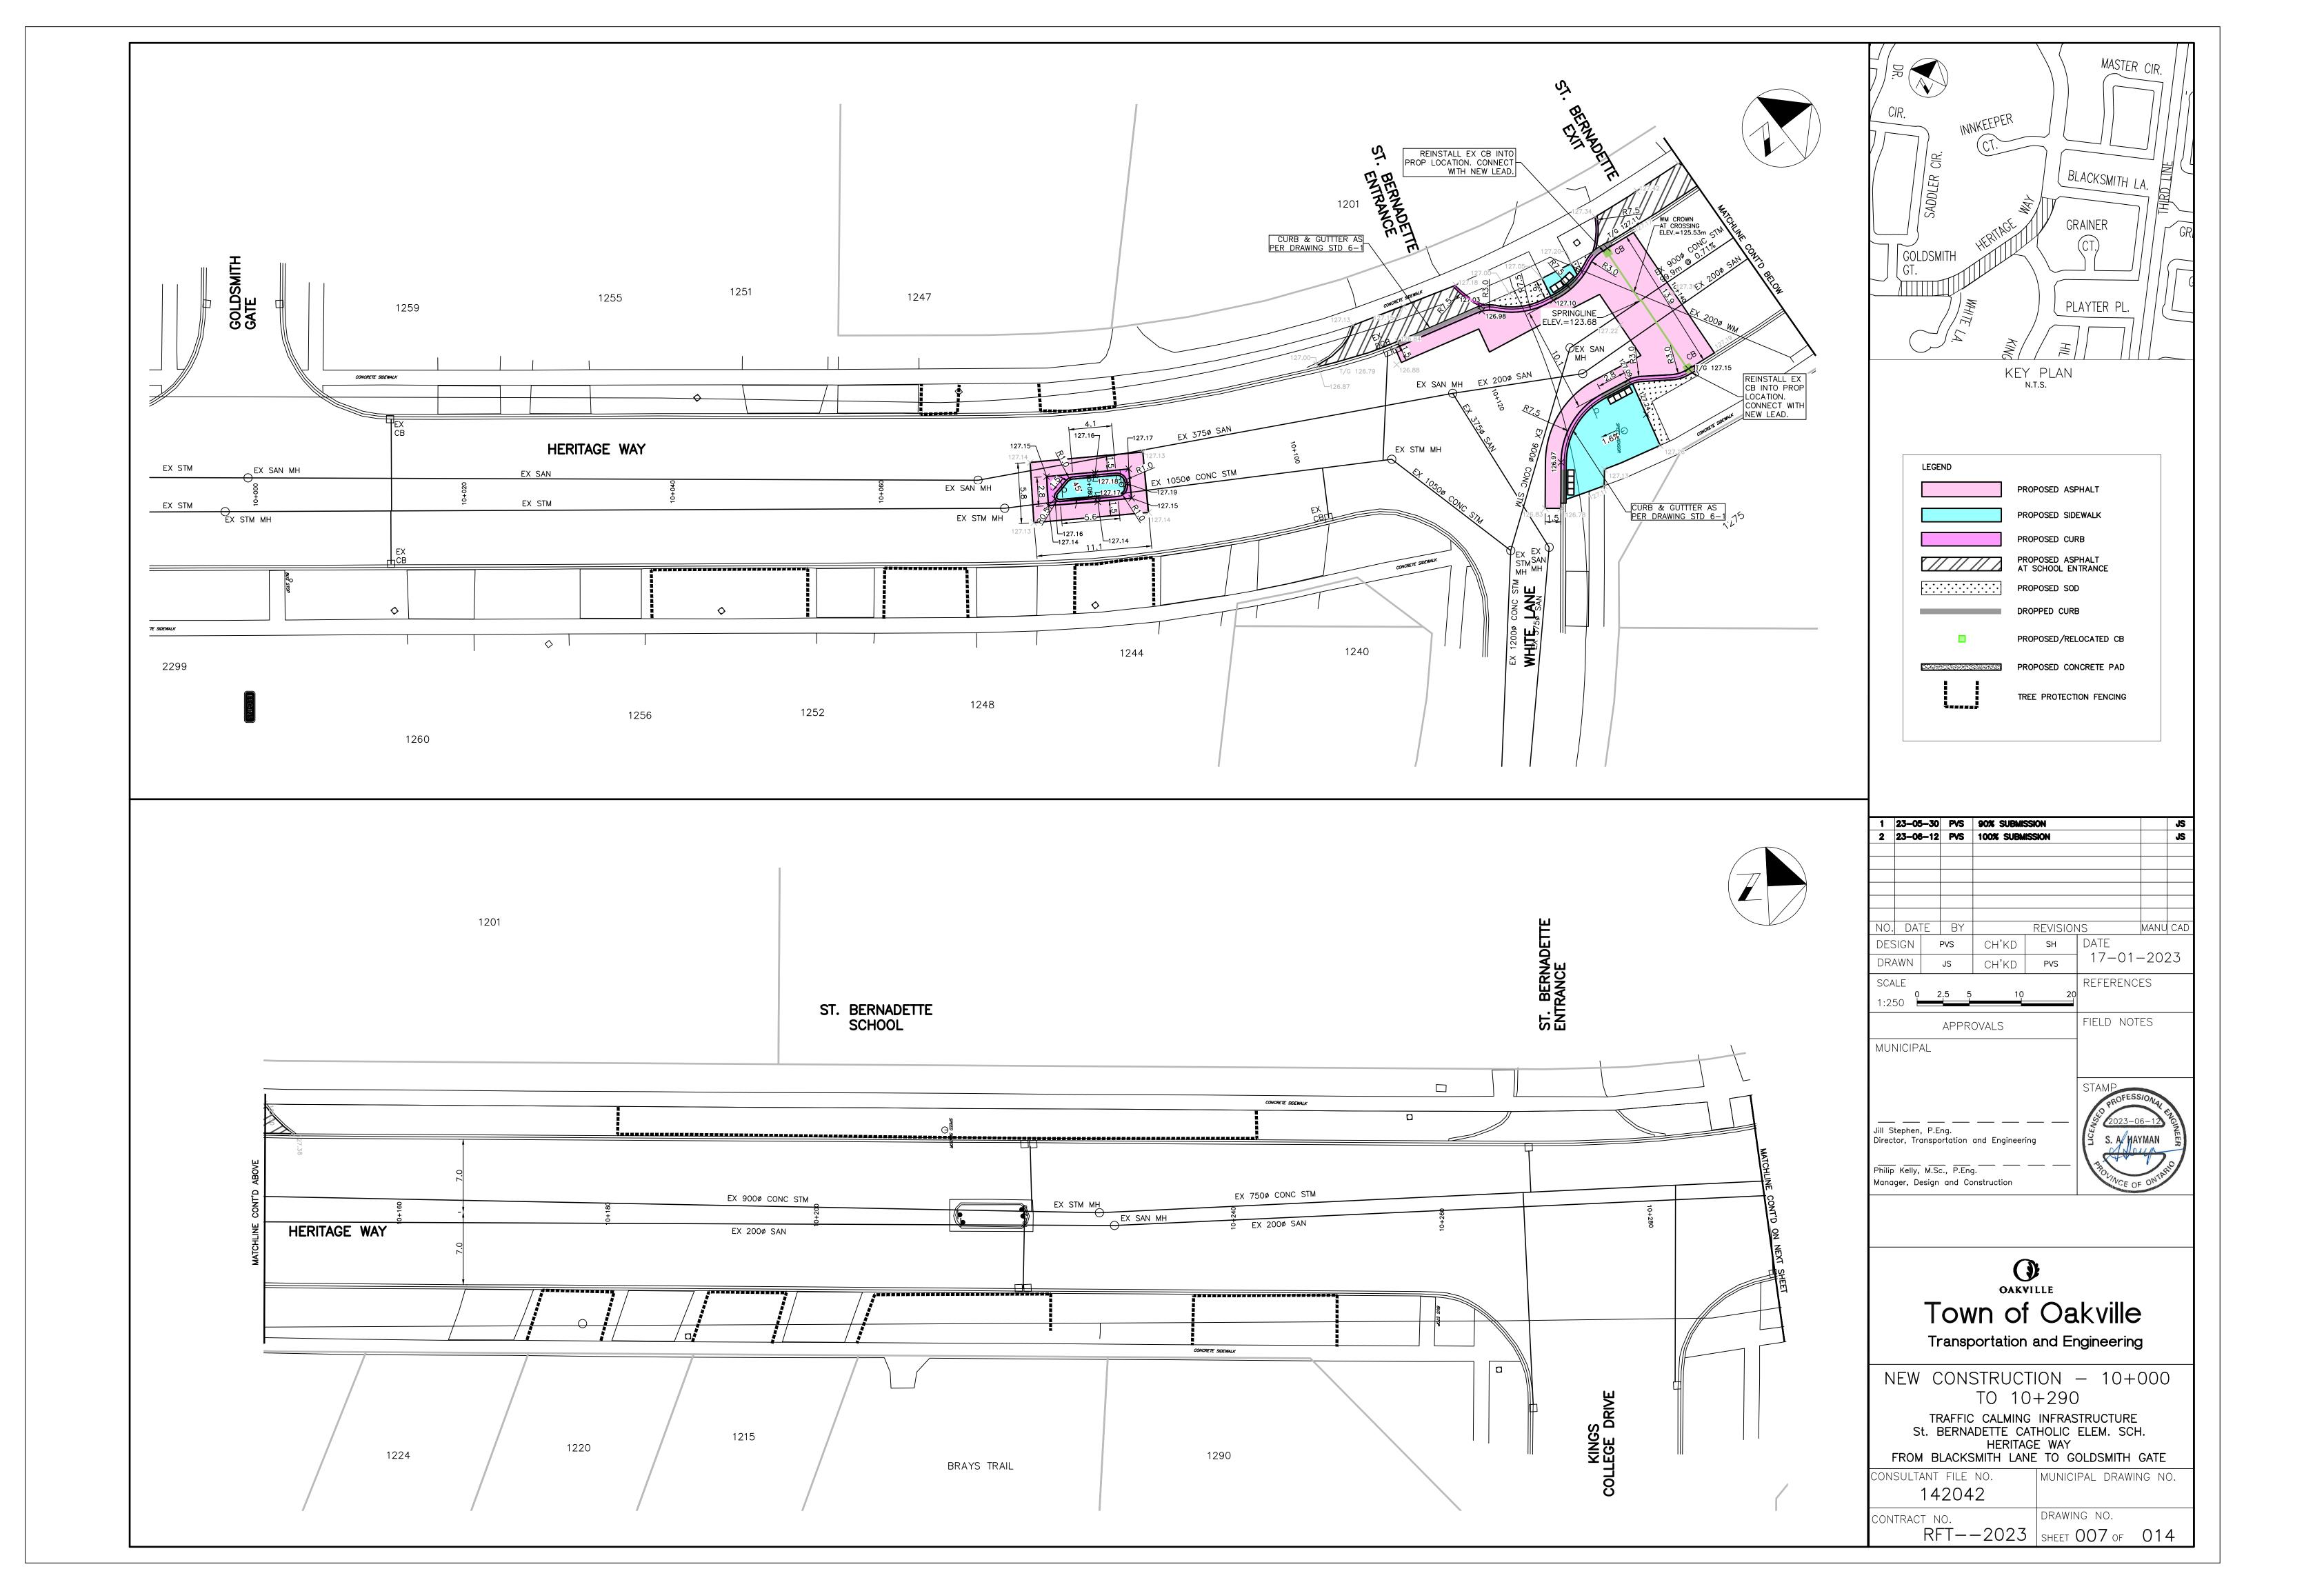

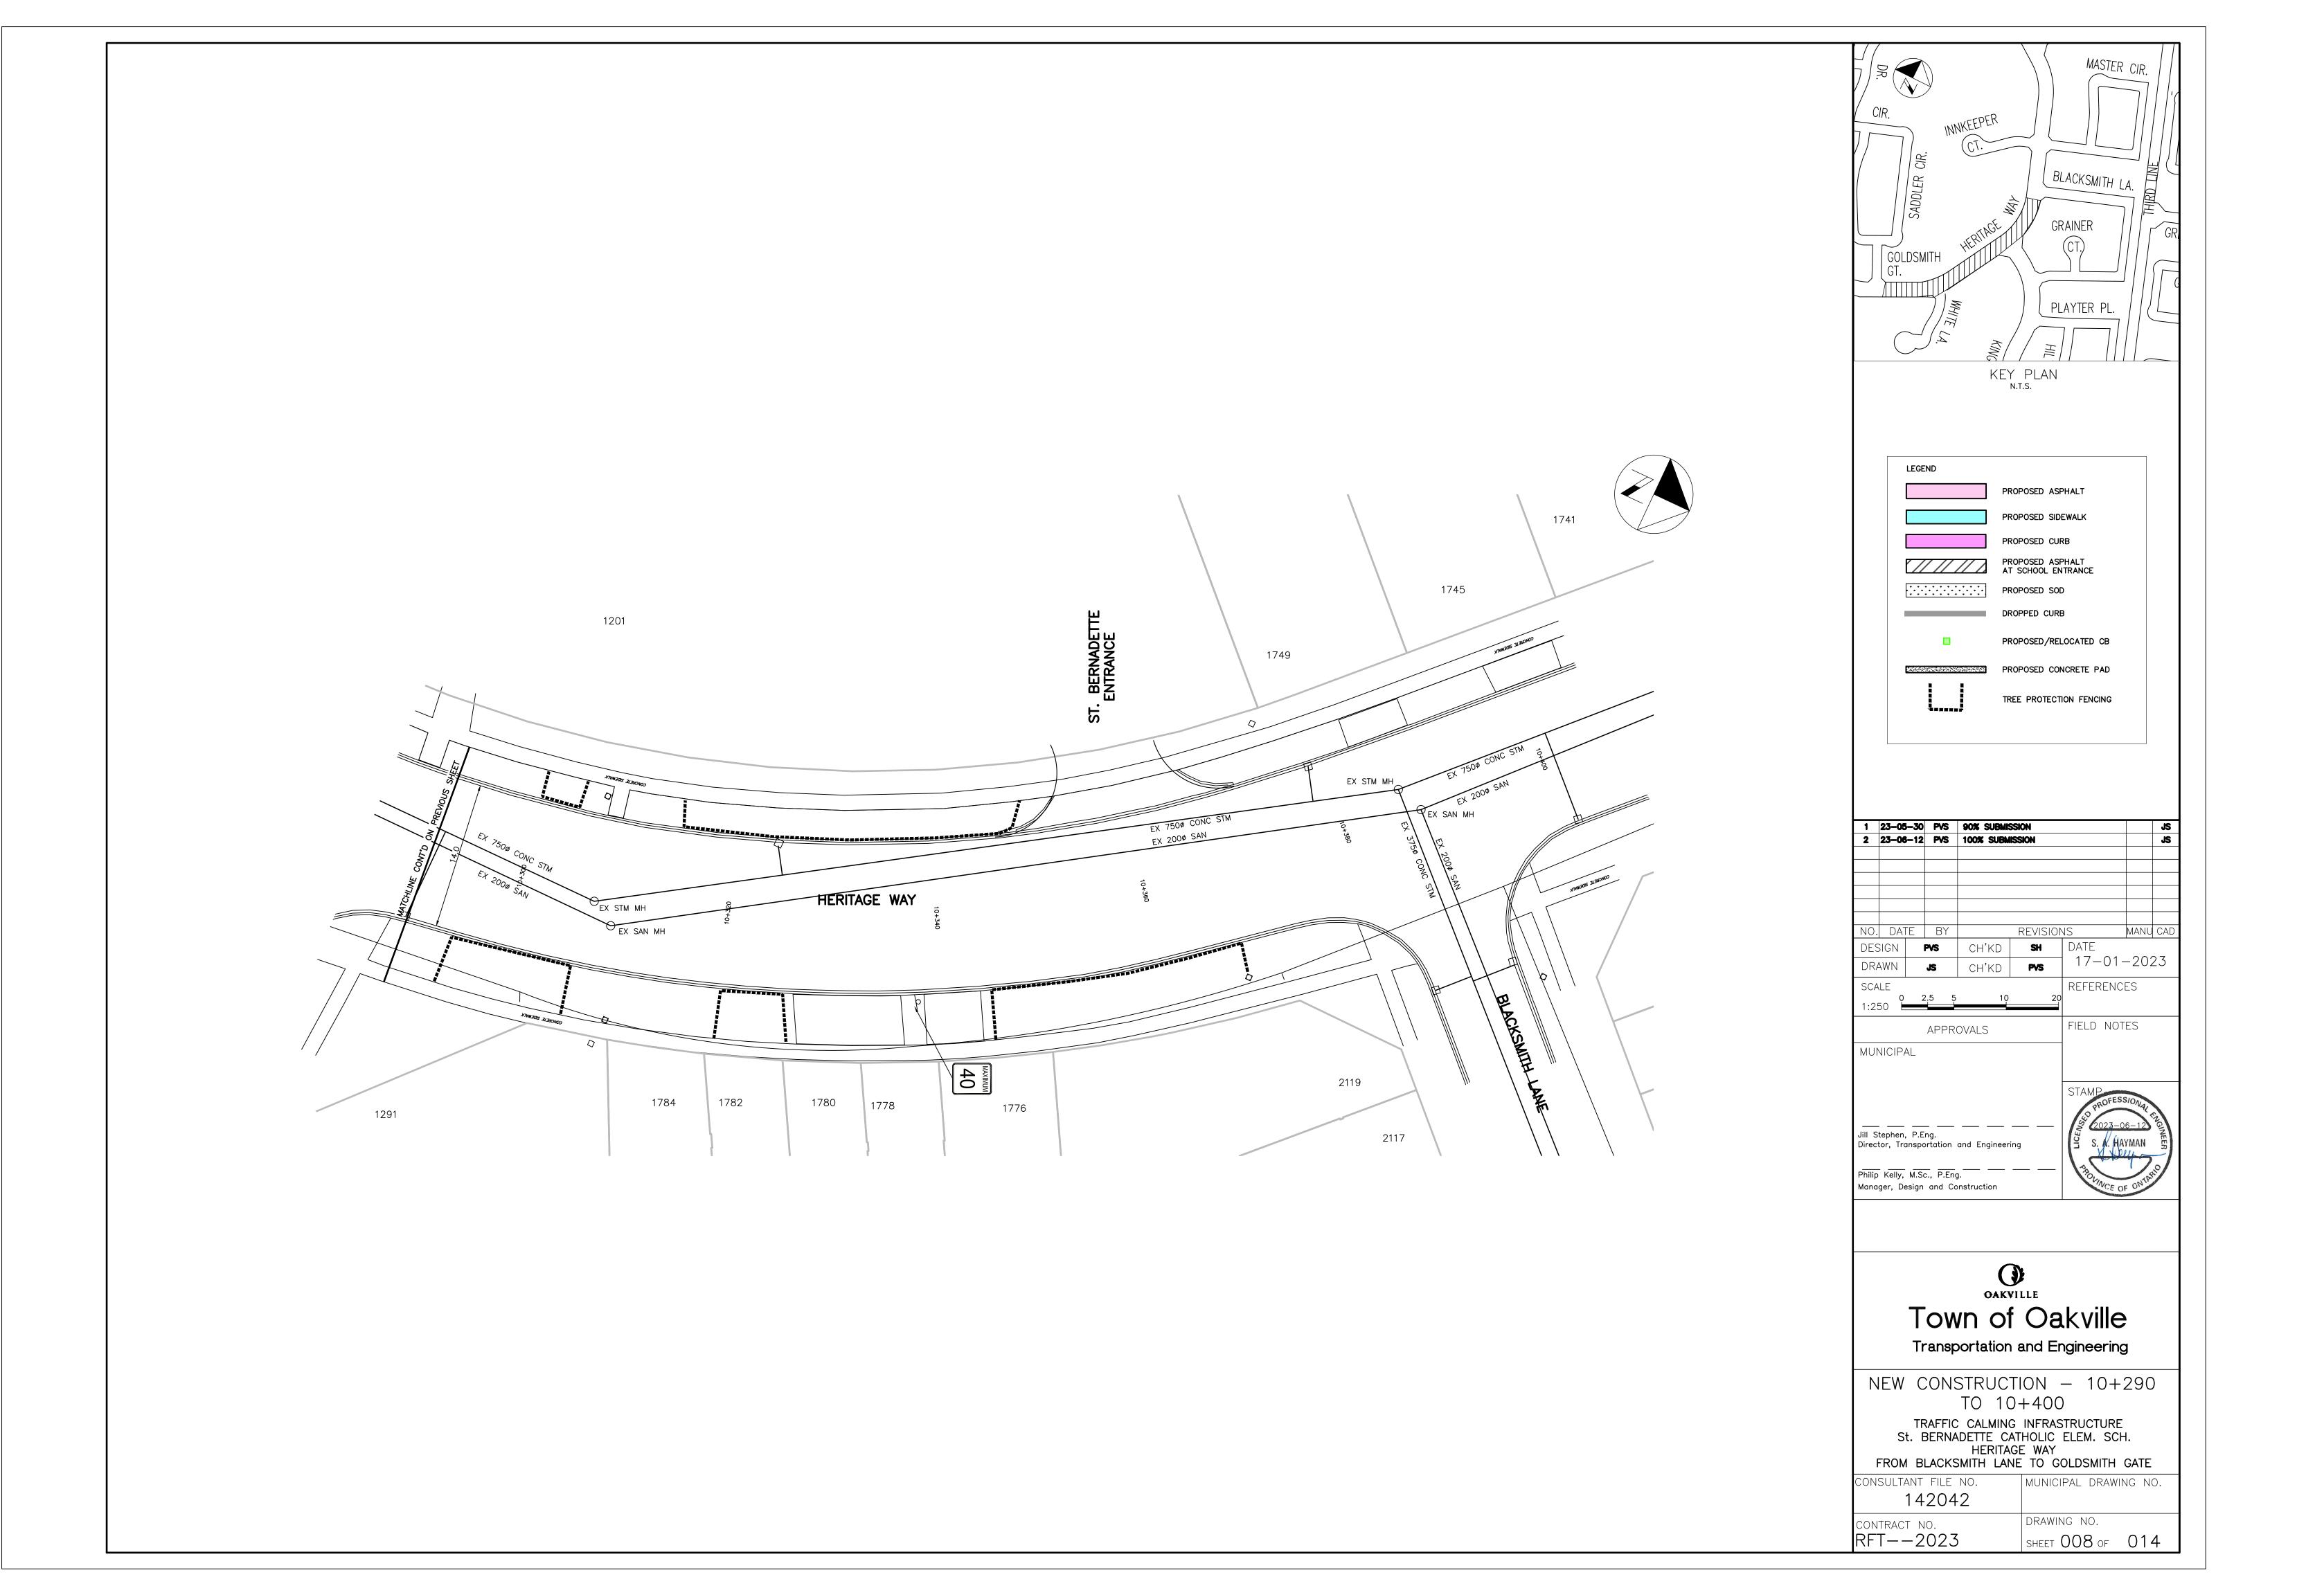

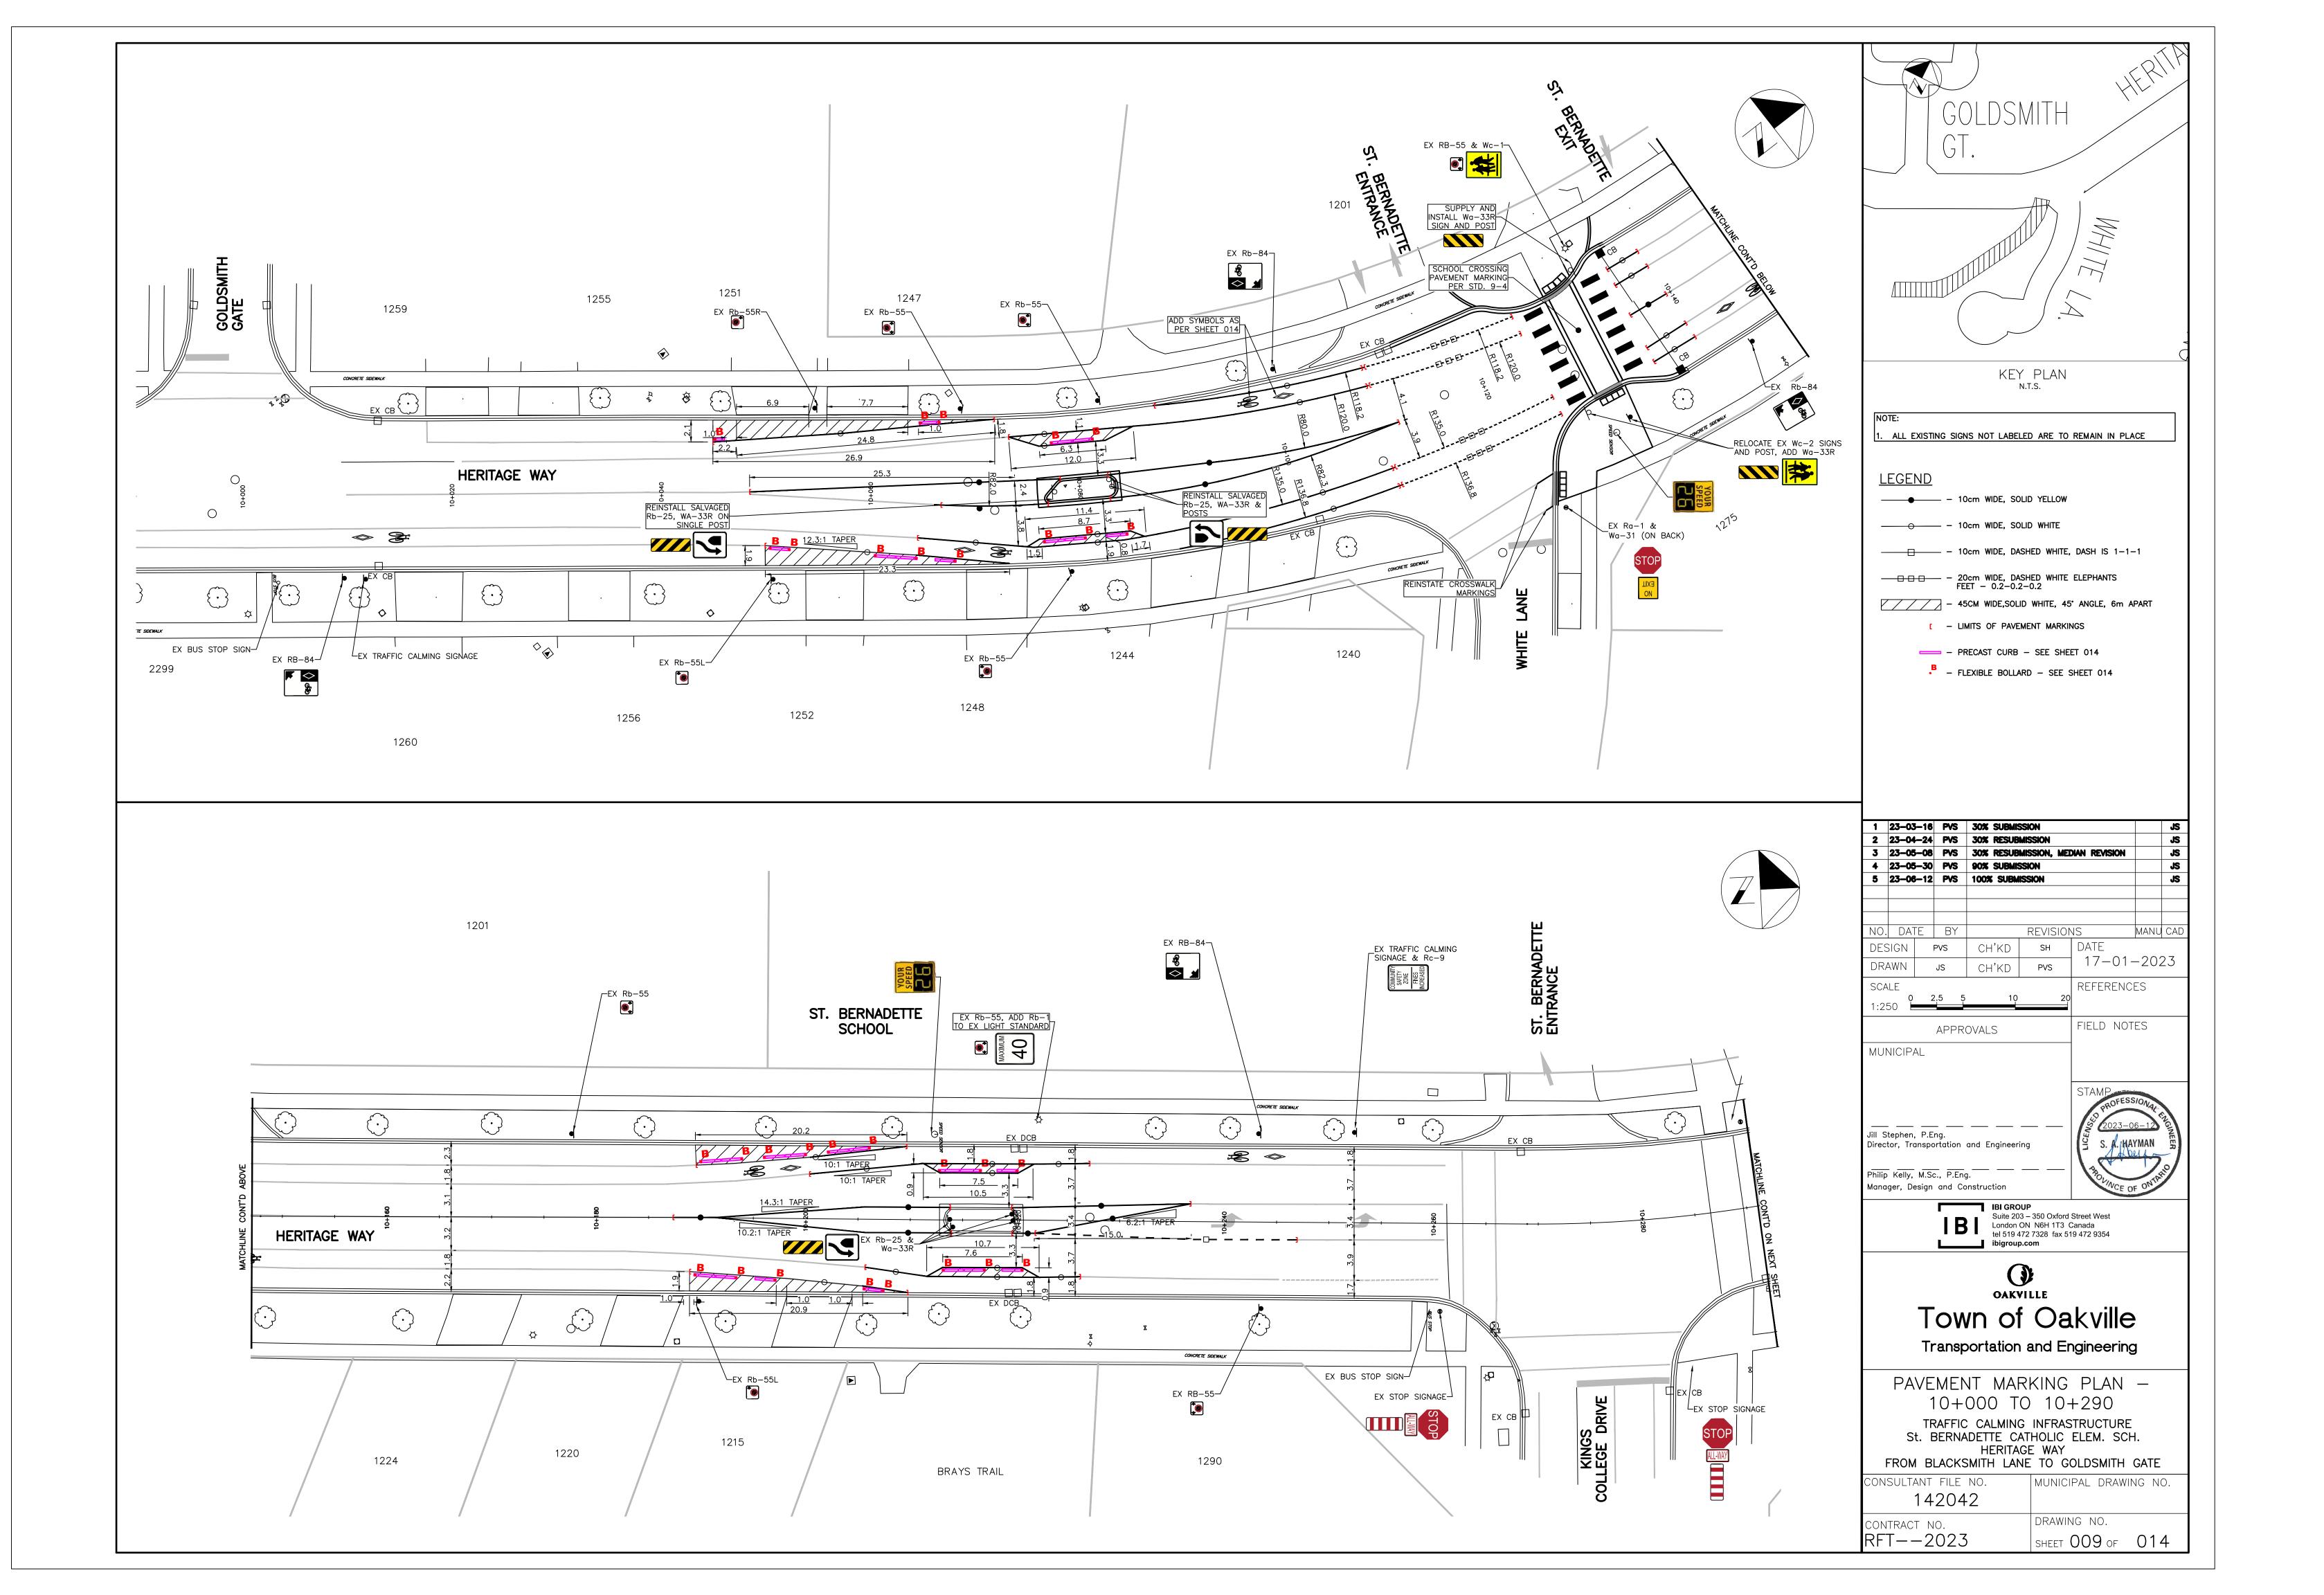

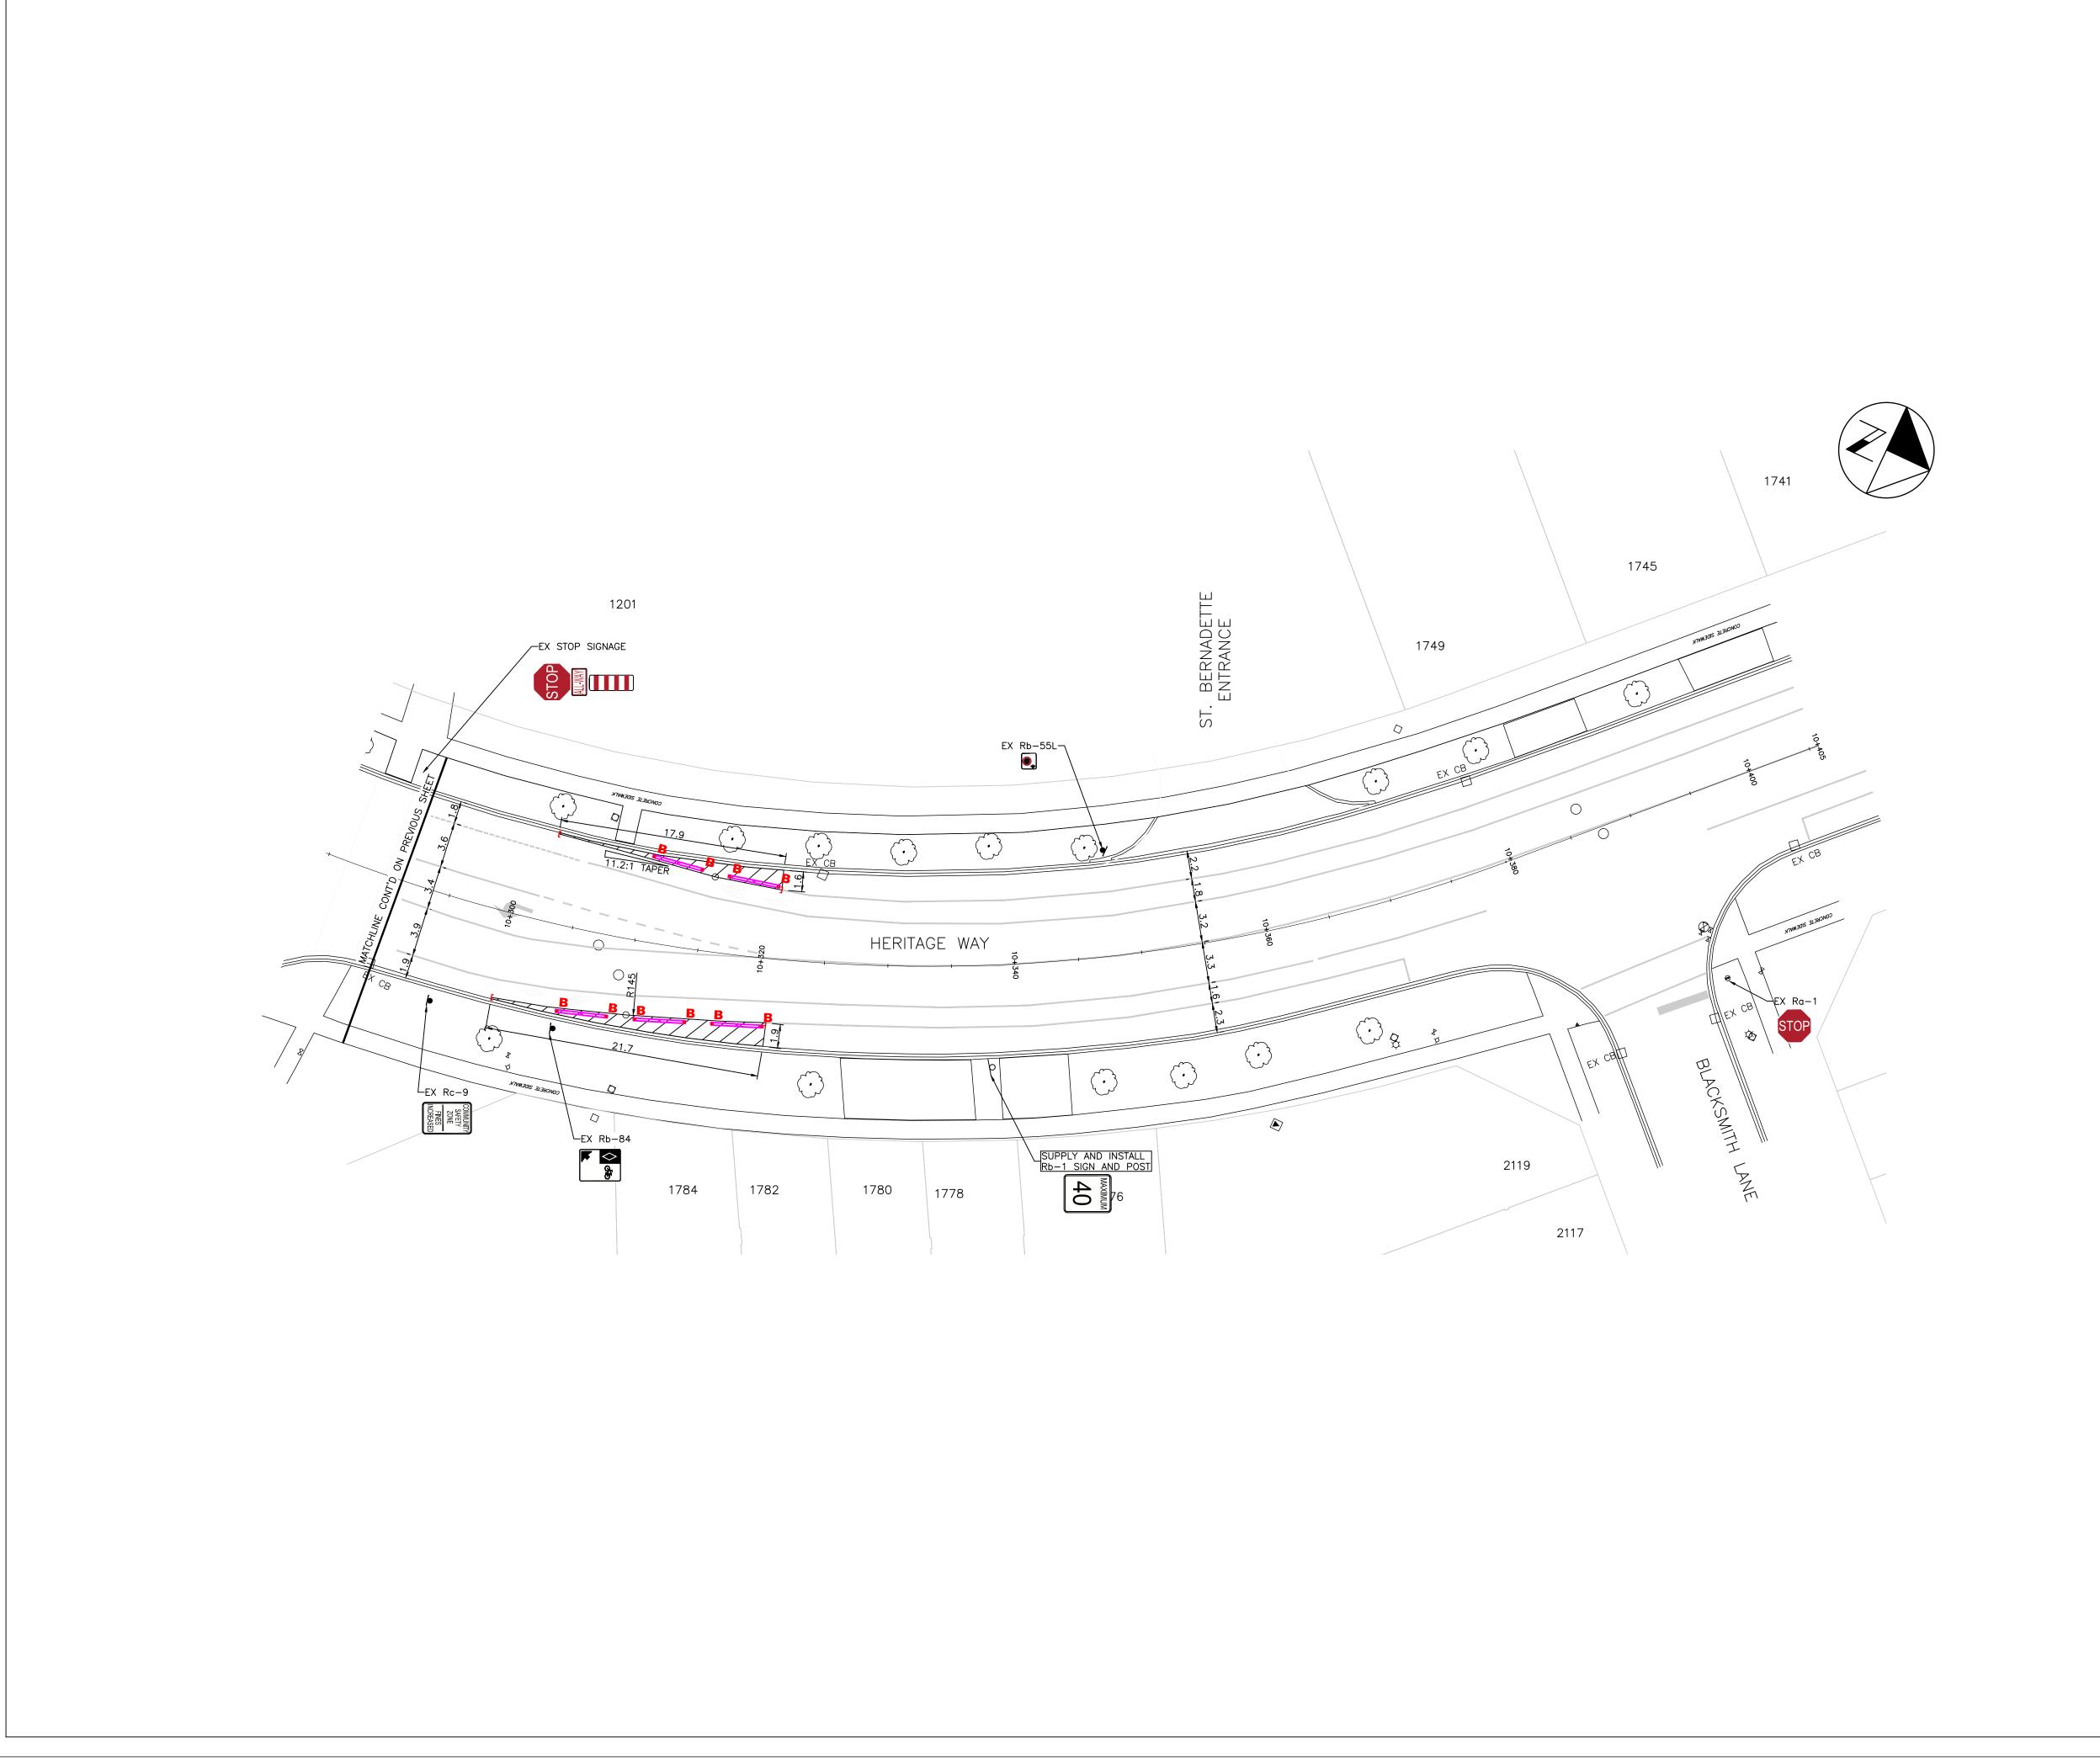

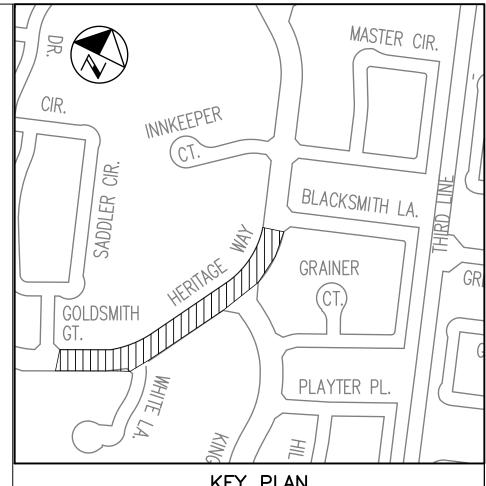

KEY PLAN

NOTE:

1. ALL EXISTING SIGNS NOT LABELED ARE TO REMAIN IN PLACE

<u>LEGEND</u>

- – 10cm WIDE, SOLID YELLOW
- → 10cm WIDE, SOLID WHITE

- 45CM WIDE,SOLID WHITE, 45° ANGLE, 6m APART
 - [LIMITS OF PAVEMENT MARKINGS
 - PRECAST CURB SEE SHEET 014
 - .B FLEXIBLE BOLLARD SEE SHEET 014

1	23-03	3-16	PVS	30% SUBMIS	30% SUBMISSION							
2	23-04	l-24	PVS	30% RESUB	MISSION			JS				
3	23-05	5-08	PVS	30% RESUB	MISSION, ME	DIAN REVISION		JS				
4	23-05	5-30	PVS	90% SUBMIS	SSION			JS				
5	23-06	5–12	PVS	100% SUBM	ISSION			JS				
NO.	DA	ΓE	BY		REVISION	NS .	MANU	CAD				
DES	SIGN		PVS	CH'KD	SH	DATE						
DRAWN			JS	CH'KD	17–01-	-202	23					
SCA	LE			10	0.0	REFERENC	ES					
1:25	50 E		2.5 5	10								

APPROVALS

MUNICIPAL

Jill Stephen, P.Eng.

Director, Transportation and Engineering

Philip Kelly, M.Sc., P.Eng.

Manager, Design and Construction

IBI GROUP
Suite 203 – 350 Oxford Street West London ON N6H 1T3 Canada tel 519 472 7328 fax 519 472 9354 ibigroup.com



Town of Oakville

Transportation and Engineering

PAVEMENT MARKING PLAN — 10+290 TO 10+400 TRAFFIC CALMING INFRASTRUCTURE

TRAFFIC CALMING INFRASTRUCTURE St. BERNADETTE CATHOLIC ELEM. SCH. HERITAGE WAY

FROM BLACKSMITH LANE TO GOLDSMITH GATE

CONSULTANT FILE NO. MUNICIPAL DRAWING NO.


142042 ACT NO. DRAWING NO.


CONTRACT NO.


RFT--2023 DRAWING NO.


SHEET 010 of 014


FIELD NOTES

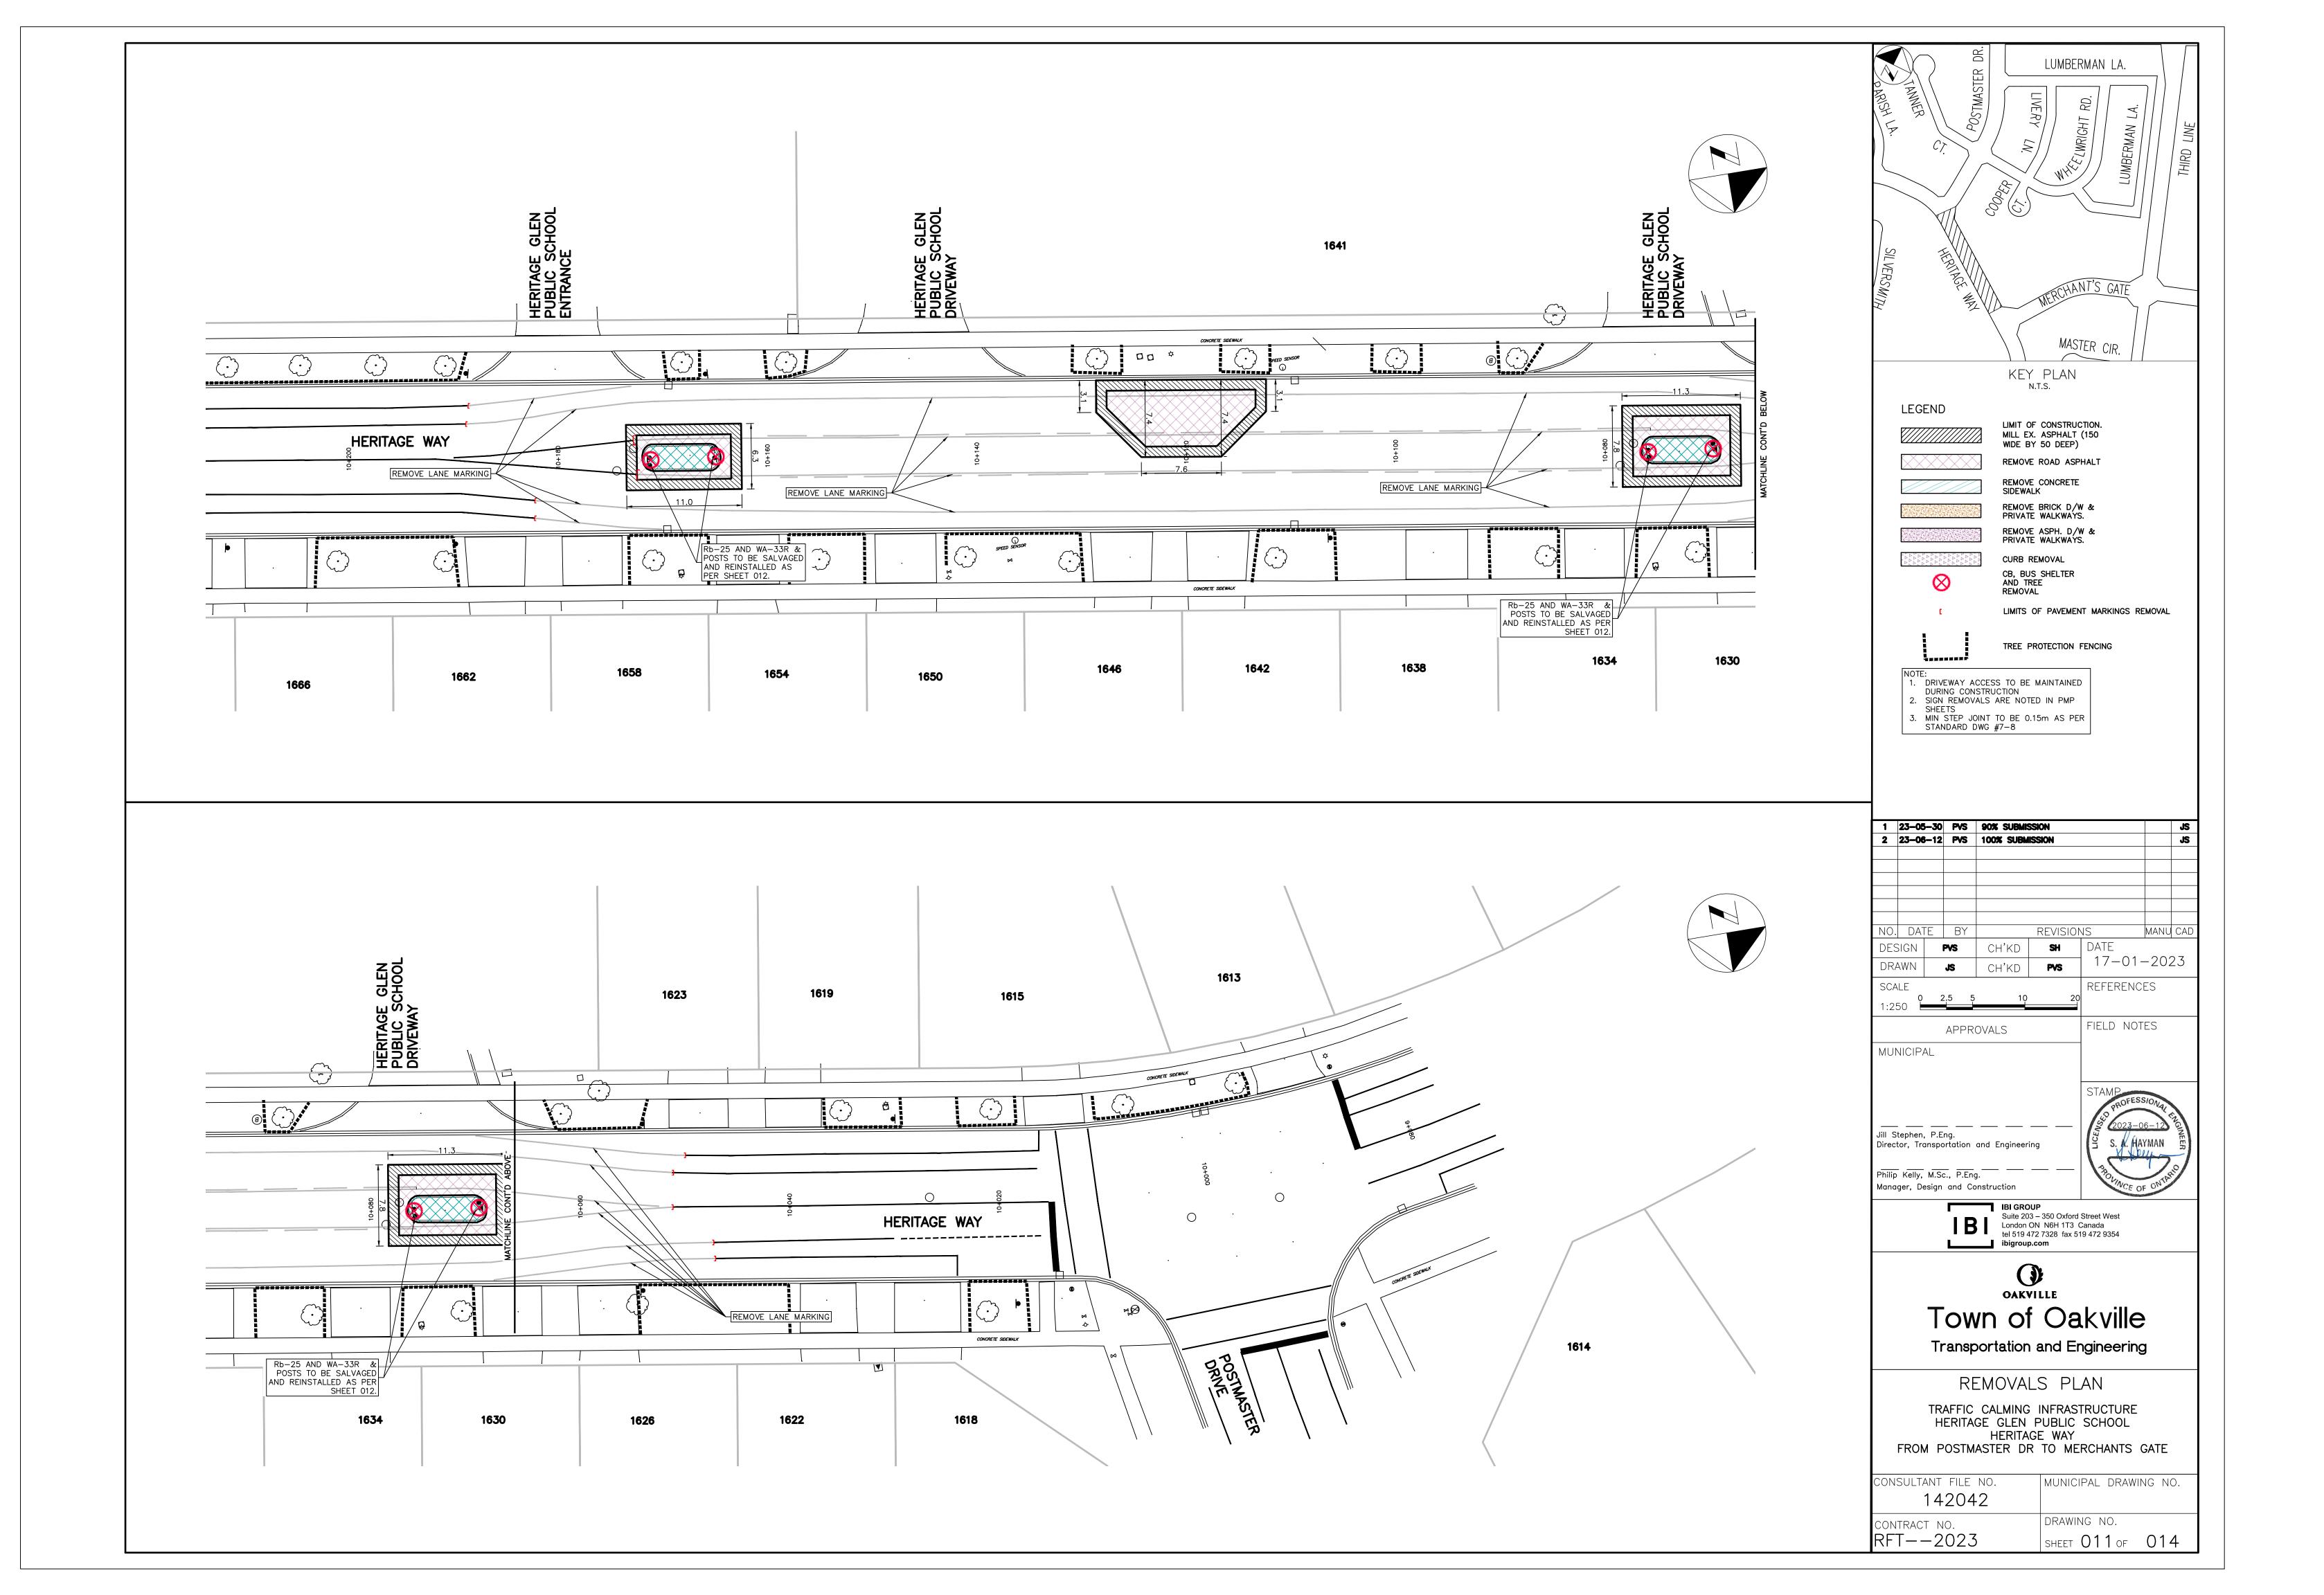

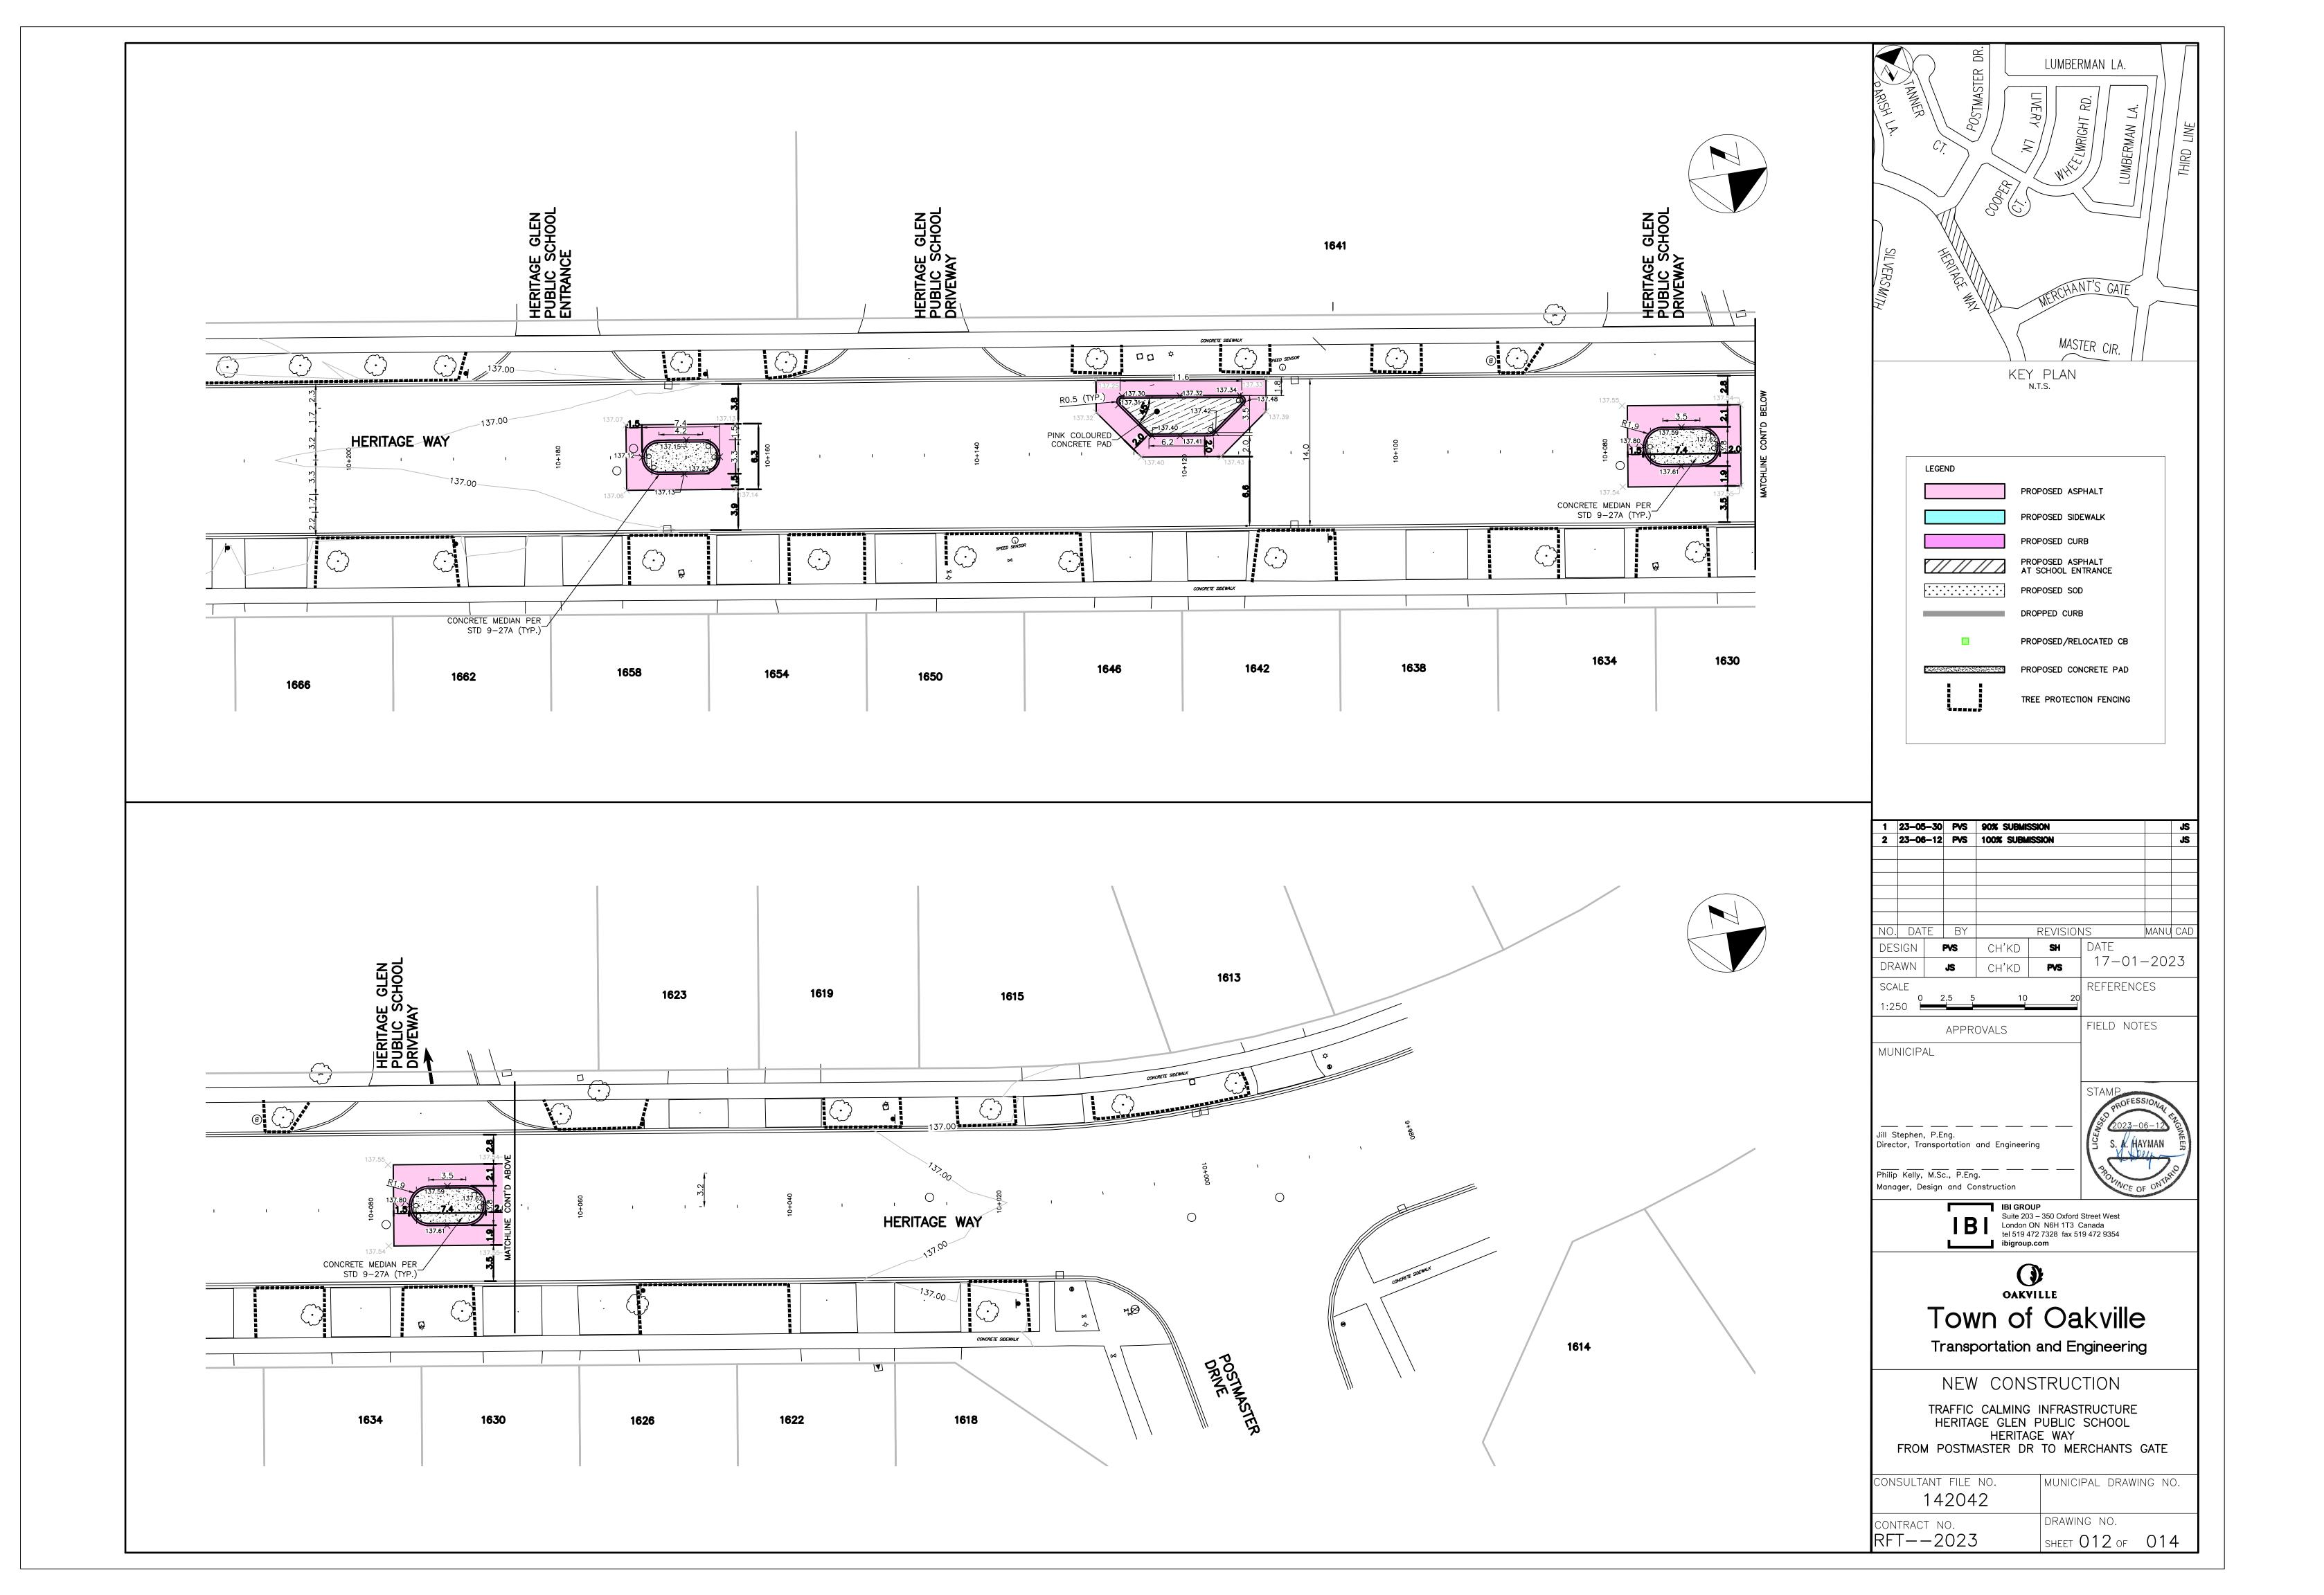


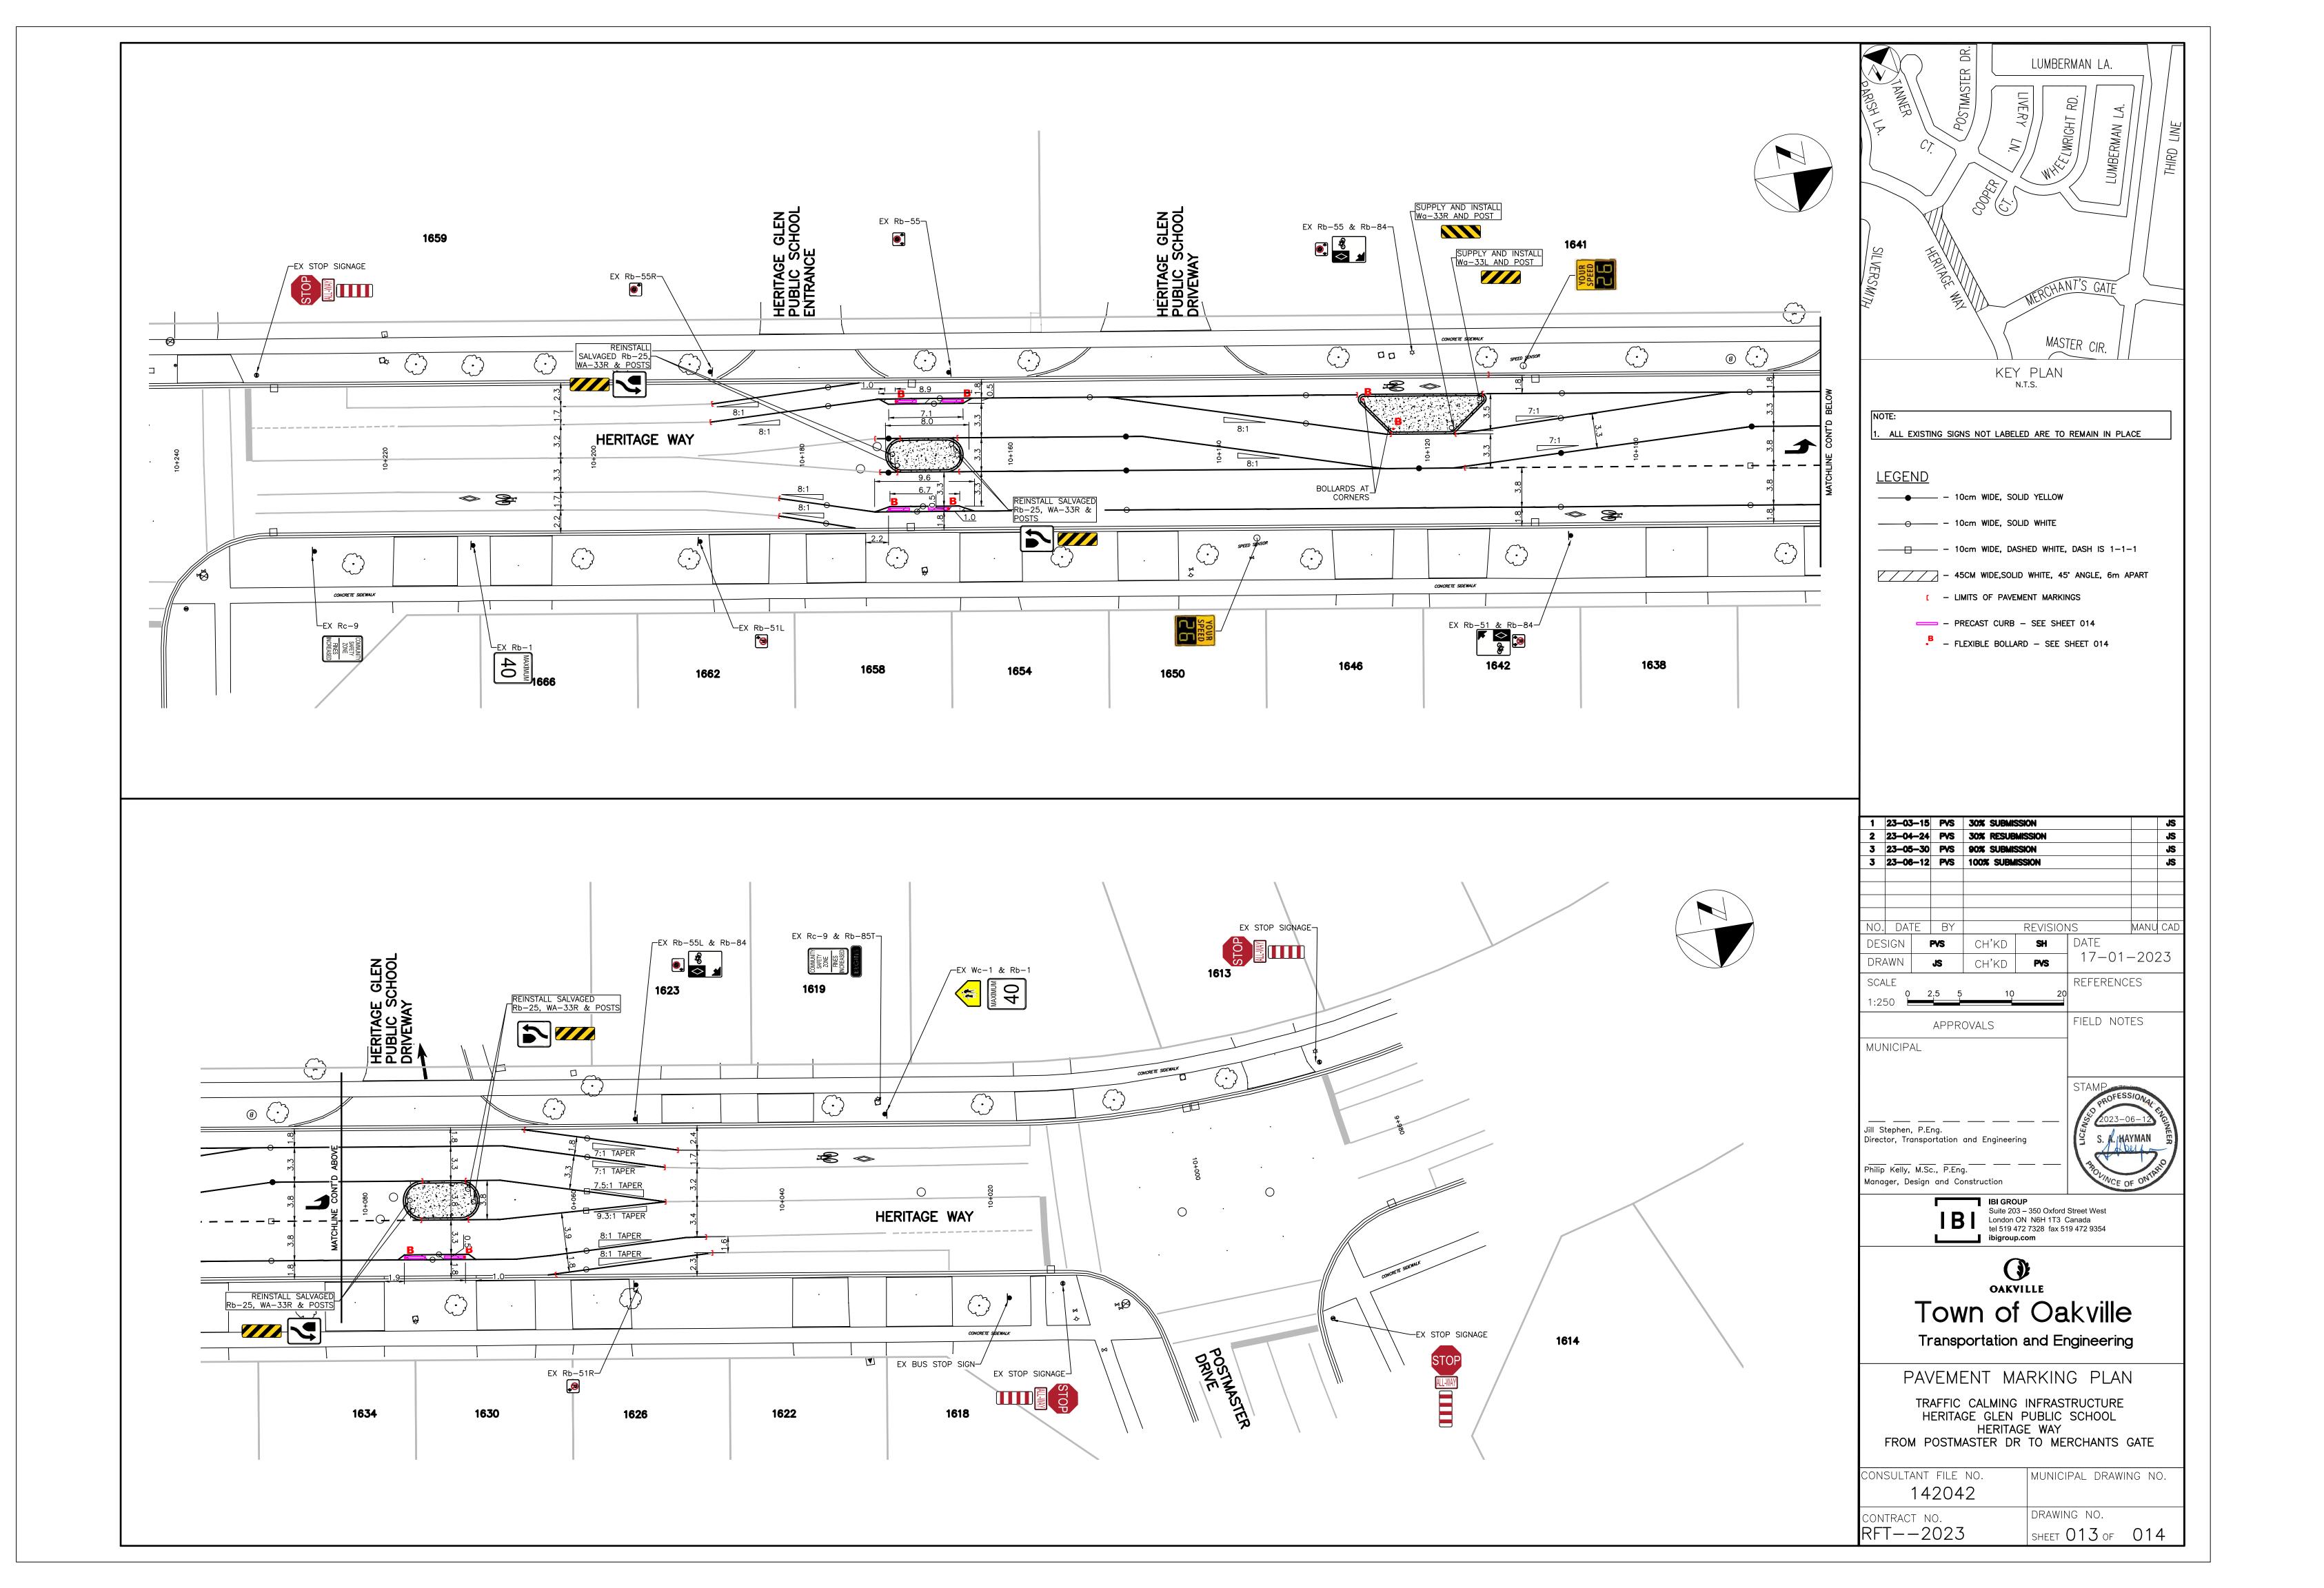

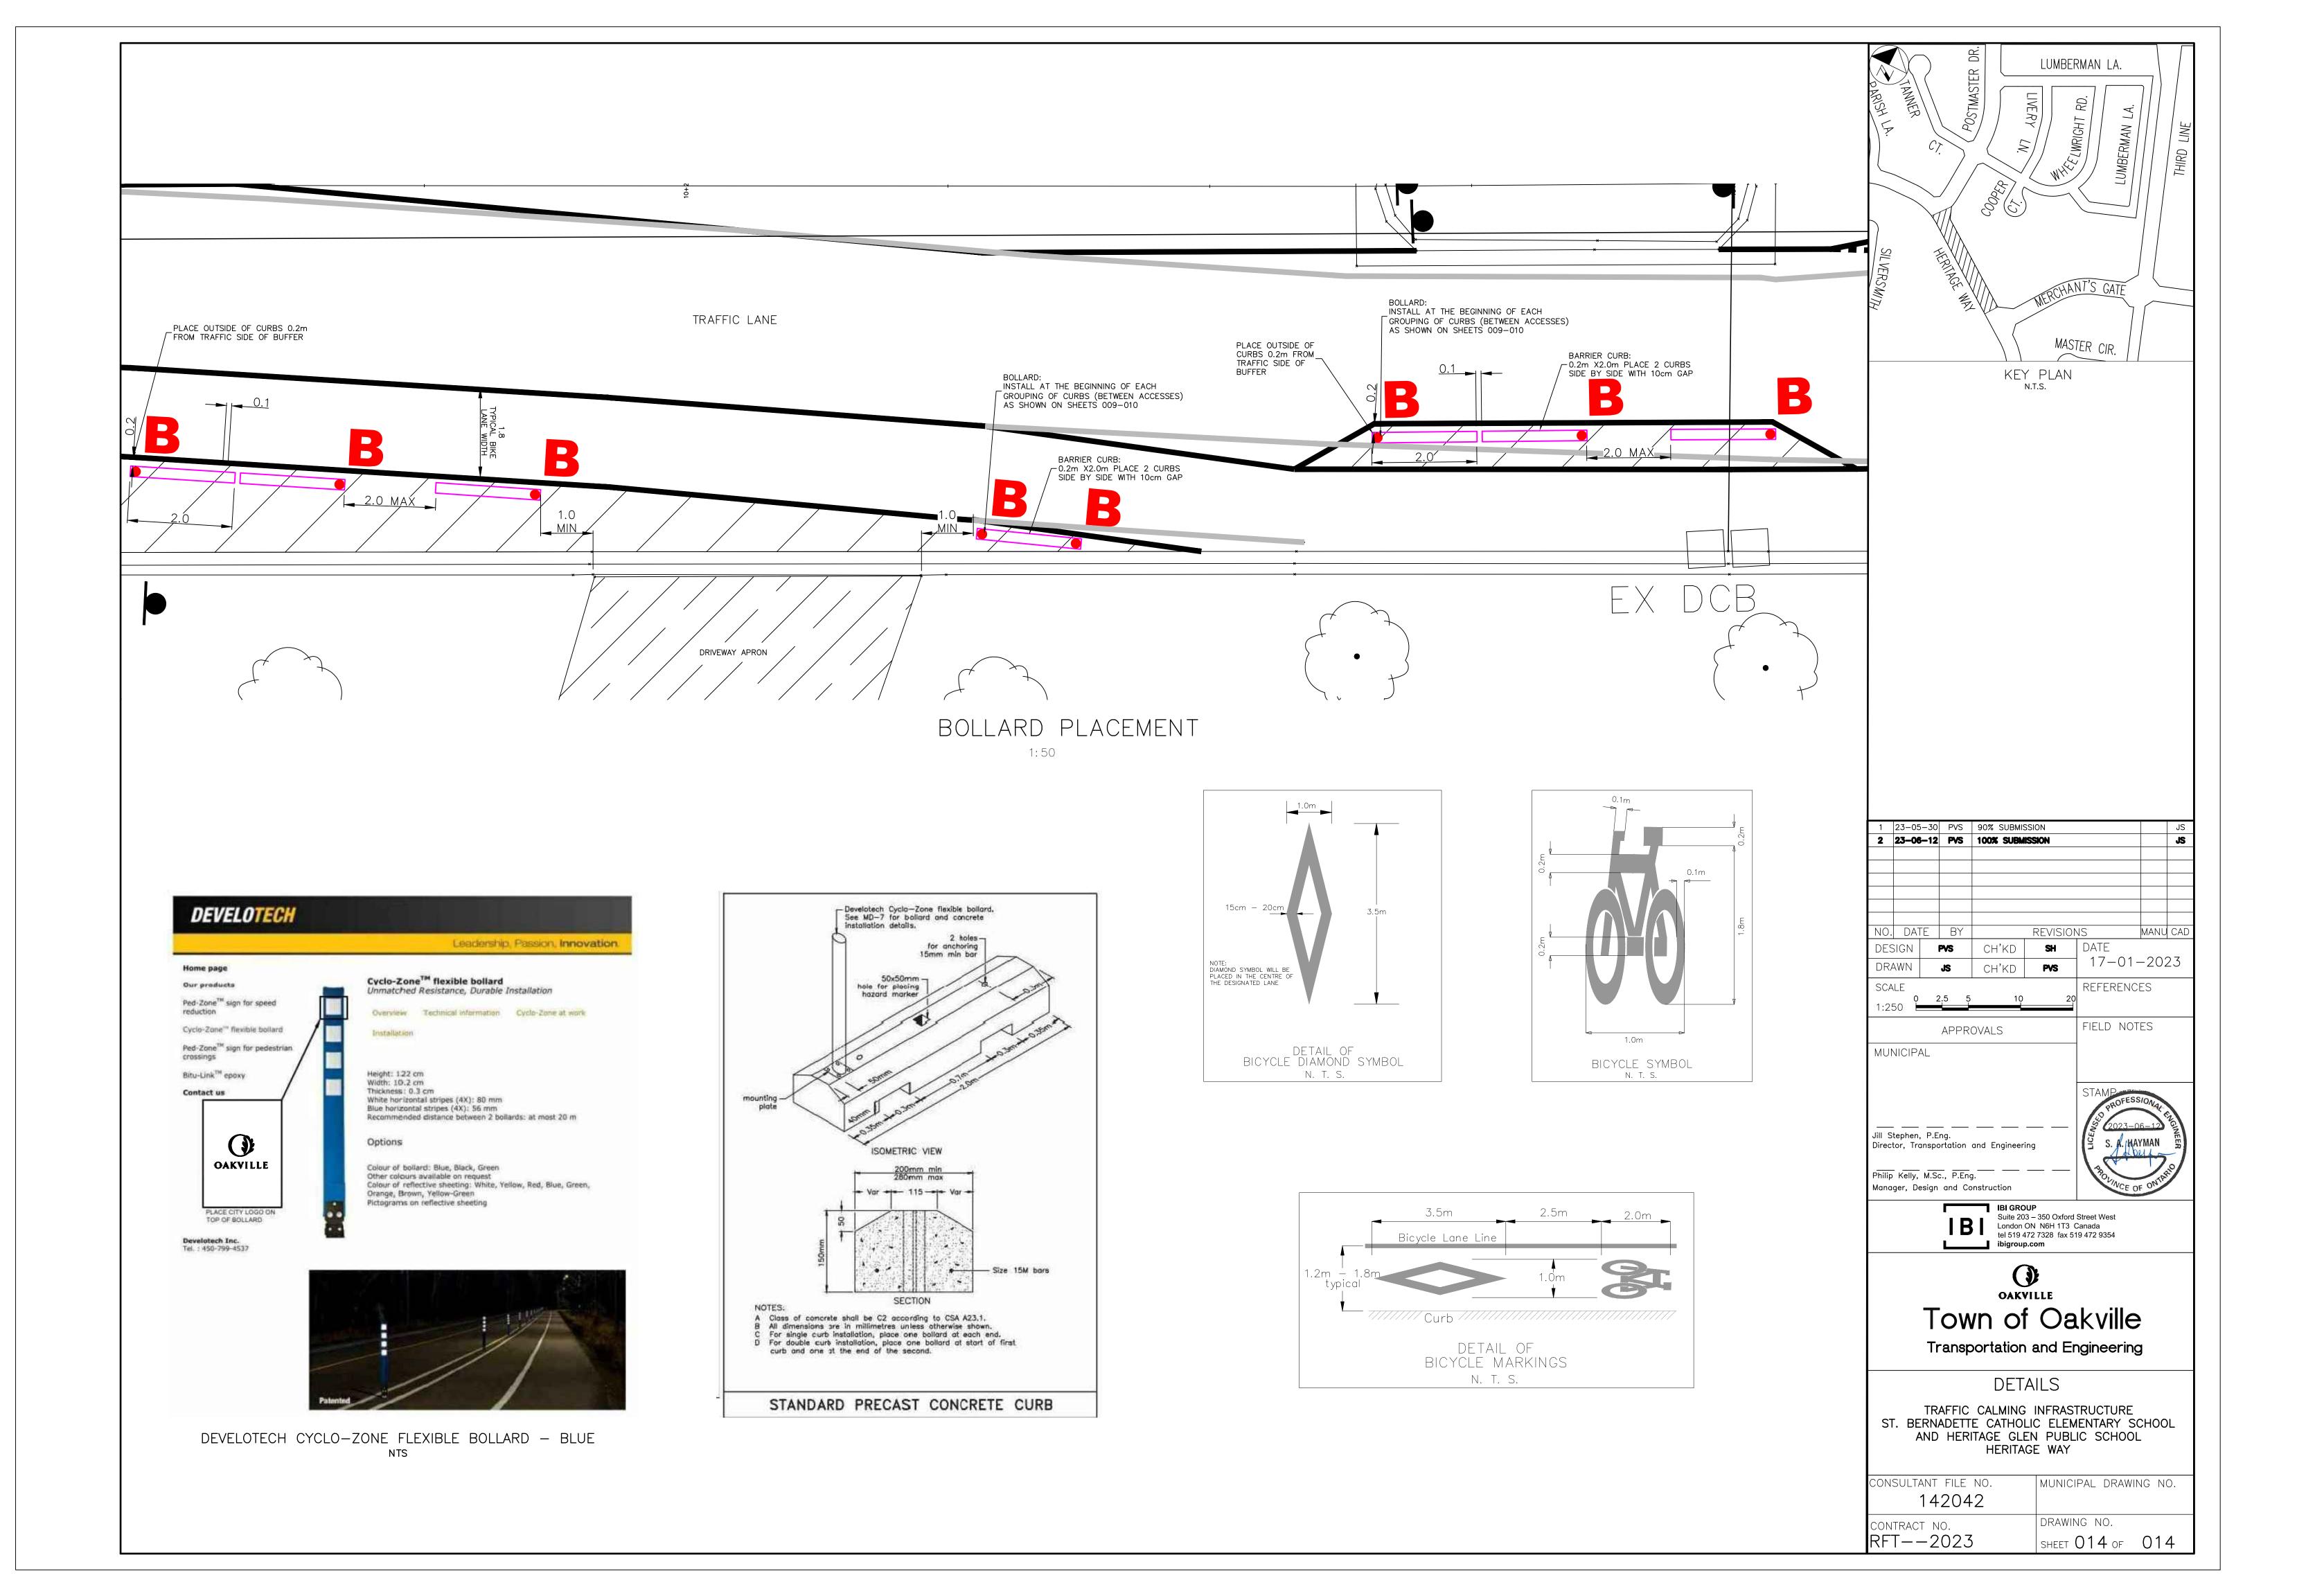

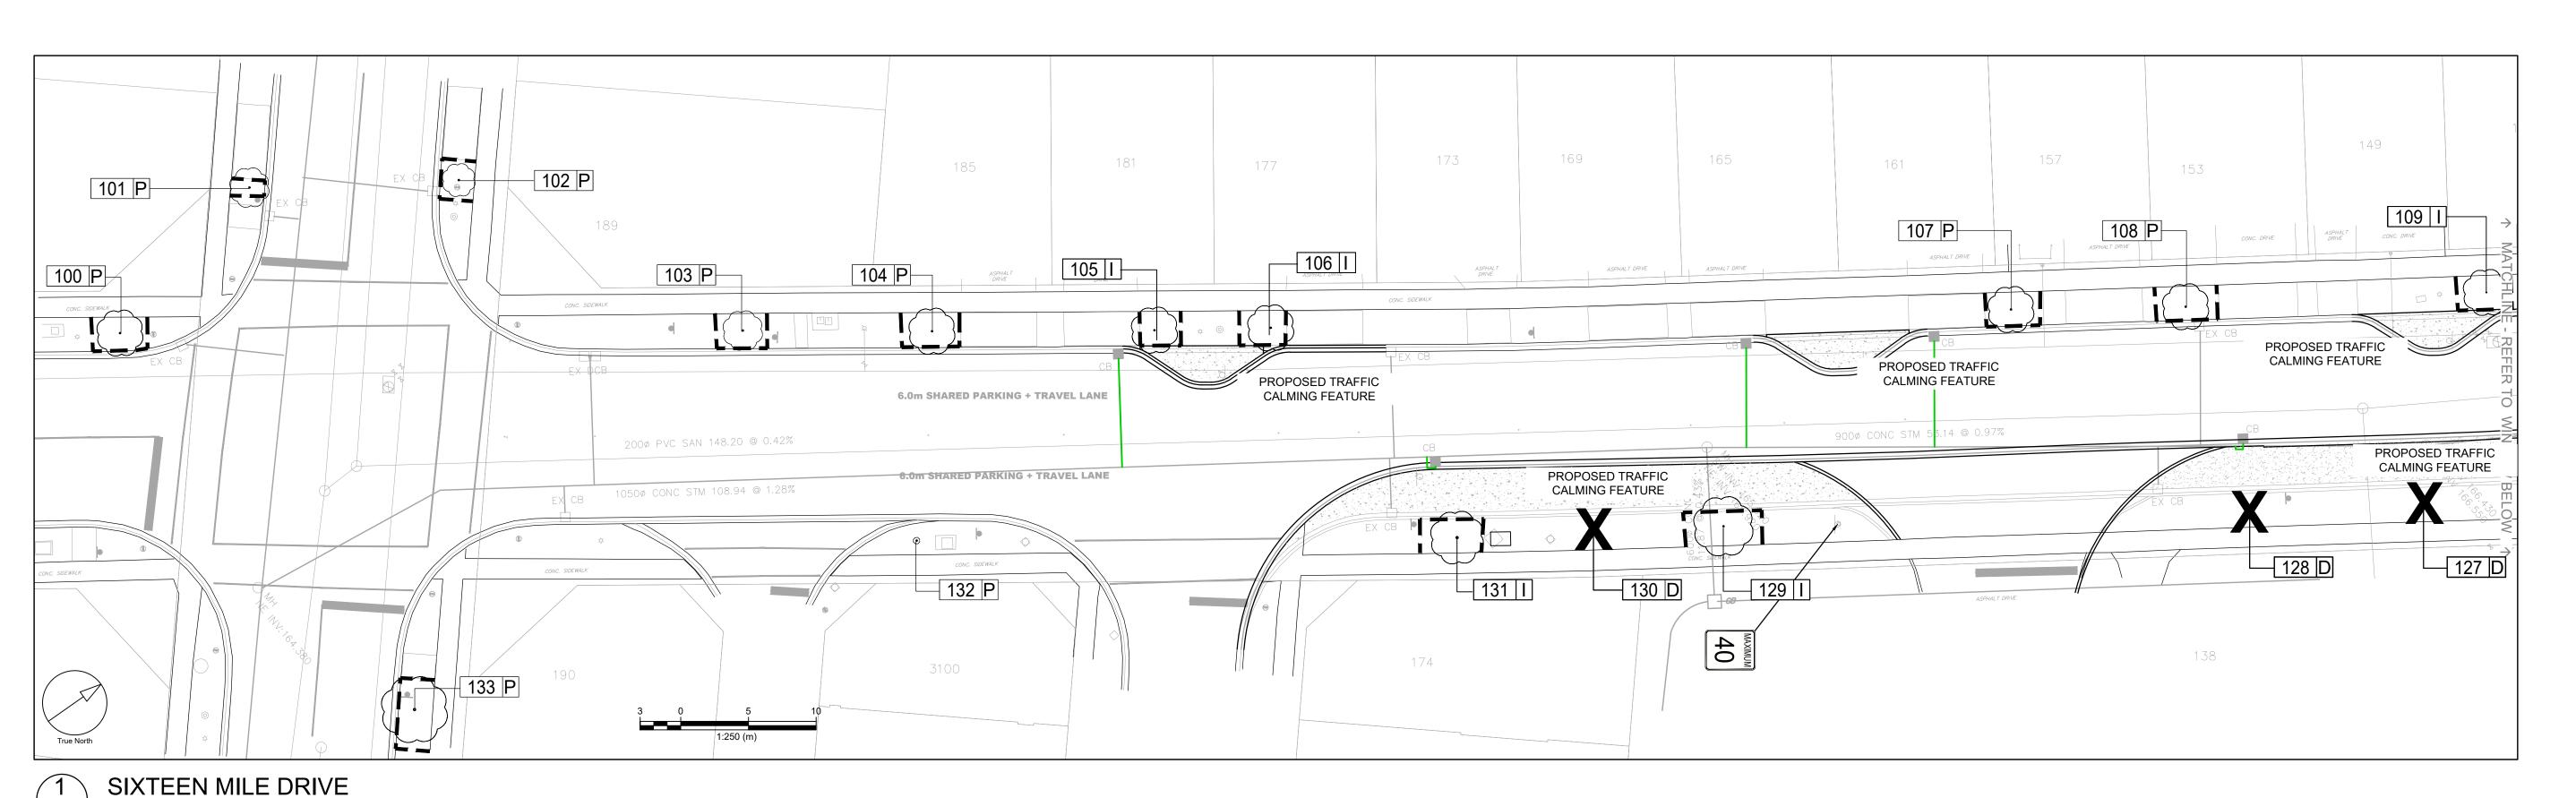

TPP-1

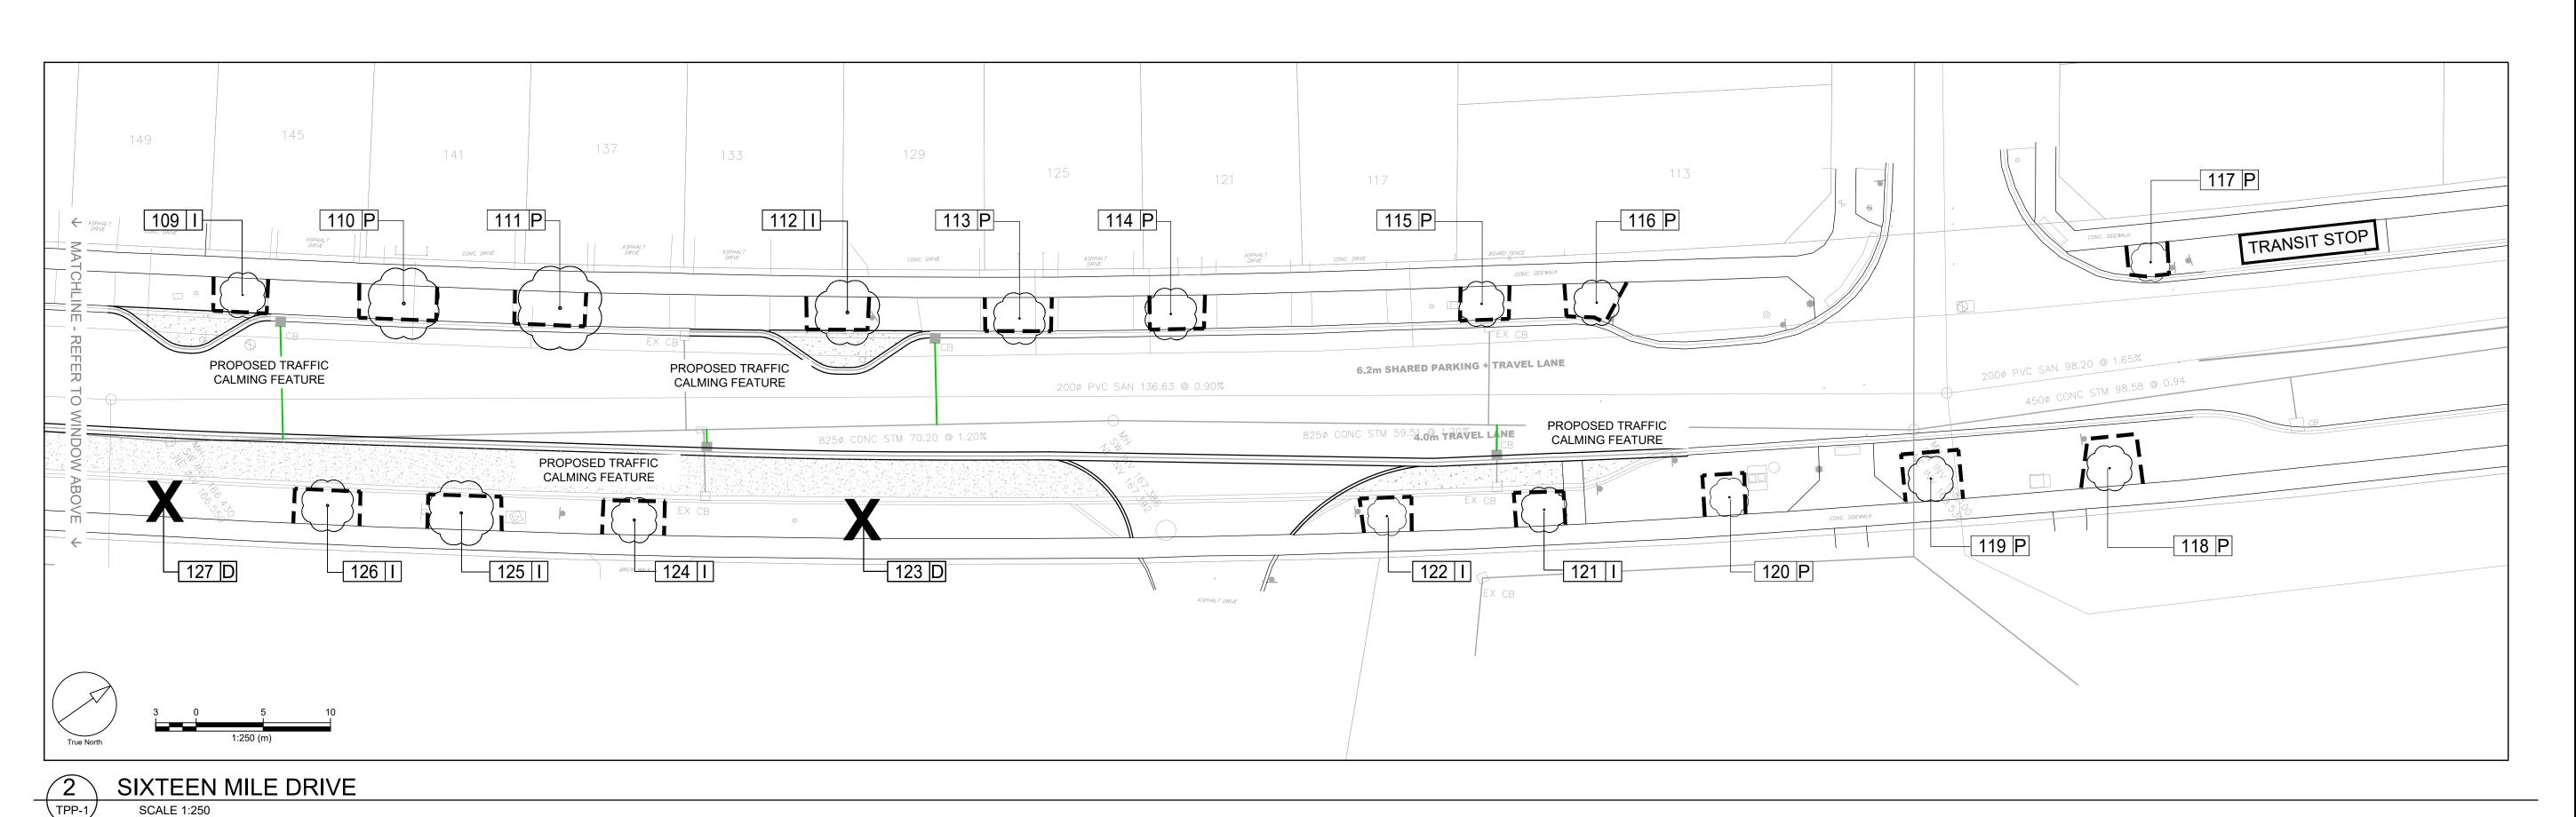

CLIENT OAKVILLE Town of Oakville Transportation and Engineering COPYRIGHT This drawing has been prepared solely for the intended use, thus any reproduction or distribution for any purpose other than authorized by IBI Group is forbidden. Written dimensions shall have precedence over scaled dimensions. Contractors shall verify and be responsible for all dimensions and conditions on the job, and IBI Group shall be informed of any variations from the dimensions and conditions shown on the drawing. Shop drawings shall be submitted to IBI Group for general conformance before proceeding with fabrication. IBI Group Professional Services (Canada) Inc. is a member of the IBI Group of companies DESCRIPTION DATE 1 FOR 30% SUBMISSION 2022-04-26 LEGEND EXISTING DECIDUOUS TREE EXISTING CONIFEROUS TREE

TREE IDENTIFICATION TAGS 0 P→ TREE TO BE PRESERVED 0 R TREE TO BE REMOVED 0 | TREES IMPACTED BY PROPOSED CONSTRUCTION 0 D TREES THAT ARE DEAD TEMPORARY PAIGE WIRE TREE PROTECTION FENCING

SEAL ISA-ON-1016A

SITE PLAN NUMBER PRIME CONSULTANT IBI GROUP Suite 101 - 410 Albert Street
Waterloo ON N2L 3V3 Canada
tel 519 585 2255 ibigroup.com

PROJECT TRAFFIC CALMING INFRASTRUCTURE ST. GREGORY CATHOLIC ELEM. SCH. SIXTEEN MILE DRIVE FROM PRESERVE DR TO COLTON WAY PROJECT NO:


142042 DRAWN BY: CHECKED BY: G.J. PROJECT MGR: APPROVED BY: G.J. SHEET TITLE

TREE PRESERVATION PLAN

SHEET NUMBER


TPP-1


ISSUE

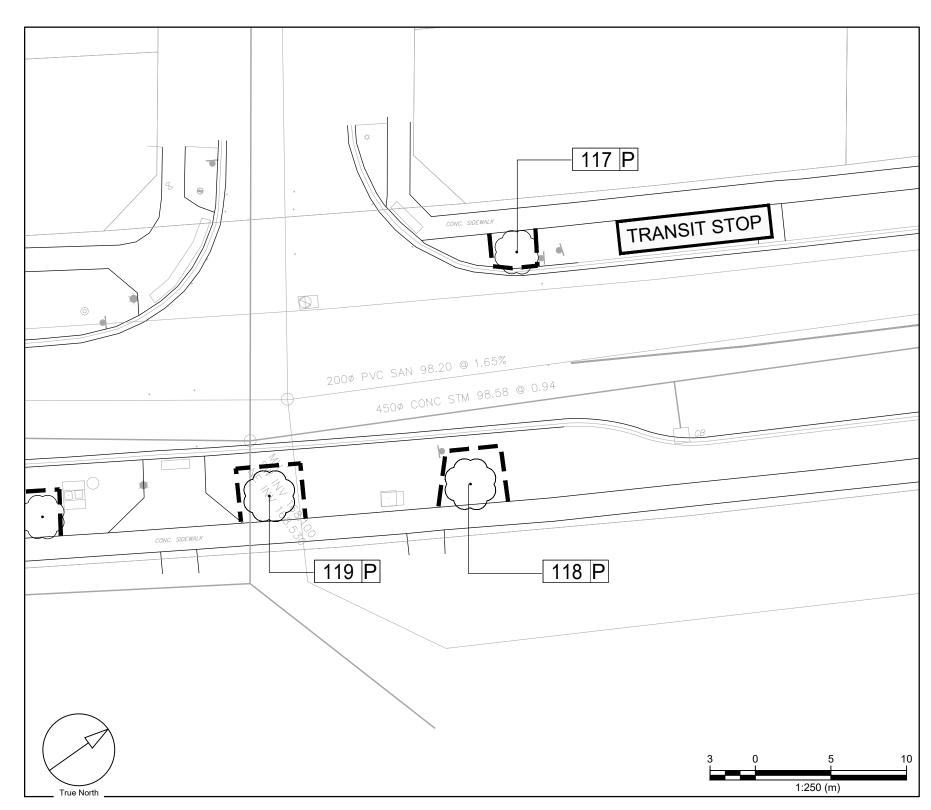


١	SIXTEEN MILE DRIVE	
	SCALE 1:250	

				Dripline	Trunk	Crown	Crown Vigor	Overall				
ID# E	Botanical Name	Common Name	DBH (cm)	Radius (m)	Integrity	Integrity		Condition	Ownership	Impacts	Action	Comments
9	Sixteen Mile Drive (Prese	erve Dr. to Colton Way)										
100	Acer saccharum	Legacy Sugar maple	8	1.7	Good	Good	Good	Good	Municipal	None	Preserve and protect	
101	Acer rubrum	Red maple	8	1.54	Good	Good	Good	Good	Municipal	None	Preserve and protect	
102	Acer rubrum	Red maple	8	1.2	Good	Good	Good	Good	Municipal	None	Preserve and protect	Some minor old damage to trunk. Very close to light post.
103	Acer saccharum	Legacy Sugar maple	8	1.5	Fair	Good	Good	Good	Municipal	None	Preserve and protect	Scar in lower trunk
104	Acer saccharum	Legacy Sugar maple	10	1.8	Good	Good	Good	Good	Municipal	None	Preserve and protect	Old bird nest in tree
105	Acer saccharum	Legacy Sugar maple	11	1.8	Good	Good	Good	Good	Municipal	Injury due to	Preserve and protect	Pavers around base. Old bird nest in tree.
										construction		
106	Acer rubrum	Red maple	8	1.7	Good	Good	Good	Good	Municipal	Injury due to	Preserve and protect	Old bird nest in tree
										construction		
_	Acer saccharum	Legacy Sugar maple	11	1.74	Good	Good	1	Good	Municipal	None	Preserve and protect	
108	Acer saccharum	Legacy Sugar maple	11	1.8	Good	Good	Good	Good	Municipal	None	Preserve and protect	Planting bed at base.
109	Acer saccharum	Legacy Sugar maple	10	1.65	Good	Good	Good	Good	Municipal	Injury due to	Preserve and protect	A couple of branches have been pruned.
				_			<u> </u>			construction		
	Jlmus davidiana var.	Accolade elm	20	2.8	Good	Good	Good	Good	Municipal	None	Preserve and protect	
	aponica 'Accolade'					_						
	Jlmus davidiana var.	Accolade elm	18.5	3.2	Good	Good	Good	Good	Municipal	None	Preserve and protect	
F	aponica 'Accolade'					_						
	Jlmus davidiana var.	Accolade elm	21	2.46	Good	Good	Good	Good	Municipal	Injury due to	Preserve and protect	Daylily bed at base of tree.
	aponica 'Accolade'									construction		
-	Acer saccharum	Legacy Sugar maple	11	1.94	Good	Good	Good	Good	Municipal	None	Preserve and protect	
	Acer rubrum	Red maple	10	1.93	Good	Good		Good	Municipal	None	Preserve and protect	Some dieback in the canopy
	Acer rubrum	Red maple	11	1.8	Good	Good	+	Good	Municipal	None	Preserve and protect	
-	Acer rubrum	Red maple	11	1.8	Good	Good	Good	Good	Municipal	None	Preserve and protect	Flower bed at base of trunk.
	Acer saccharum	Legacy Sugar maple	11	1.58	Good	Good		Good	Municipal	None	Preserve and protect	Soil mounded at base
-	Acer saccharum	Legacy Sugar maple	8	1.8	Good	Good	1	Good	Municipal	None	Preserve and protect	
-	Acer rubrum	Red maple	9	1.66	Good	Good	Good	Good	Municipal	None	Preserve and protect	
	Acer saccharum	Legacy Sugar maple	9	1.5	Fair	Good		Good	Municipal	None	Preserve and protect	Old damage on lower trunk
121	Acer saccharum	Legacy Sugar maple	8	1.8	Good	Good	Good	Good	Municipal	Injury due to	Preserve and protect	
122	<u> </u>		44	1.5	C 1			C 1	N.A	construction	Dunnamus and mustant	
122	Acer saccharum	Legacy Sugar maple	11	1.6	Good	Good	Good	Good	Municipal	Injury due to construction	Preserve and protect	
123 [DEAD									Construction	Remove	
_	Jlmus davidiana var.	Accolade elm	13	1.7	Good	Good	Good	Good	Municipal	Injury due to	Preserve and protect	
	aponica 'Accolade'	Accolance cilli	13	1./	Juou	3000	3000	Juou	14Idi iicipai	construction	Treserve and protect	
	Jlmus davidiana var.	Accolade elm	16	2.57	Good	Good	Fair	Good	Municipal	Injury due to	Preserve and protect	Some tip dieback
	aponica 'Accolade'	Accorate citt	10	2.57	Jood	3000	" " "	3000	, viaincipai	construction	l reserve and protect	Some up dieback
	Jlmus davidiana var.	Accolade elm	14	2.1	Good	Good	Good	Good	Municipal	Injury due to	Preserve and protect	Some girdled roots
	aponica 'Accolade'	Accorage Cilli	14		Jugar	3000	3000	3000	, via ncipai	construction	Treserve and protect	Some gridied roots
127 [•										Remove	
128 [Remove	
—	Acer rubrum	Red maple	11	2.2	Good	Good	Good	Good	Municipal	Injury due to	Preserve and protect	Some suckering
123 /	acci iubiuiii	incu mapie	11		Jood	3000	3000	3000	, viaincipai	construction	l reserve and protect	Some successing
130 [DEAD										Remove	
	Acer rubrum	Red maple	13	2.1	Good	Good	Good	Good	Municipal	Injury due to	Preserve and protect	Tree was planted quite high.
-51	THE TWO MILLS									construction		
132	Acer saccharum	Legacy Sugar maple	9	0.33	Good	Good	Fair	Good	Municipal	None	Preserve and protect	
	Acer x freemanii	Freeman maple	14	2.52	Good	Good	1	Good	Municipal	None	Preserve and protect	
<u> </u>	· · · · · · · · · · · · · · · · · · ·				1	ı	1	I		1		

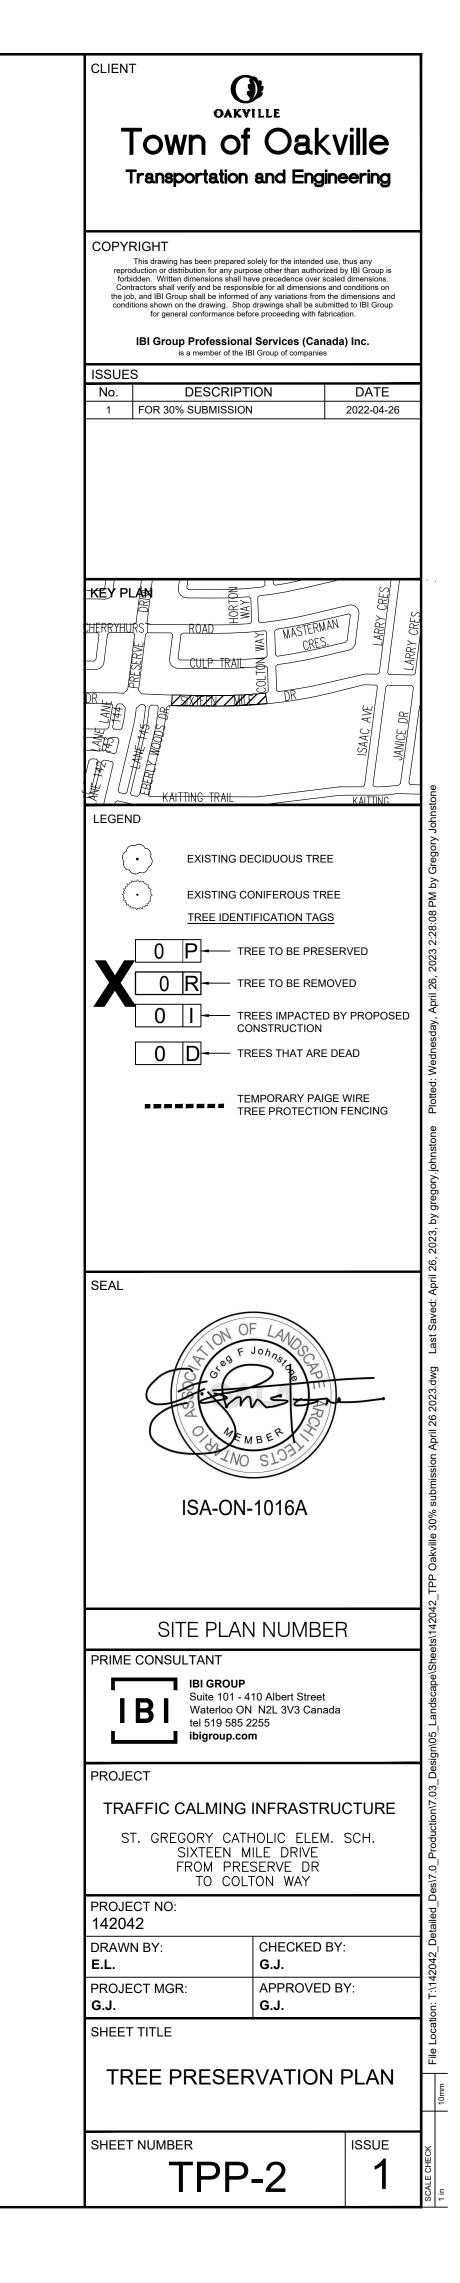

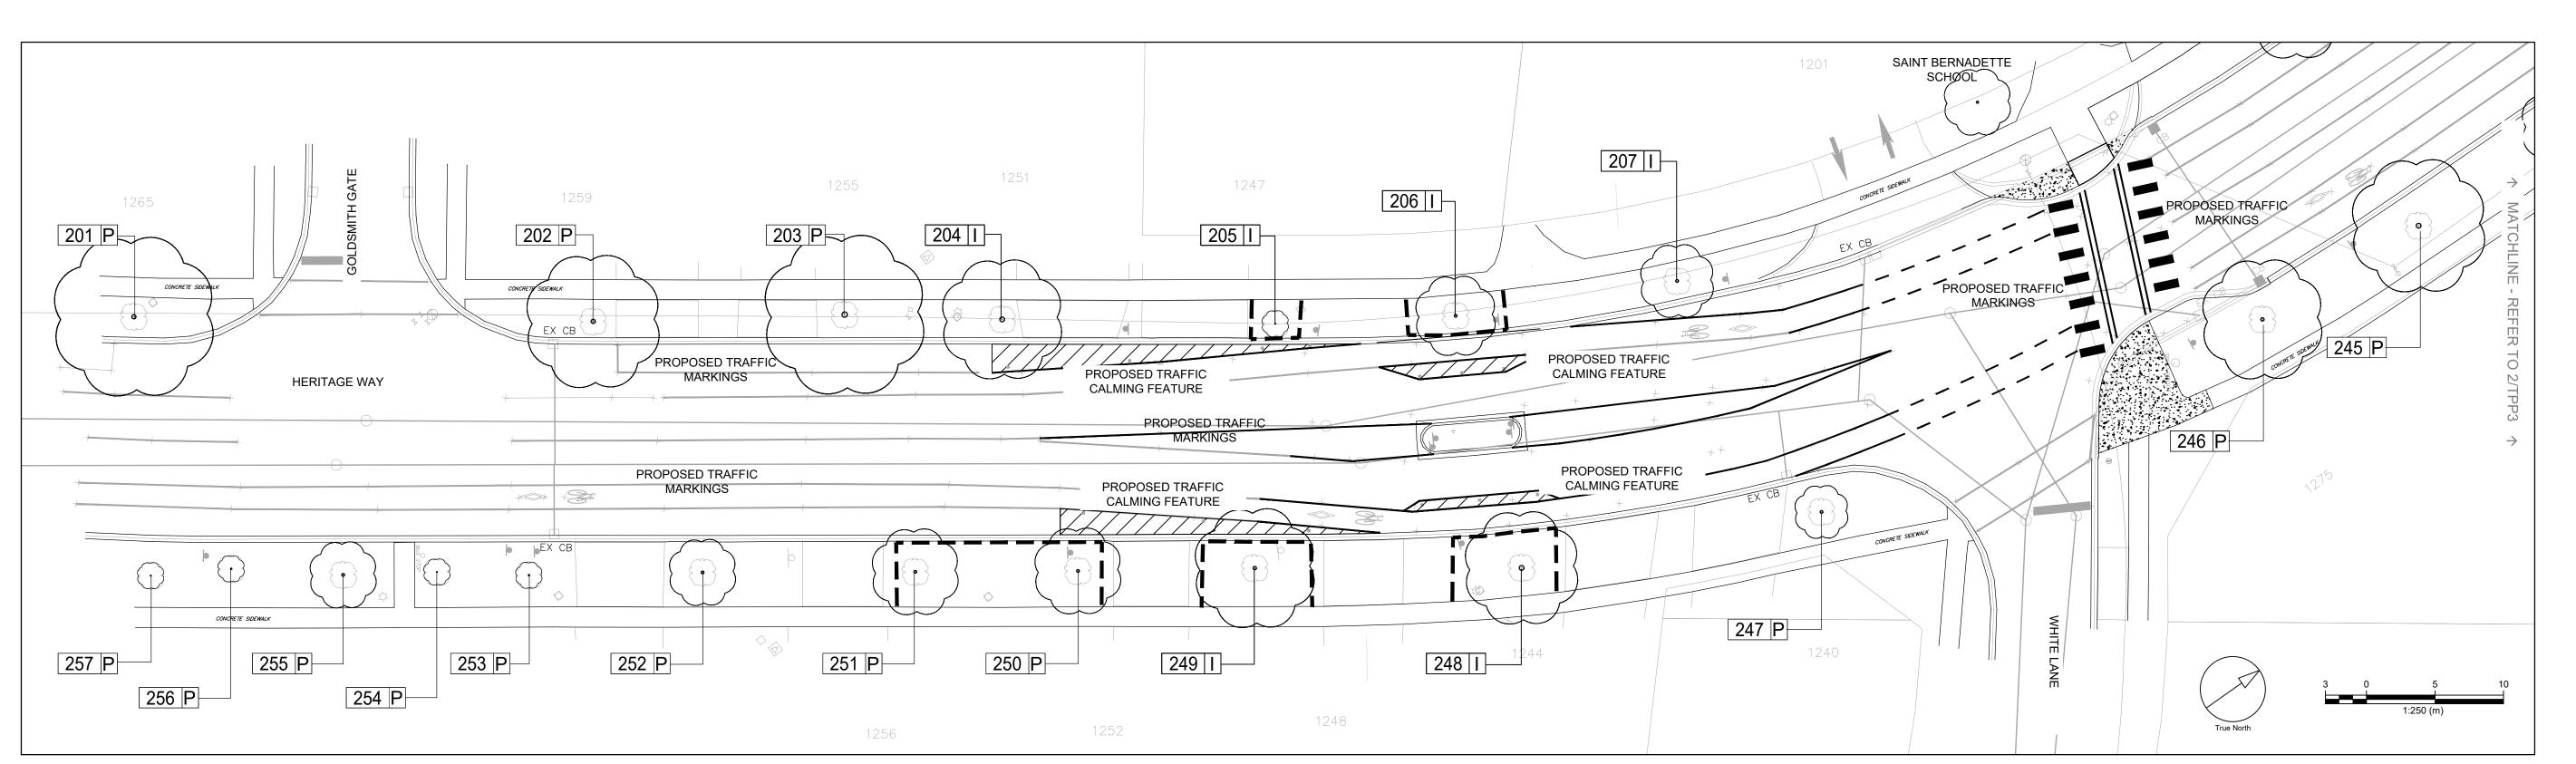

HERITAGE WAY (GOLDSMITH GATE TO WHITE LANE) - SAINT BERNADETTE SCALE 1:250

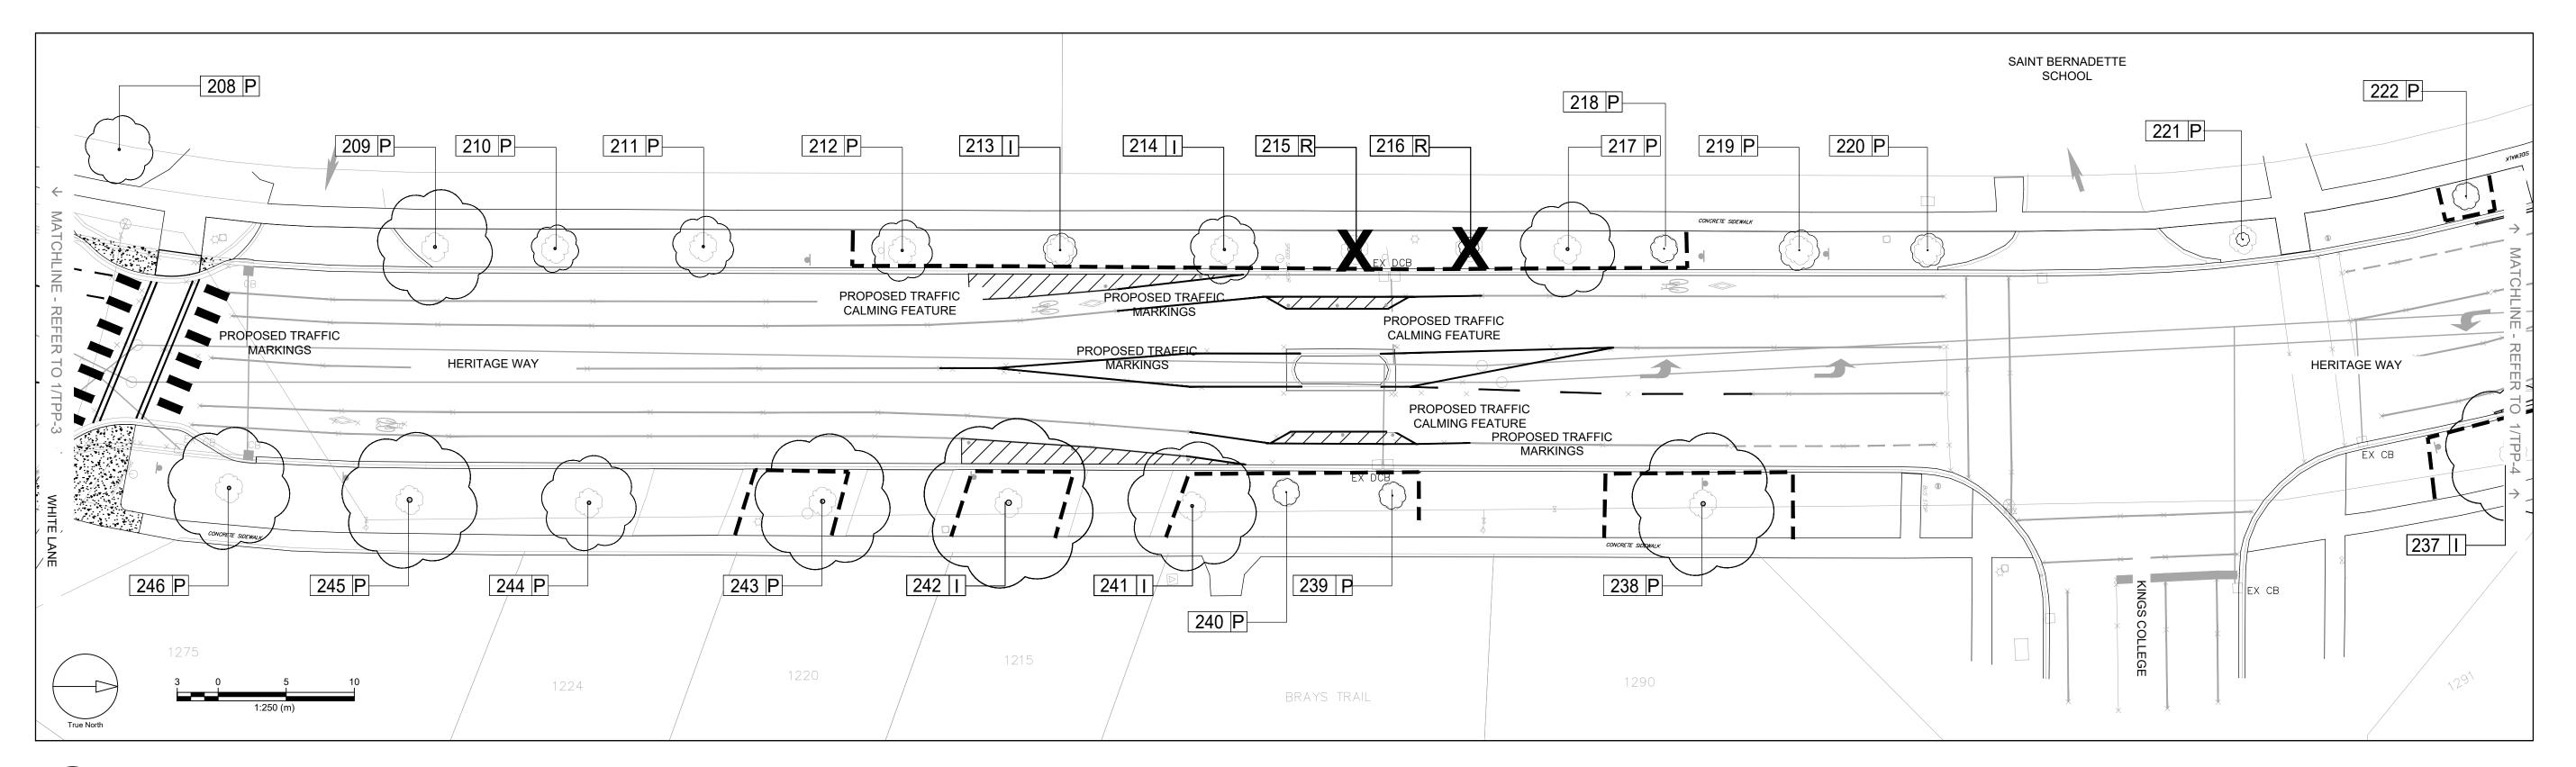

HERITAGE WAY (WHITE LANE TO KINGS COLLEGE) - SAINT BERNADETTE SCALE 1:250

TPP-3

This drawing has been prepared solely for the intended use, thus any reproduction or distribution for any purpose other than authorized by IBI Group is forbidden. Written dimensions shall have precedence over scaled dimensions. Contractors shall verify and be responsible for all dimensions and conditions on the job, and IBI Group shall be informed of any variations from the dimensions and conditions shown on the drawing. Shop drawings shall be submitted to IBI Group for general conformance before proceeding with fabrication. IBI Group Professional Services (Canada) Inc. is a member of the IBI Group of companies DESCRIPTION 1 FOR 30% SUBMISSION

OAKVILLE

Town of Oakville

Transportation and Engineering

CLIENT

COPYRIGHT

LEGEND EXISTING DECIDUOUS TREE EXISTING CONIFEROUS TREE TREE IDENTIFICATION TAGS

0 P TREE TO BE PRESERVED TREES IMPACTED BY PROPOSED CONSTRUCTION 0 D TREES THAT ARE DEAD

TEMPORARY PAIGE WIRE TREE PROTECTION FENCING

ISA-ON-1016A

SITE PLAN NUMBER

PRIME CONSULTANT IBI GROUP
Suite 101 - 410 Albert Street
Waterloo ON N2L 3V3 Canada
tel 519 585 2255 ibigroup.com

PROJECT

TRAFFIC CALMING INFRASTRUCTURE

ST. BERNADETTE CATHOLIC ELEM. SCH. HERITAGE WAY FROM BLACKSMITH LANE TO GOLDSMITH GATE PROJECT NO:

142042 DRAWN BY: PROJECT MGR:

APPROVED BY:

CHECKED BY:


ISSUE

SHEET TITLE

TREE PRESERVATION PLAN

SHEET NUMBER


TPP-3

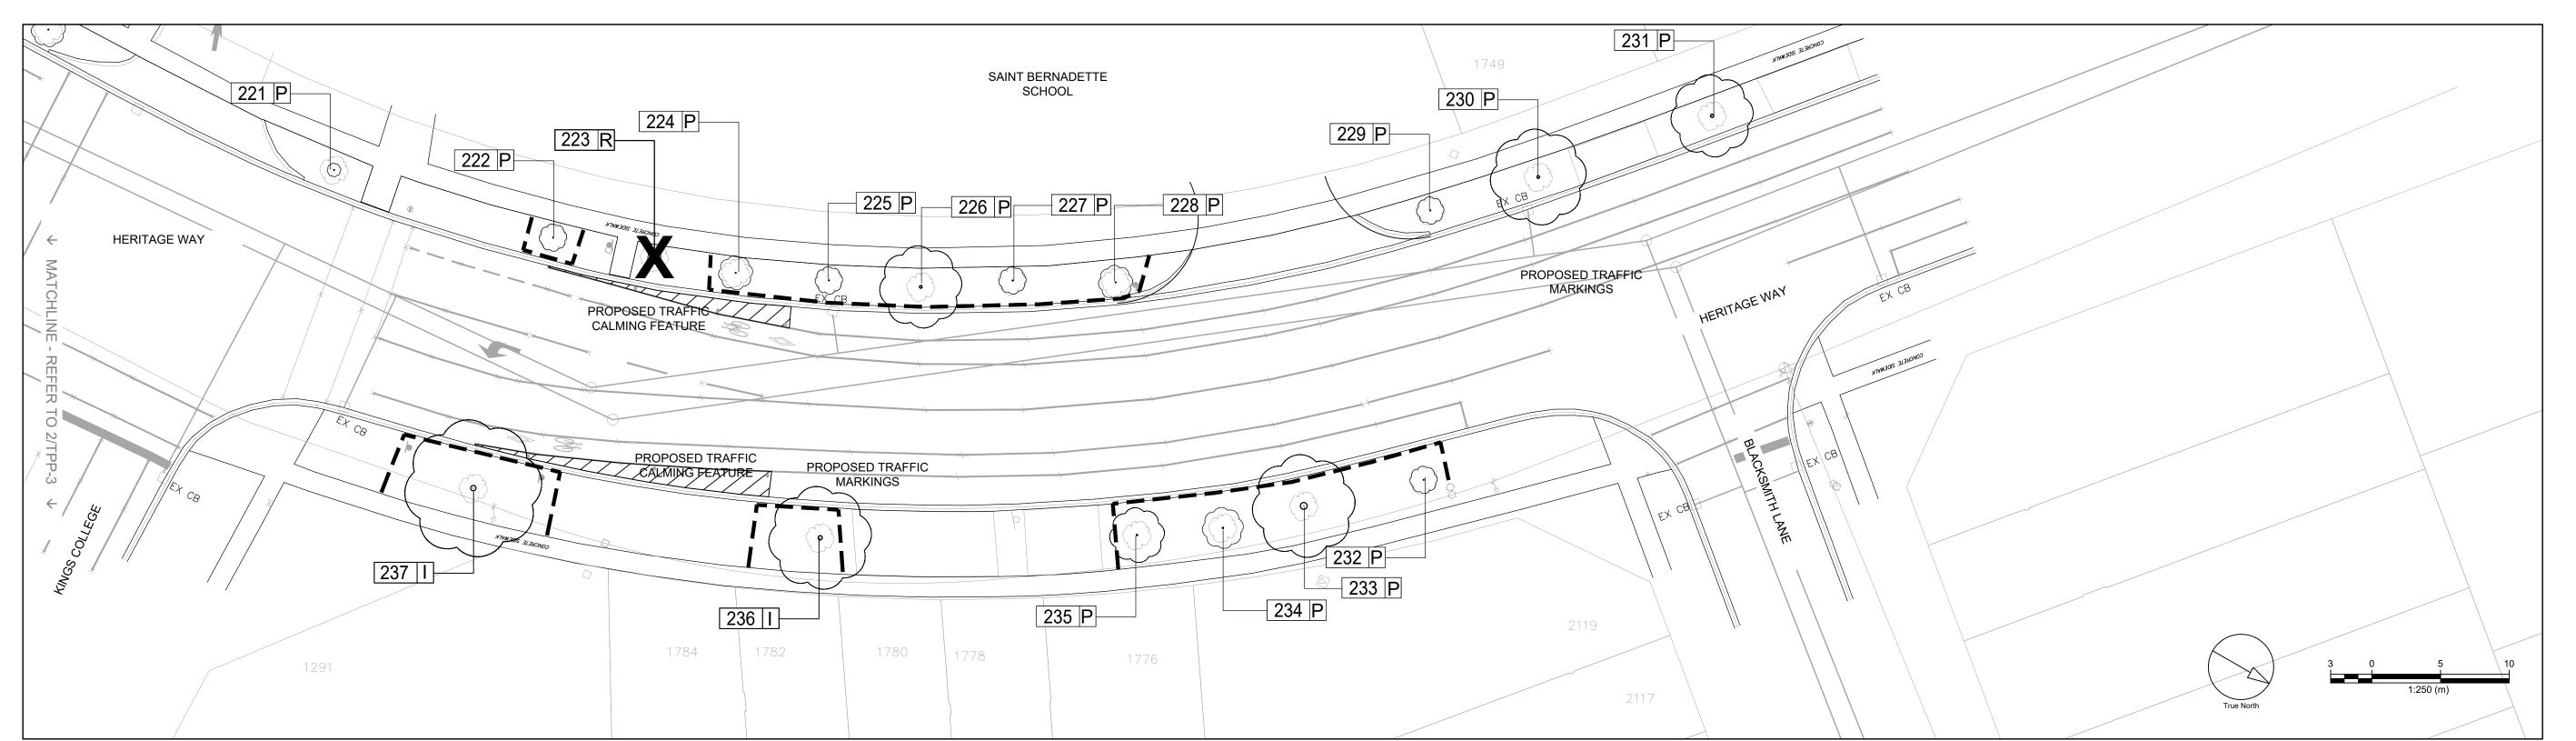


1 HERITAGE WAY (KINGS COLLEGE TO BLACKSMITH LANE) - SAINT BERNADETTE
SCALE 1:250

				Dripline	Trunk	Crown	Crown Vigor	Overall				
ID#	Botanical Name	Common Name	DBH (cm)	Radius (m)	Integrity	Integrity		Condition	Ownership	Impacts	Action	Comments
	Heritage Way (Goldsmith	n Gate to Inskeeper Cou	ırt) - Saint Be	ernadette	_							
201	Gleditsia tri. Var. inermis	Honey locust	31	6	Good	Good	Good	Good	Municipal	None	Preserve and protect	
202	Quercus rubra	Red oak	30	5	Good	Good	Good	Good	Municipal	None	Preserve and protect	
203	Quercus rubra	Red oak	38	6	Good	Good	Good	Good	Municipal	None	Preserve and protect	
204	Quercus rubra	Red oak	33	4.4	Good	Good	Good	Good	Municipal	Injury due to	Preserve and protect	
										construction		
205	Ginkgo biloba	Maidenhair tree	5	0.9	Good	Good	Good	Good	Municipal	Injury due to	Preserve and protect	Newly planted tree.
										construction		
206	Acer platanoides	Norway maple	18	2.9	Good	Good-fair	Good	Good	Municipal	Injury due to	Preserve and protect	Maintenance pruned on road side.
207	A - -	NI I -	22	2.7	F-:	CI	CI	CI	Municipal	construction	Duncanus and muchast	Tree has a disht loop to word wood Maintenance now and an used
207	Acer platanoides	Norway maple	22	2.7	Fair	Good	Good	Good	iviunicipai	Injury due to construction	Preserve and protect	Tree has a slight lean towards road. Maintenance pruned on road side.
208	Acer platanoides	Norway maple	16	2.4	Fair-poor	Poor	Poor	Poor	Private	None	Preserve and protect	Tree has split in trunk. Appears to be in decline.
	Platanus x acerfolia	London plane tree	22	4.2	Good	Good	Good	Good	Municipal	None	Preserve and protect	Maintenance pruned on road side.
	Acer platanoides	Norway maple	15	1.7	Good	Good	Good	Good	Municipal	None	Preserve and protect	Maintenance pruned on road side. Has some exposed roots.
	Acer platanoides	Norway maple	16	2.3	Fair	Good	Good	Good	Municipal	None	Preserve and protect	Maintenance pruned on road side.
	Ulmus davidiana var.	Accolade elm	13	2.2	Good	Good	Good	Good	Municipal	None	Preserve and protect	Maintenance pruned on road side. Old wound at base of trur
212	japonica 'Accolade'	Accolage elli	13	2.2	Good	Good	Good	Good	Ividilicipal	None	Treserve and protect	Namite name pruned on road side. Old woulld at base of trui
212	Acer platanoides	Norway maple	10	1.3	Fair-poor	Fair	Good	Fair	Municipal	Injury due to	Preserve and protect	Maintenance pruned on road side. Old wound on trunk.
213	Acei piatanoides	Indiway mapie	10	1.5	l all-pool	all	Good	an	Ivianicipai	construction	Treserve and protect	invalintenance pruneu on road side. Old wound on trunk.
214	Acer platanoides	Norway maple	15	2.5	Fair	Good-fair	Good	Fair	Municipal	Injury due to	Preserve and protect	Maintenance pruned on road side. Large old crack on trunk.
	Production and								,	construction	'	Exposed roots.
215	Quercus bicolor	swamp white oak	4	0.6	Good-fair	Poor	Poor	Poor	Municipal	Injury due to	Remove	Replace.
									'	construction		
216	Tilia cordata	Linden	7	0.8	Fair-poor	Poor	Poor	Poor	Municipal	Injury due to	Remove	Replace.
					•					construction		
217	Platanus x acerfolia	London plane tree	21	3.6	Fair	Good-fair	Good	Fair	Municipal	None	Preserve and protect	Tree leans towards road.
218	Ulmus davidiana var.	Accolade elm	5	1.1	Fair	fair	fair	fair	Municipal	None	Preserve and protect	Tree leans towards road. Might consider repalcement.
	japonica 'Accolade'											
219	Acer x Freemanii	Freeman maple	6	1.4	Good	Good	fair	Good	Municipal	None	Preserve and protect	Suckering at base of tree.
220	Aesculus glabra	Ohio buckeye	7	1.2	Good	Good	Good	Good	Municipal	None	Preserve and protect	
221	Aesculus glabra	Ohio buckeye	6	0.5	Good	Good	Good	Good	Municipal	None	Preserve and protect	
222	Gleditsia tri. Var. inermis	Honey locust	6	1.1	Good	Good	Good	Good	Municipal	None	Preserve and protect	
223	Acer rubrum	Columnar red maple	5	0.4	Good-fair	Poor	Poor	Poor	Municipal	None	Remove	Replace.
224	Gleditsia tri. Var. inermis	Honey locust	6	1.2	Good	Good	Good	Good	Municipal	None	Preserve and protect	
225	Gymnocaldus dioicus	Kentucky coffee tree	6	1.1	Good	Good	Good-fair	Good	Municipal	None	Preserve and protect	Has some exposed roots.

226	Acer platanoides	Norway maple	20	2.9	Fair	Good	Good	Good	Municipal	None	Preserve and protect	Hollow with rot section in lower trunk. Review for structural
												integrity.
227	Gymnocaldus dioicus	Kentucky coffee tree	6	1.1	Good	Good-fair	Good-fair	Good	Municipal	None	Preserve and protect	
228	Phellodendron amurense	Corktree	5	1.2	Good	Good	Good	Good	Municipal	None	Preserve and protect	
229	Phellodendron amurense	Corktree	6	1.1	Good	Good	Good	Good	Municipal	None	Preserve and protect	
230	Acer platanoides	Norway maple	20	3.5	Fair	Good	Good	Good	Municipal	None	Preserve and protect	Maintenance pruned on road side. Moderate lean.
231	Acer platanoides	Norway maple	24	3.1	Good-fair	Good	Good	Good	Municipal	None	Preserve and protect	Maintenance pruned on road side.
232	Ginkgo biloba	Maidenhair tree	5	1	Good	Good	Good	Good	Municipal	None	Preserve and protect	
233	Tilia cordata	Linden	48	3.8	Good	Good	Good	Good	Municipal	None	Preserve and protect	Maintenance pruned on road side. Possible rot in central trun
234	Quercus bicolor	Swamp white oak	8	1.4	Good	Good	Good	Good	Municipal	None	Preserve and protect	
235	Gymnocaldus dioicus	Kentucky coffee tree	11	2	Good	Good	Good	Good	Municipal	None	Preserve and protect	
236	Tilia cordata	Linden	32	3.7	Good	Good	Good	Good	Municipal	Injury due to	Preserve and protect	Maintenance pruned on road side.
227	A	Namena	20		Caral Cain	C I	Cl	6	N 4	construction	Duna a muna a mada mada a d	Harana and a salar
237	Acer platanoides	Norway maple	39	5.1	Good-fair	Good	Good	Good	Municipal	Injury due to	Preserve and protect	Has some exposed roots.
220	Acer platanoides	Norway maple	32	5.2	Good	Good	Good	Good	Municipal	construction None	Dreserve and protect	Tree has girdled roots.
	Acer platanoides Acer saccharum	Sugar maple	5	1	Good-fair	Good-fair	Good-fair	Good-fair	Municipal	None	Preserve and protect	Tree has ghuled roots.
	Acer saccharum	Sugar maple	5	1	Good-fair	Good-fair	Good-fair		Municipal	None	Preserve and protect	
 	Gleditsia tri. Var. inermis	· ·	22	4.8	+	Good	Good	Good	Municipal	Injury due to	 	Tree has a slight lean towards road.
241	Gleditsia tii. vai. illeiiilis	noney locust	22	4.0	G00u-raii	Good	Good	Good	Iviumcipai	construction	rieserve and protect	Tree has a slight lean towards road.
242	Acer platanoides	Norway maple	38	6.2	Good	Good	Good	Good	Municipal	Injury due to	Preserve and protect	Tree has girdled roots.
										construction		3. a.
243	Acer platanoides	Norway maple	32	5.1	Good	Good	Good	Good	Municipal	None	Preserve and protect	Tree will conflict with light post.
244	Acer platanoides	Norway maple	25	3.4	Good	Good	Good	Good	Municipal	None		Maintenance pruned on road side.
245	Acer platanoides	Norway maple	34	4.9	Good	Good	Good	Good	Municipal	None	Preserve and protect	Maintenance pruned on road side.
246	Acer platanoides	Norway maple	26	4.6	Good	Good	Fair	Good	Municipal	None	Preserve and protect	Maintenance pruned on road side.
247	Acer rubrum	Columnar maple	20	2.1	Good	Good	Good	Good	Municipal	None	Preserve and protect	Lower branches have been pruned.
248	Quercus rubra	Red oak	36	4.3	Good	Good	Good	Good	Municipal	Injury due to	Preserve and protect	Conflicts with light post.
										construction		
249	Acer saccharum	Sugar maple	27	4.5	Good	Good	Good	Good	Municipal	Injury due to	Preserve and protect	planting bed a base of tree.
										construction		
250	Acer platanoides	Norway maple	18	3.3	Good-fair	Good	Good	Good	Municipal	None	Preserve and protect	
251	Acer platanoides	Norway maple	22	3.2	Good	Good	Good	Good	Municipal	None	Preserve and protect	Tree has a slight lean. Lots of soil mounded at base of trunk.
252	Acer platanoides	Norway maple	21	2.6	Good	Good	Good	Good	Municipal	None	Preserve and protect	
253	Quercus bicolor	Swamp white oak	8	1.1	Good	Good-fair	fair	Good-fair	Municipal	None	Preserve and protect	Planted a bit low.
254	Quercus bicolor	Swamp white oak	7	1.1	Good-fair	Good-fair	Good-fair	Good-fair	Municipal	None	Preserve and protect	
255	Acer platanoides	Norway maple	17	2.4	Good-fair	Good	Good	Good	Municipal	None	Preserve and protect	Conflicts with light post. Old trunk damage.
256	Acer rubrum	Columnar red maple	8	0.9	Good	Good	Good	Good	Municipal	None	Preserve and protect	
I T	Acer rubrum	Columnar red maple	6	1.1	Good	Good	Good	Good	Municipal	None	Preserve and protect	

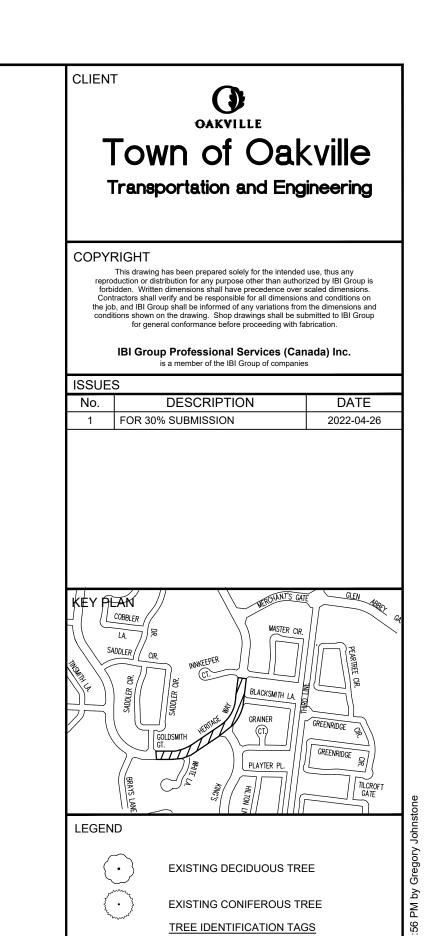

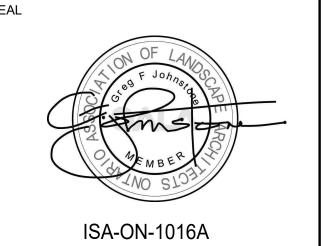

0 P - TREE TO BE PRESERVED

0 D TREES THAT ARE DEAD

TEMPORARY PAIGE WIRE TREE PROTECTION FENCING

TREES IMPACTED BY PROPOSED CONSTRUCTION

SITE PLAN NUMBER

PRIME CONSULTANT

IBI GROUP
Suite 101 - 410 Albert Street
Waterloo ON N2L 3V3 Canada
tel 519 585 2255
ibigroup.com

OJECT

TRAFFIC CALMING INFRASTRUCTURE

ST. BERNADETTE CATHOLIC ELEM. SCH.
HERITAGE WAY
FROM BLACKSMITH LANE
TO GOLDSMITH GATE

PROJECT NO:
142042

DRAWN BY: CHECKED BY:
E.L. G.J.

PROJECT MGR: APPROVED BY:


SHEET TITLE


TREE PRESERVATION PLAN

SHEET NUMBER

TDD_1

P-4 1

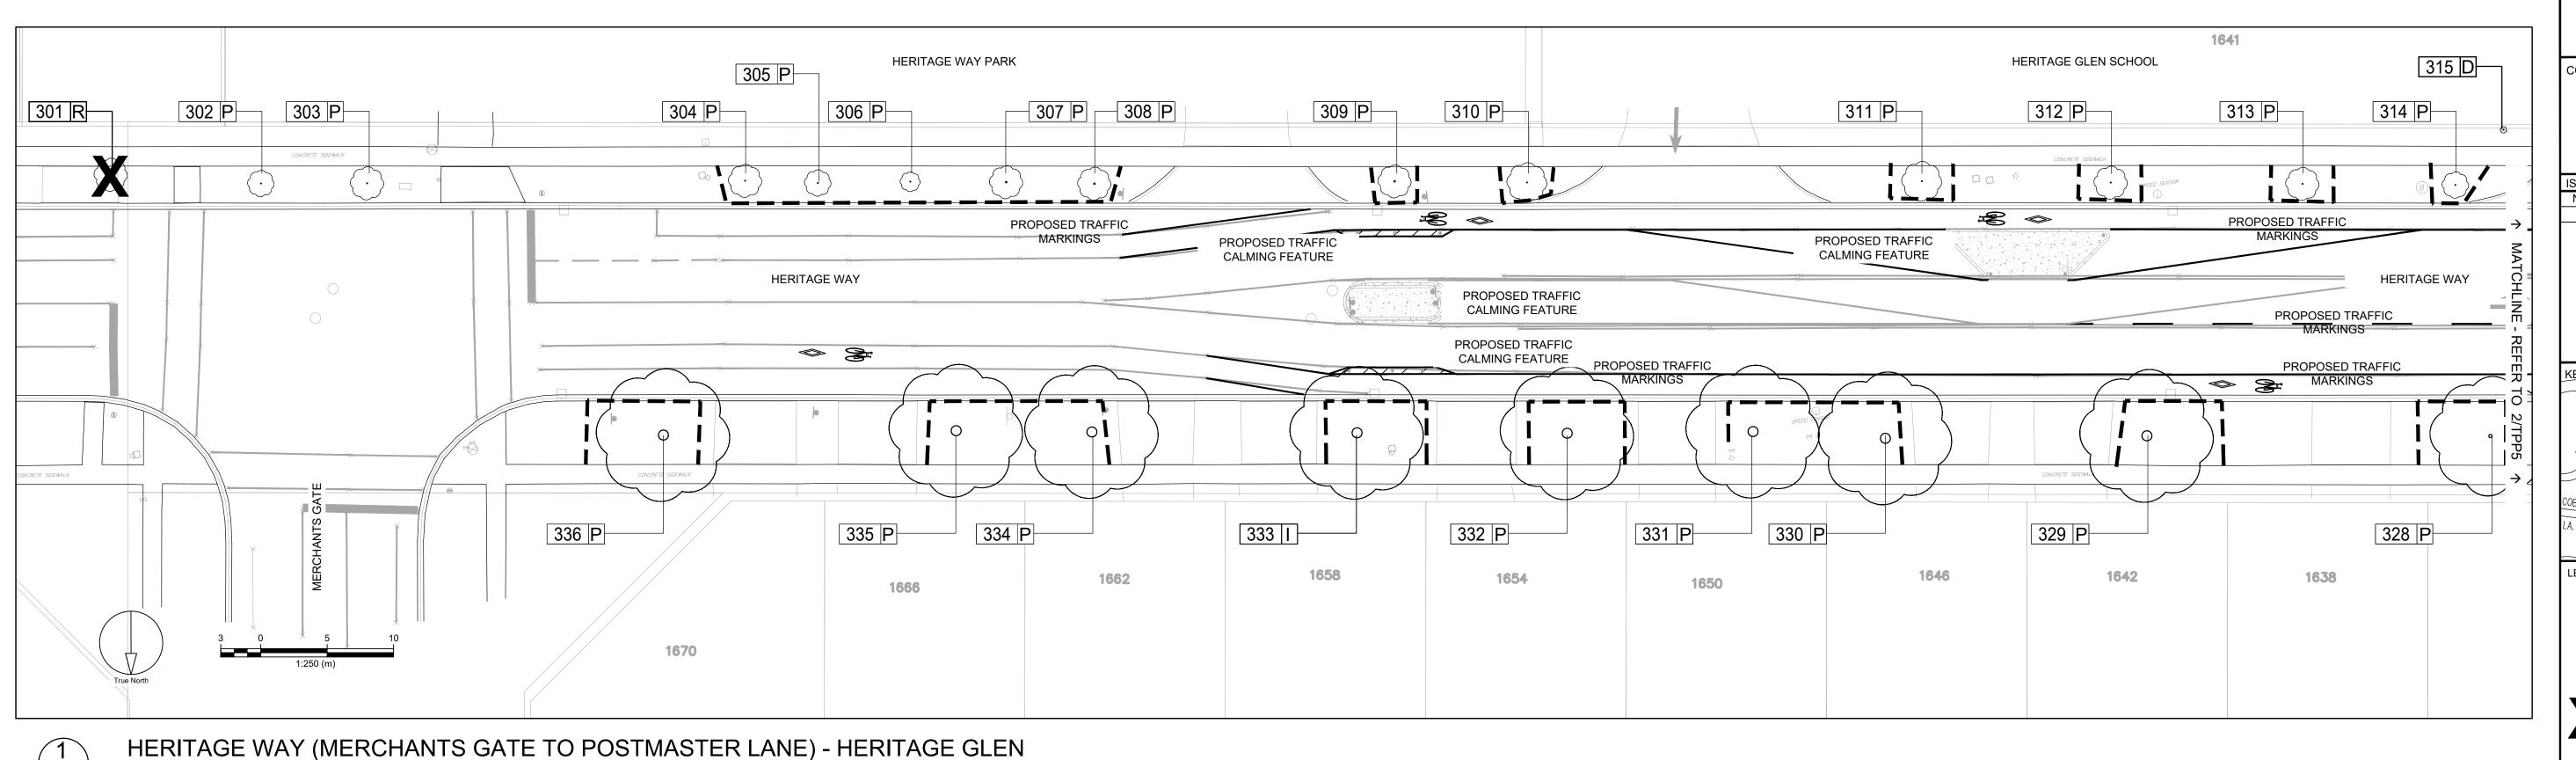

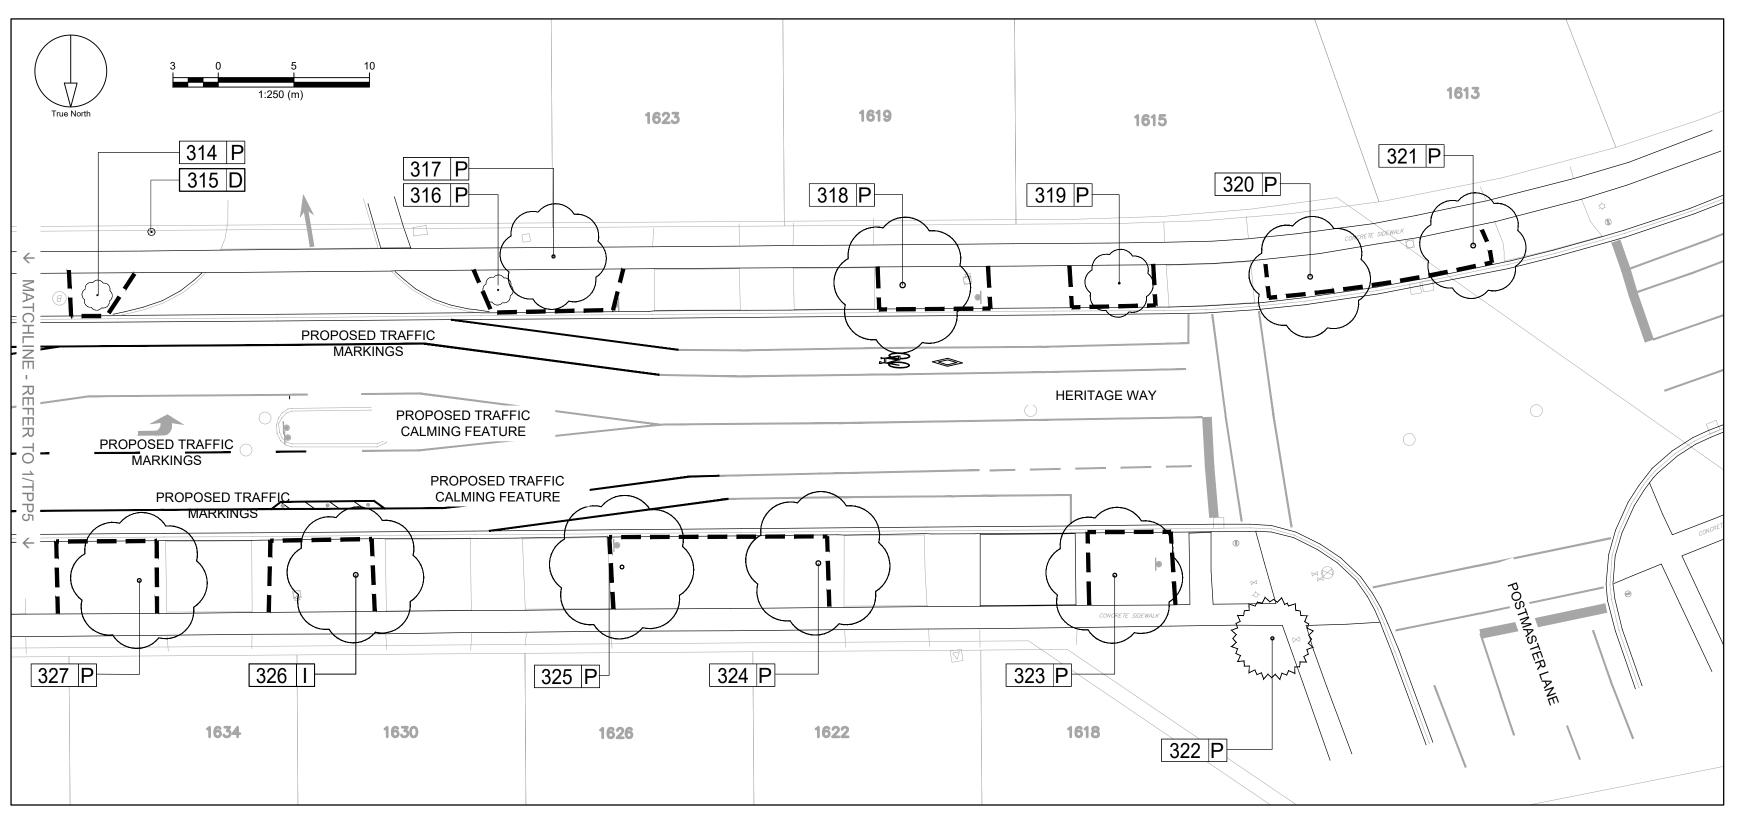

TPP-5

SCALE 1:250

HERITAGE WAY (MERCHANTS GATE TO POSTMASTER LANE) - HERITAGE GLEN (SEE TPP-6 FOR INVENTORY SCHEDULE)

SCALE 1:250

CLIENT OAKVILLE Town of Oakville Transportation and Engineering COPYRIGHT This drawing has been prepared solely for the intended use, thus any reproduction or distribution for any purpose other than authorized by IBI Group is forbidden. Written dimensions shall have precedence over scaled dimensions. Contractors shall verify and be responsible for all dimensions and conditions on the job, and IBI Group shall be informed of any variations from the dimensions and conditions shown on the drawing. Shop drawings shall be submitted to IBI Group for general conformance before proceeding with fabrication. IBI Group Professional Services (Canada) Inc. is a member of the IBI Group of companies DESCRIPTION 2022-04-26 FOR 30% SUBMISSION MASTER CIR. LEGEND EXISTING DECIDUOUS TREE EXISTING CONIFEROUS TREE TREE IDENTIFICATION TAGS 1 P TREE TO BE PRESERVED TREES IMPACTED BY PROPOSED


CONSTRUCTION CONSTRUCTION 0 D TREES THAT ARE DEAD TEMPORARY PAIGE WIRE TREE PROTECTION FENCING ISA-ON-1016A SITE PLAN NUMBER PRIME CONSULTANT IBI GROUP Suite 101 - 410 Albert Street Waterloo ON N2L 3V3 Canada tel 519 585 2255 ibigroup.com PROJECT TRAFFIC CALMING INFRASTRUCTURE HERITAGE GLEN PUBLIC SCHOOL HERITAGE WAY FROM POSTMASTER DR TO MERCHANTS GATE PROJECT NO: 142042 DRAWN BY: CHECKED BY: PROJECT MGR: APPROVED BY: SHEET TITLE TREE PRESERVATION PLAN


SHEET NUMBER

TPP-5

HERITAGE WAY (MERCHANTS GATE TO POSTMASTER LANE TREE INVENTORY SCHEDULE)

				Drinling	Trunk	Crown	Crown Vice	Overall				,
ID#	Botanical Name	Common Name	DBH (cm)	Dripline Radius (m)	Trunk	Crown	Crown Vigor		Ownership	Impacts	Action	Comments
		ster Drive to Merchants			Integrity	Integrity		Condition	Ownership	impacts	Action	Comments
	neritage way (Postilia:											
301	Quercus rubra	Red oak	10	1.2	Poor	Poor	Poor	Poor	Municipal	None	Remove	Tree is mostly dead and damaged. Growth is mostly on one si
302	Gymnocladus dioicus	Kentucky coffee tree	7	1.1	Good-Fair	Good-Fair			Municipal	None	Preserve and protect	Thee is mostly dead and damaged. Growth is mostly on one si
_	Gymnocladus dioicus	Kentucky coffee tree	7	1.2	Good	Good-Fair	Good	Good	Municipal	None	Preserve and protect	
	Gymnocladus dioicus	Kentucky coffee tree	7	1.2	Good	Good	Good	Good	Municipal	None	Preserve and protect	
-	Quercus bicolor	swamp white oak	7	1.2	Poor	Fair	Fair	Fair	Municipal	None	<u>'</u>	Tree has a fairly substantial bend in it. Should be considered
303	Quercus bicoloi	Swamp write oak	′	1	1001	ran	Fall	Fall	Ividificipal	None		for replacement.
306	Aesculus glabra	Ohio buckeye	4	0.8	Good	Good	Good	Good	Municipal	None	Preserve and protect	ioi repiacement.
307	Tilia cordata	Linden	8	1.2	Good-Fair	Good	Good	Good	Municipal	None	Preserve and protect	Codominant leader
	Tilia cordata	Linden	8	1.2	Good	Good	Good	Good	Municipal	None	Preserve and protect	Codominant leader
	Tilia cordata	Linden	8	1.2	Good	Good	Good	Good	Municipal	None	Preserve and protect	
	Acer x freemanii	Freeman maple	6	1.5	Good	Good	Good	Good	Municipal	None	Preserve and protect	
-	Acer x freemanii	Freeman maple	6	1.5	Good	Good	Good	Good	Municipal	None	· ·	Trunk has some damage to it. May need to be pruned at
211	Acer x meemann	rreeman mapie	"	1.5	Good	Good	Good	Good	Ividificipal	None	rreserve and protect	sidewalk.
312	Gleditsia tri. Var.	Thornless honeylocust	6	1.2	Good	Good	Good	Good	Municipal	None	Preserve and protect	Side waik.
312	inermis	Thorness noneylocust		1.2	Good	Good	Good	Good	Iviamcipai	None	Treserve and protect	
313	Gleditsia tri. Var.	Thornless honeylocust	6	1.2	Good	Good	Good	Good	Municipal	None	Preserve and protect	
313	inermis	Thorness noneylocast		1.2	0000	Good	0000	Good	Iviamerpai	TVOTTE	Treserve and protect	
314	Gymnocladus dioicus	Kentucky coffee tree	7	1	Good	Good	Good	Good	Municipal	None	Preserve and protect	Remove hazard wooden stake sticking out of ground.
	Stump	Kentacky confective			3000	0000	0000	0000	Marinerpar	140116	Treserve and process	Remove Hazara wooden stake sticking out of ground.
-	Gymnocladus dioicus	Kentucky coffee tree	6	1	Poor	Poor	Poor	Poor	Municipal	None	Preserve and protect	May require removal.
	Quercus rubra	Red oak	21	3.4	Good	Good	Good	Good	Municipal	None	Preserve and protect	
	Quercus rubra	Red oak	34	4.6	Good	Good	Good	Good	Municipal .	None	· '	Conflicts with existing street light.
-	Gleditsia tri. Var. inermi		9	2.2	Good	Good	Good	Good	Municipal	None		Minor damage to trunk at base.
	Quercus rubra	Red oak	31	4	Good	Good	Good	Good	Municipal	None	Preserve and protect	
	Quercus rubra	Red oak	29	3.5	Good	Good	Good	Good	Municipal .	None	Preserve and protect	
	Picea pungens	Colorado spruce	20	2.8	Fair	Fair	Fair-Poor	Fair	Private	None	Preserve and protect	May have needlecast disease.
	Quercus rubra	Red oak	25	4.6	Good	Good	Good	Good	Municipal	None	Preserve and protect	·
	Quercus rubra	Red oak	30	4.7	Good	Good	Good		Municipal	None	Preserve and protect	
325	Quercus rubra	Red oak	25	4.7	Good	Good	Good	Good	Municipal	None	Preserve and protect	
_	Quercus rubra	Red oak	31	4.4	Good	Good	Good	Good	Municipal	Injury due to	Preserve and protect	
										construction		
327	Quercus rubra	Red oak	23	4.5	Good	Good	Good	Good	Municipal	None	Preserve and protect	Has overhead tv cable wire in canopy.
328	Quercus rubra	Red oak	21	2	Good	Good	Good	Good	Municipal	None	Preserve and protect	Has overhead tv cable wire in canopy.
329	Quercus rubra	Red oak	29	4.1	Good	Good	Good	Good	Municipal	None	Preserve and protect	Has overhead tv cable wire in canopy.
330	Quercus rubra	Red oak	33	3.7	Good	Good	Good	Good	Municipal	None	Preserve and protect	Has overhead tv cable wire in canopy.
331	Quercus rubra	Red oak	25	3.1	Good	Good	Good	Good	Municipal	None		Has overhead tv cable wire in canopy.
332	Quercus rubra	Red oak	34	4.2	Good	Good	Good	Good	Municipal	None	Preserve and protect	Has overhead tv cable wire in canopy.
333	Quercus rubra	Red oak	23	3.1	Good	Good-Fair	Good	Good	Municipal	Injury due to	Preserve and protect	Will conflict with street light
										construction		
	Quercus robur	English oak	40	5.8	Good	Good	Good		Municipal	None	Preserve and protect	
	Quercus rubra	Red oak	25	4.9	Good	Good	Good	Good	Municipal	None	-	Planting bed at base
336	Quercus rubra	Red oak	25	3.6	Good	Good	Good	Good	Municipal	None	Preserve and protect	

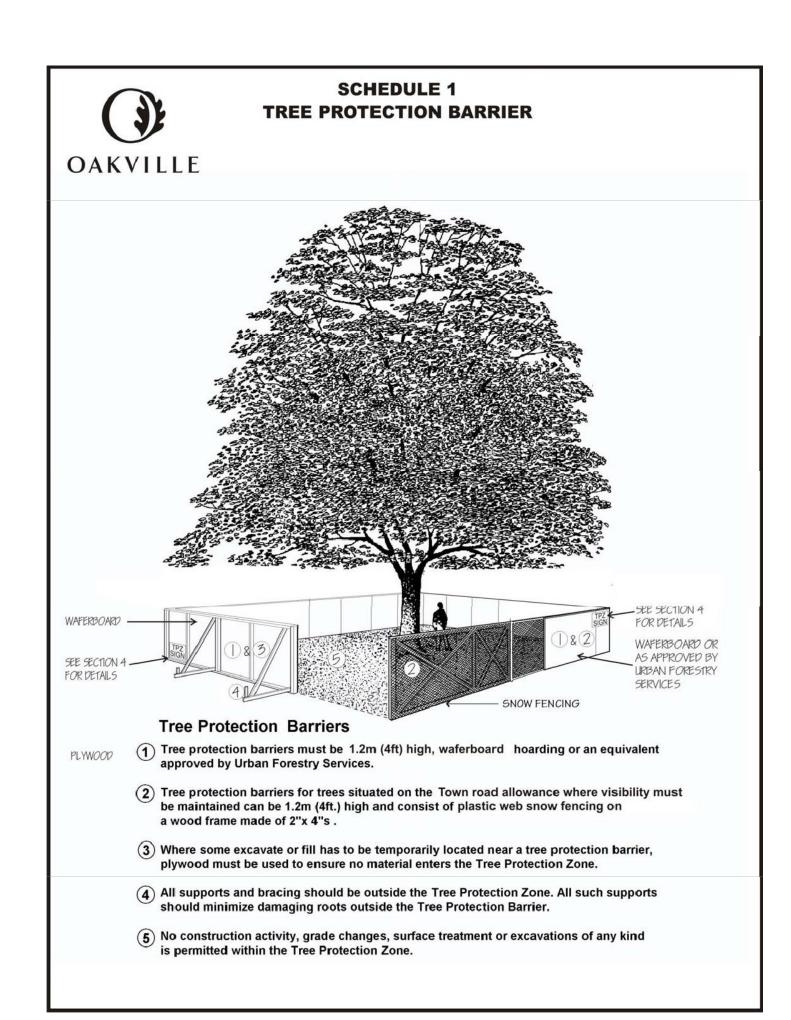

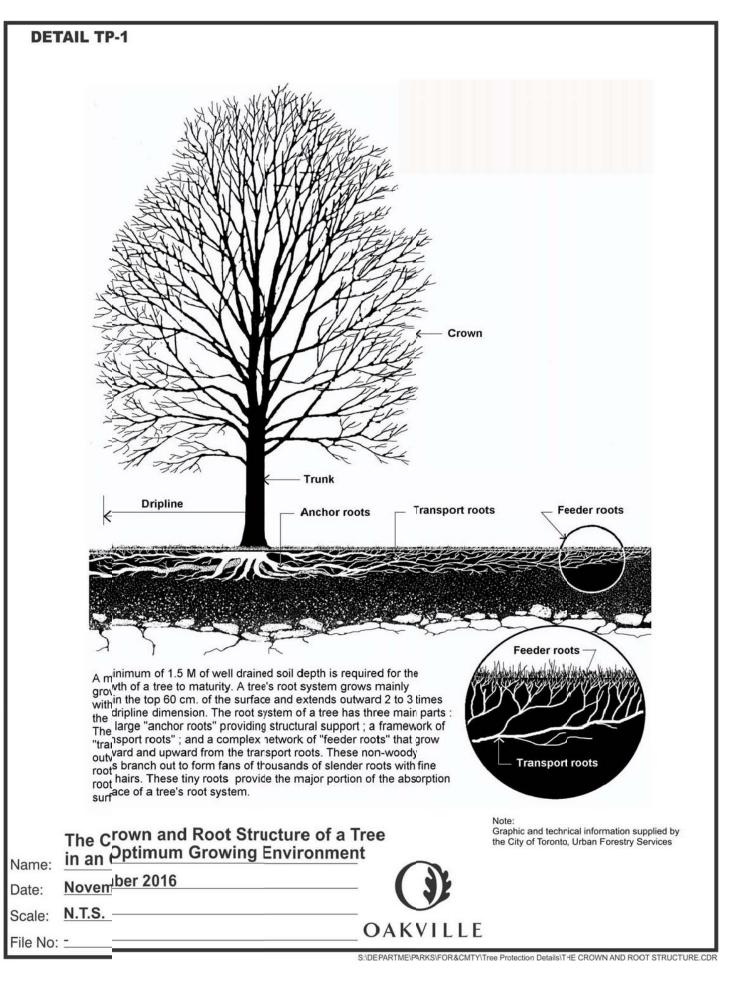

1. The Tree Protection Zone

The Tree Protection Zone (TPZ) is the minimum setback required to maintain the structural integrity of the tree's anchor roots, based on generally accepted arboricultural principles. If trees are protected to the TPZ then the tree's anchor root structure is expected to be maintained.

No unauthorized activities may take place within the TPZ of a tree covered under any municipal permit process or agreement. The following chart shows the TPZ. Some trees and site conditions may require a greater setback at the Town's discretion²

Diameter of Trunk

(DBH) ² in centimetres	Tree Protection Zone ³ Distance from trunk measured in metres
<10	1.8
10-30	2.4
31-50	3.0
51-60	3.6
61-70	4.2
71-80	4.8
81-90	5.4
91-100	6.01.
or trees over 100 cm. DI	BH, add 10 cm. to the TPZ for every one centimetre of DBH.
Poots can extend from	m the trunk to 2.3 times the distance of the drip line (see Detail TD 1 (SCHEDI II E 4) for further information)

- Roots can extend from the trunk to 2-3 times the distance of the drip line (see Detail TP-1 (SCHEDULE 4) for further information).
- Diameter at breast height (DBH) measurement of tree trunk taken at 1.37 metres above ground.
- 4. Tree Protection Zone distances are to be measured from the outside edge of the tree base towards the drip line and may be limited by an existing paved surface, provided the existing paved surface remains intact throughout the construction work.
- 2. Tree protection barriers See Schedule 1 for further information.

Trees within or adjacent to a construction site must be protected during construction by means of a barrier installed in accordance with the table in section 1 and meet the following specifications:

- a. Tree protection barriers must be erected prior to the commencement of any construction activity that may injure a tree on the site and are to remain in place throughout the entire duration of the project. The applicant shall notify the appropriate Town department in writing prior to commencing any such activities to confirm that the tree protection barriers are in place.
- b. The tree protection barriers specified herein must remain in a condition satisfactory to the Town until all site activities including landscaping are complete.
- c. Authorization from the appropriate Town department must be obtained prior to the removal of tree protection barriers.
- d. If some fill or excavated material must be temporarily located near the tree protection barrier, a wooden barrier must be used to ensure no material enters the TPZ.
- e. A sign similar to the illustration below, provided by the Town and paid for by the applicant to be mounted.

Tree Protection Zone

No grade change, storage of materials or equipment is permitted within this area.

This tree protection barrier must not be removed without the written authorization of the Town of Oakville.

Report any contraventions to Contact Name ____ Tel No. _

Unauthorized removal of the tree protection barrier or other contraventions may result in prosecution.3. Tree protection permit and or agreement - authorization from the town

For trees covered under this procedure, written authorization from the town is required in the form of either a Tree Protection Agreement, or a Tree Protection Zone Encroachment Permit or a Tree Permit; and

The applicant is required to have a town approved tree service raise the crown of all branches to provide adequate clearance for construction equipment.

3.1. Tree Protection Agreement (TPA)

The applicant is required to enter into a Tree Protection Agreement when construction activities take place outside of the TPZ area as determined by Town Forester or designate. Should the town determine that a tree protection agreement is required, a tree protection agreement fee shall be charged to the applicant in accordance with the established town fees

3.2. Tree Protection Zone Encroachment Permit (TPZEP) - Schedule 2 (Application)

- a. It is recognized that there are cases where existing or proposed utilities, capital infrastructure or buildings are located within the TPZ of a tree impacted by construction. The expectation is for the project design to respect the TPZ, however, in cases where the proposed construction impacts the area within the TPZ, the applicant shall demonstrate, with appropriate supporting documentation, that the impact on the structural integrity of the anchor roots will be within acceptable limits to avoid creating a hazardous tree.
- b. A Tree Protection Zone Encroachment Permit is required when construction activities take place within the TPZ. An Application for TPZEP must be submitted to the Town of Oakville prior to anticipated construction start date. No other permit, agreement and/or consent issued by the Town authorizes working inside the tree protection zone of a Town Tree.
- c. An arborist must be present on site at all times when work is within the TPZ. The schedule of inspections must comply with Section 7 set out herein. Above ground clearance for overhanging branches in the work zone must be taken into consideration. The applicant is required to have a Town approved tree service raise the crown of all branches to provide adequate clearance for construction equipment.
- d. The Town specifies the non-invasive methods of excavation including but not limited to air spade, hydro vac, hand digging to minimize the damage to the health and structure of the trees.
- e. Root pruning in open trench methods of construction is required under the direction of and along with written approval of an arborist. The objective is to minimize severance of anchor roots, which provide upright support for the tree, thereby minimizing potential hazards.
- f. Emergency repairs due to underground utilities are permitted to commence immediately. However, the utility company concerned is responsible for notifying the Town as soon as possible when Town trees are involved.
- Where the impact on the structural integrity of anchor roots is beyond acceptable limits and may cause a hazardous tree:
- a. the tree may be removed in accordance with the applicable by-law; or
- b. in the case of a town tree, the applicant shall bear the cost of the tree and stump removal as well as payment of the amenity value of the tree as calculated in accordance with the most recent International Society of Arboriculture's Guide for Plan Appraisal.

OAKVILLE

Town of Oakville Transportation and Engineering


COPYRIGHT

This drawing has been prepared solely for the intended use, thus any reproduction or distribution for any purpose other than authorized by IBI Group is forbidden. Written dimensions shall have precedence over scaled dimensions. Contractors shall verify and be responsible for all dimensions and conditions on the job, and IBI Group shall be informed of any variations from the dimensions and conditions shown on the drawing. Shop drawings shall be submitted to IBI Group for general conformance before proceeding with fabrication.

IBI Group Professional Services (Canada) Inc.

ISSUE	S	
No.	DESCRIPTION	DATE
1	FOR 30% SUBMISSION	2022-04-26

KEY PLAN

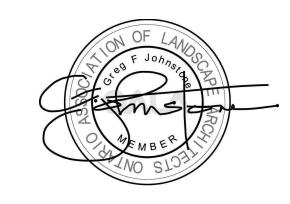

ISA-ON-1016A

SITE PLAN NUMBER

PRIME CONSULTANT IBI GROUP

Suite 101 - 410 Albert Street Waterloo ON N2L 3V3 Canada tel 519 585 2255 ibigroup.com

TRAFFIC CALMING INFRASTRUCTURE

PROJECT NO: 142042

DRAWN BY: CHECKED BY: PROJECT MGR: APPROVED BY:

SHEET TITLE

TREE PRESERVATION DETAIL

SHEET NUMBER

TPP-6

