

TREE PROTECTION HOARDING DETAIL
OT OAKVILLE CITY STANDARD

N.T.S.

Tree ID	Common Name	Scientific Name	DBH (cm)	Effective DBH (cm)	Dripline (m)	Condition			TPZ (m)	Proposed Action
				, ,		Structure Vigour Overall				
215	Blue Spruce	Picea pungens	18	18	2	G	G	G	2.4	Retain
216	Blue Spruce	Picea pungens	18	18	2	G	G	G	2.4	Retain
217	Blue Spruce	Picea pungens	19	19	2	G	F	F	2.4	Retain
218	Blue Spruce	Picea pungens	25	25	3	G	F	G	2.4	Retain
219	Norway Maple	Acer platanoides	26	26	3	G	G	G	2.4	Retain
220	Norway Maple	Acer platanoides	30	30	4	G	F	G	2.4	Retain
221	Blue Spruce	Picea pungens	27	27	3	G	G	G	2.4	Retain
222	Norway Spruce	Picea abies	21	21	3	G	G	G	2.4	Retain
223	Norway Spruce	Picea abies	21	21	4	G	G	G	2.4	Remove
224	Blue Spruce	Picea pungens	26	26	4	G	G	G	2.4	Retain
225	White Pine	Pinus strobus	27	27	3	G	G	G	2.4	Retain
226	White Pine	Pinus strobus	13,16	21	4	G	G	G	2.4	Retain
227	White Pine	Pinus strobus	22	22	4	G	G	G	2.4	Retain
228	White Pine	Pinus strobus	32	32	4	G	G	G	3.0	Retain
229	Trembling Aspen	Populus tremuloides	25,29	38	3	G	Р	F	3.0	Retain
230	Trembling Aspen	Populus tremuloides	16,32,30	47	4	G	G	G	3.0	Retain
231	Trembling Aspen	Populus tremuloides	18,23,22	43	3	G	F	F	3.0	Retain
232	Trembling Aspen	Populus tremuloides	26,18	32	4	G	G	G	3.0	Retain
233	Blue Spruce	Picea pungens	14	14	2	G	G	G	2.4	Retain
234	Green Ash	Fraxinus pennsylvanica	14	14	3	G	G	G	2.4	Remove
235	Blue Spruce	Picea pungens	13	13	1	G	F	F	2.4	Remove
236	Green Ash	Fraxinus pennsylvanica	15,12	19	2	F	P	P	2.4	Remove
237	Green Ash	Fraxinus pennsylvanica	12	12	2	F	Р	F	2.4	Remove
238	Green Ash	Fraxinus pennsylvanica	10	10	2	Р	Р	Р	2.4	Remove
239	Green Ash	Fraxinus pennsylvanica	16	16	3	F	G	G	2.4	Remove
240	White Spruce	Picea glauca	18	18	4	G	G	G	2.4	Retain
241	Bur Oak	Quercus macrocarpa	10	10	2	G	G	G	2.4	Retain
242	Green Ash	Fraxinus pennsylvanica	26,26,24	44	1	P	VP	VP	3.0	Retain
243	Red Oak	Quercus rubra	10	10	3	G	G	G	2.4	Retain
244	Green Ash	Fraxinus pennsylvanica	16,8	18	1	VP	VP	VP	2.4	Retain
245	Green Ash	Fraxinus pennsylvanica	30	30	0	D	D	D	2.4	Retain
246	Red Oak	Quercus rubra	24	24	4	G	G	G	2.4	Retain
247	Bur Oak	Quercus macrocarpa	17	17	4	G	G	G	2.4	Retain
248	Bur Oak	Quercus macrocarpa	26,21	33	4	G	G	G	3.0	Retain
249	Bur Oak	Quercus macrocarpa	45	45	4	G	F	F	3.0	Retain
250	Bur Oak	Quercus macrocarpa	20	20	0	D	D	D	2.4	Retain
251	Bur Oak	Quercus macrocarpa	21	21	4	F	F	F	2.4	Retain
252	Red Oak	Quercus rubra	24,24	34	3	G	G	G	3.0	Retain
253	Bur Oak	Quercus macrocarpa	24	24	3	G	G	G	2.4	Retain
254	Bur Oak	Quercus macrocarpa	32	32	0	D	D	D	3.0	Retain
255	Bur Oak	Quercus macrocarpa	26,15	30	4	Р	G	F	2.4	Retain
256	Red Oak	Quercus rubra	40	40	4	G	G	G	3.0	Retain
257	White Pine	Pinus strobus	24	24	3	G	G	G	2.4	Retain
258	White Pine	Pinus strobus	23	23	4	G	G	G	2.4	Retain
259	White Pine	Pinus strobus	12	12	2	G	G	G	2.4	Retain
260	White Pine	Pinus strobus	24	24	3	G	G	G	2.4	Retain
261	Silver Maple	Acer saccharinum	28,26	38	5	G	G	G	3.0	Retain
262	Silver Maple	Acer saccharinum	28,20	28	3	G	G	G	2.4	Retain
263	Silver Maple	Acer saccharinum	24,28,14	39	4	G	G	G	3.0	Retain
264	Norway Spruce	Picea abies	32	32	4	G	G	G	3.0	Retain
265	Norway Spruce	Picea abies	25	25	4	G	G	G	2.4	Potential Inju
266	Norway Spruce	Picea abies	22,22	31	4	G	G	G	3.0	Remove
267	Norway Spruce	Picea abies	26	26	4	G	G	G	2.4	Remove

OWNER

Halton
REGION

VERTECHS DESIGN landscape architects

Project Name:

Halton WWTP Maint Facility

2195 North Service Rd W, Oakville, ON

Number:

2102

Sheet Title:

TREE INVENTORY,
PRESERVATION AND
REMOVALS PLAN

Scale: 1:300

Drawn: JJ / IW / RM / YC

Checked: VK / JJ

Date: 2022-08-11

Legend:

PROPERTY LINE

TREE PROTECTION

EXISTING
DECIDUOUS TREE

EXISTING
CONIFER TREE
TO REMOVE

EXISTING
CONIFEROUS TREE
TO REMAIN

TO REMAIN

EXISTING TREE
TO REMAIN

TREE NUMBER

310


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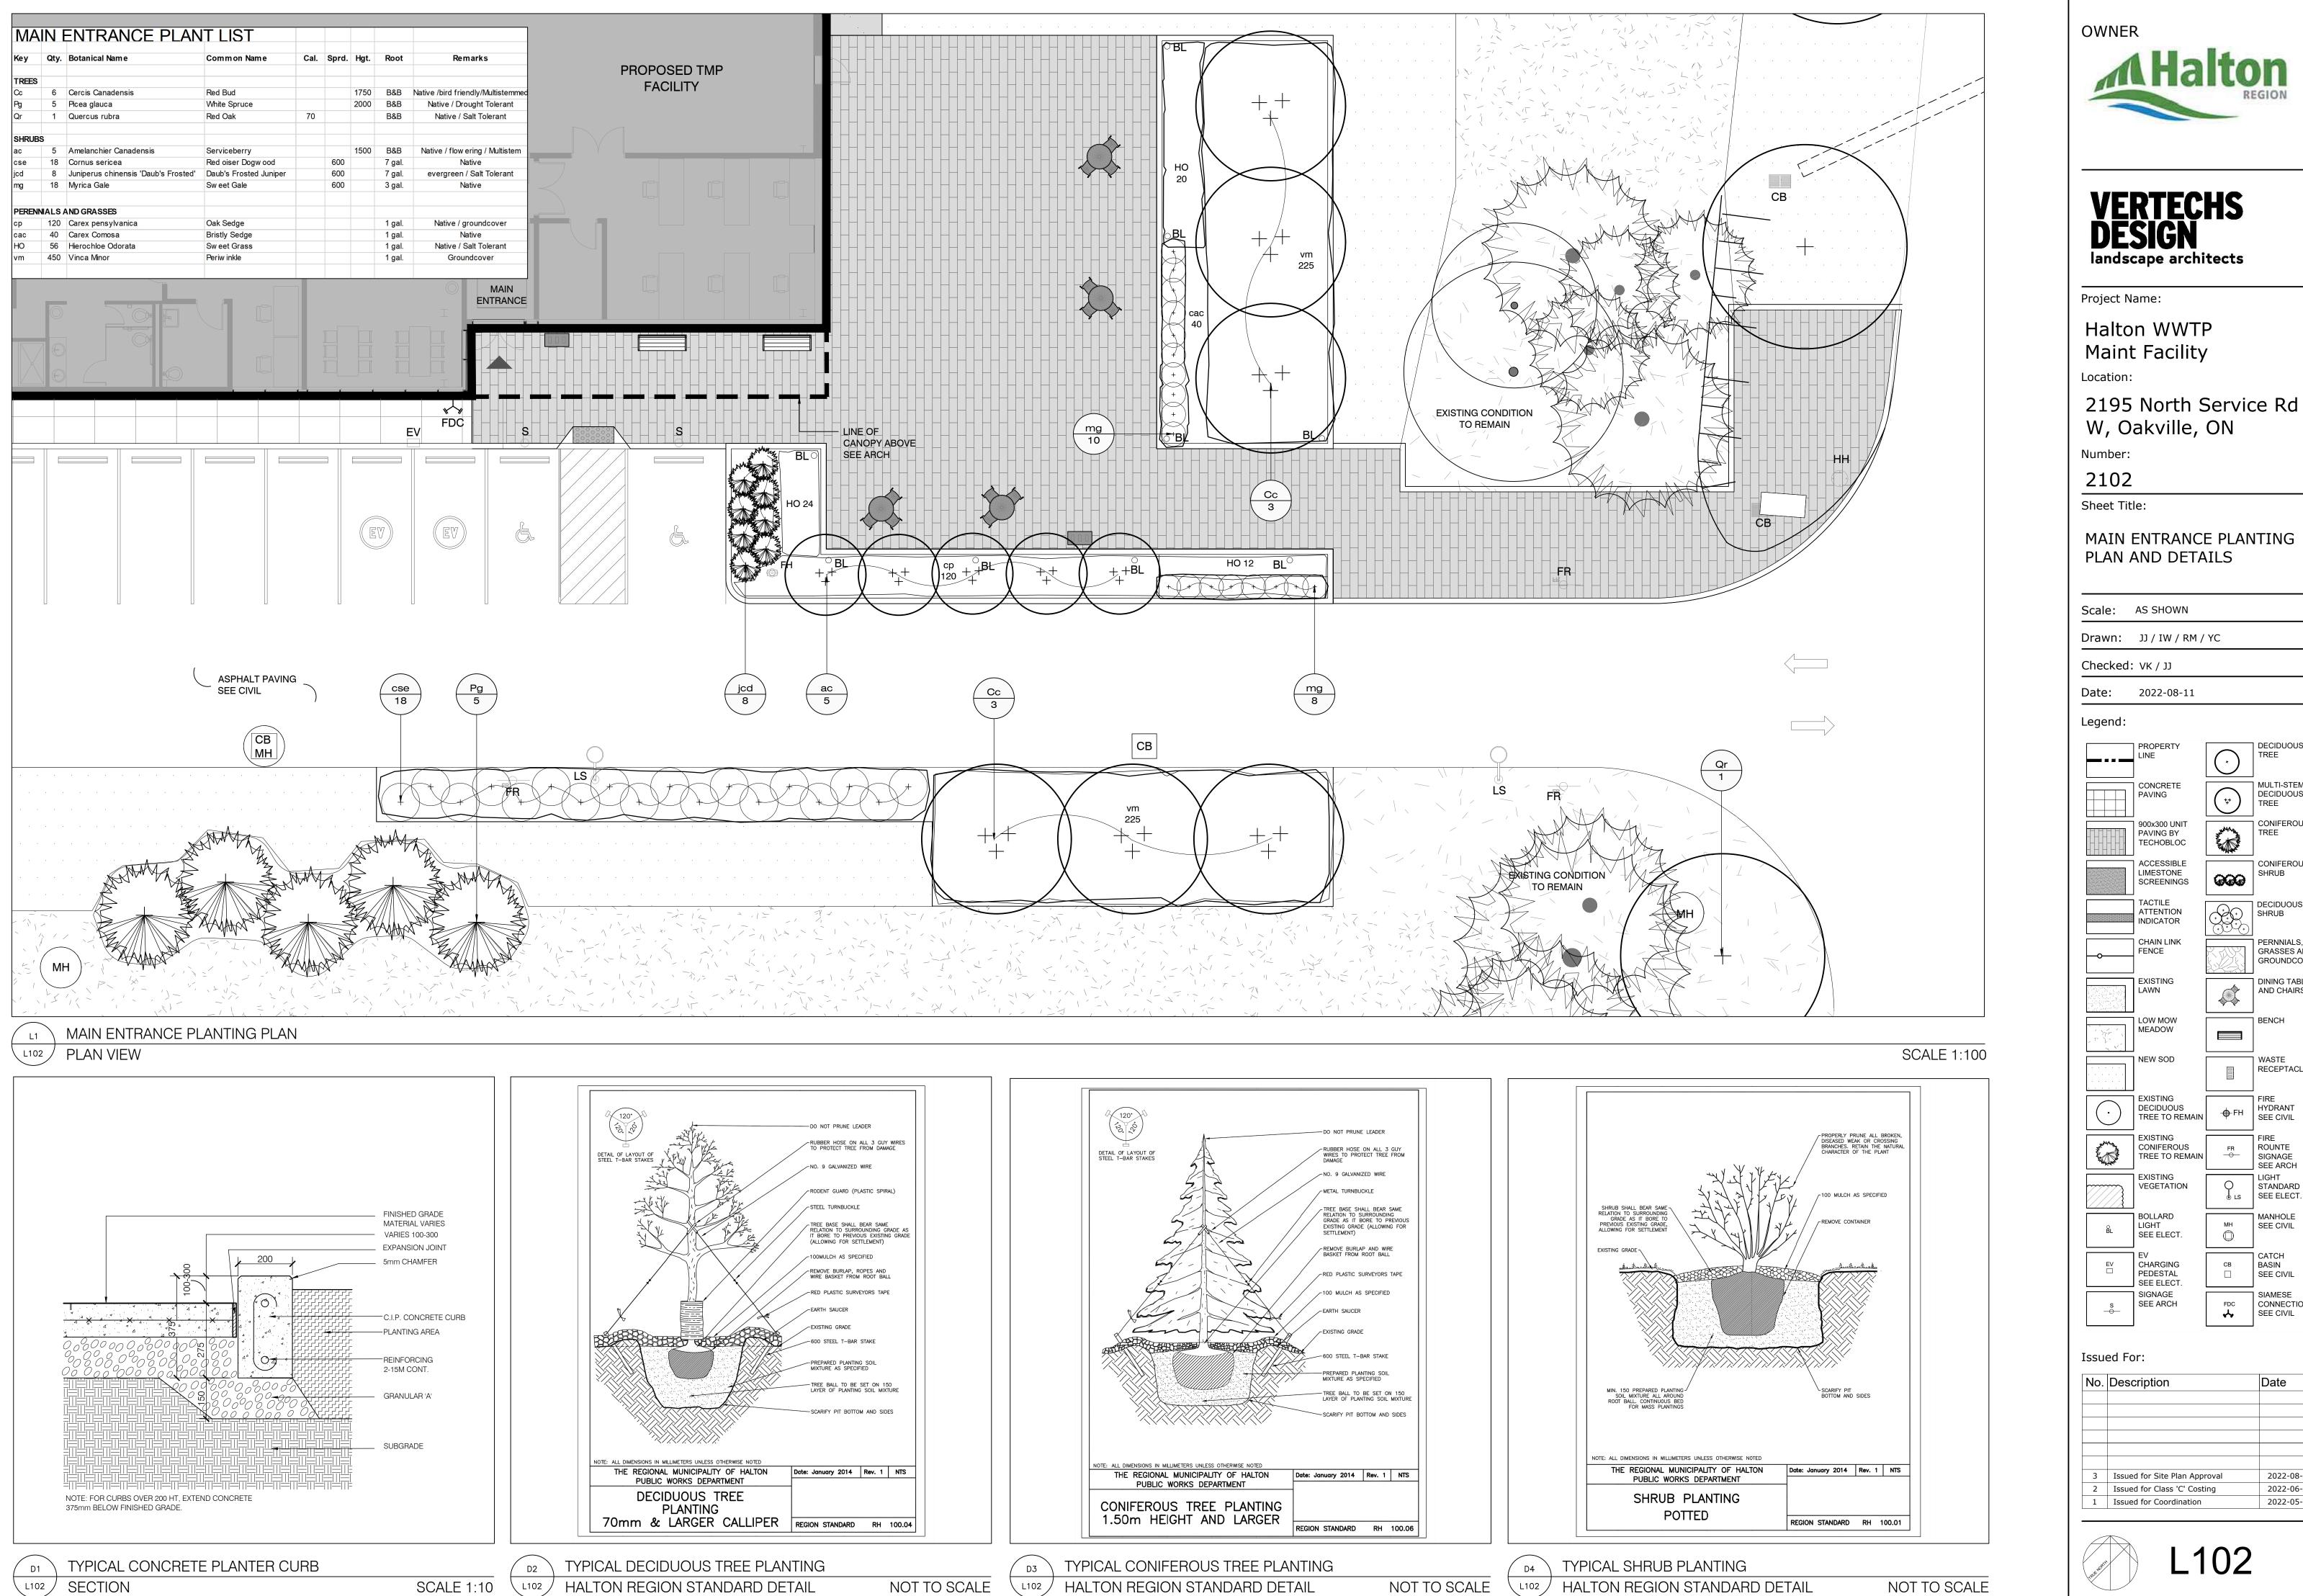
No.	Description	Date			
3	Issued for Site Plan Approval	2022-08-12			
2	Issued for Class 'C' Costing	2022-06-16			
1	Issued for Coordination	2022-05-25			



L100T

www.pecg.ca Dated: July 28, 2022



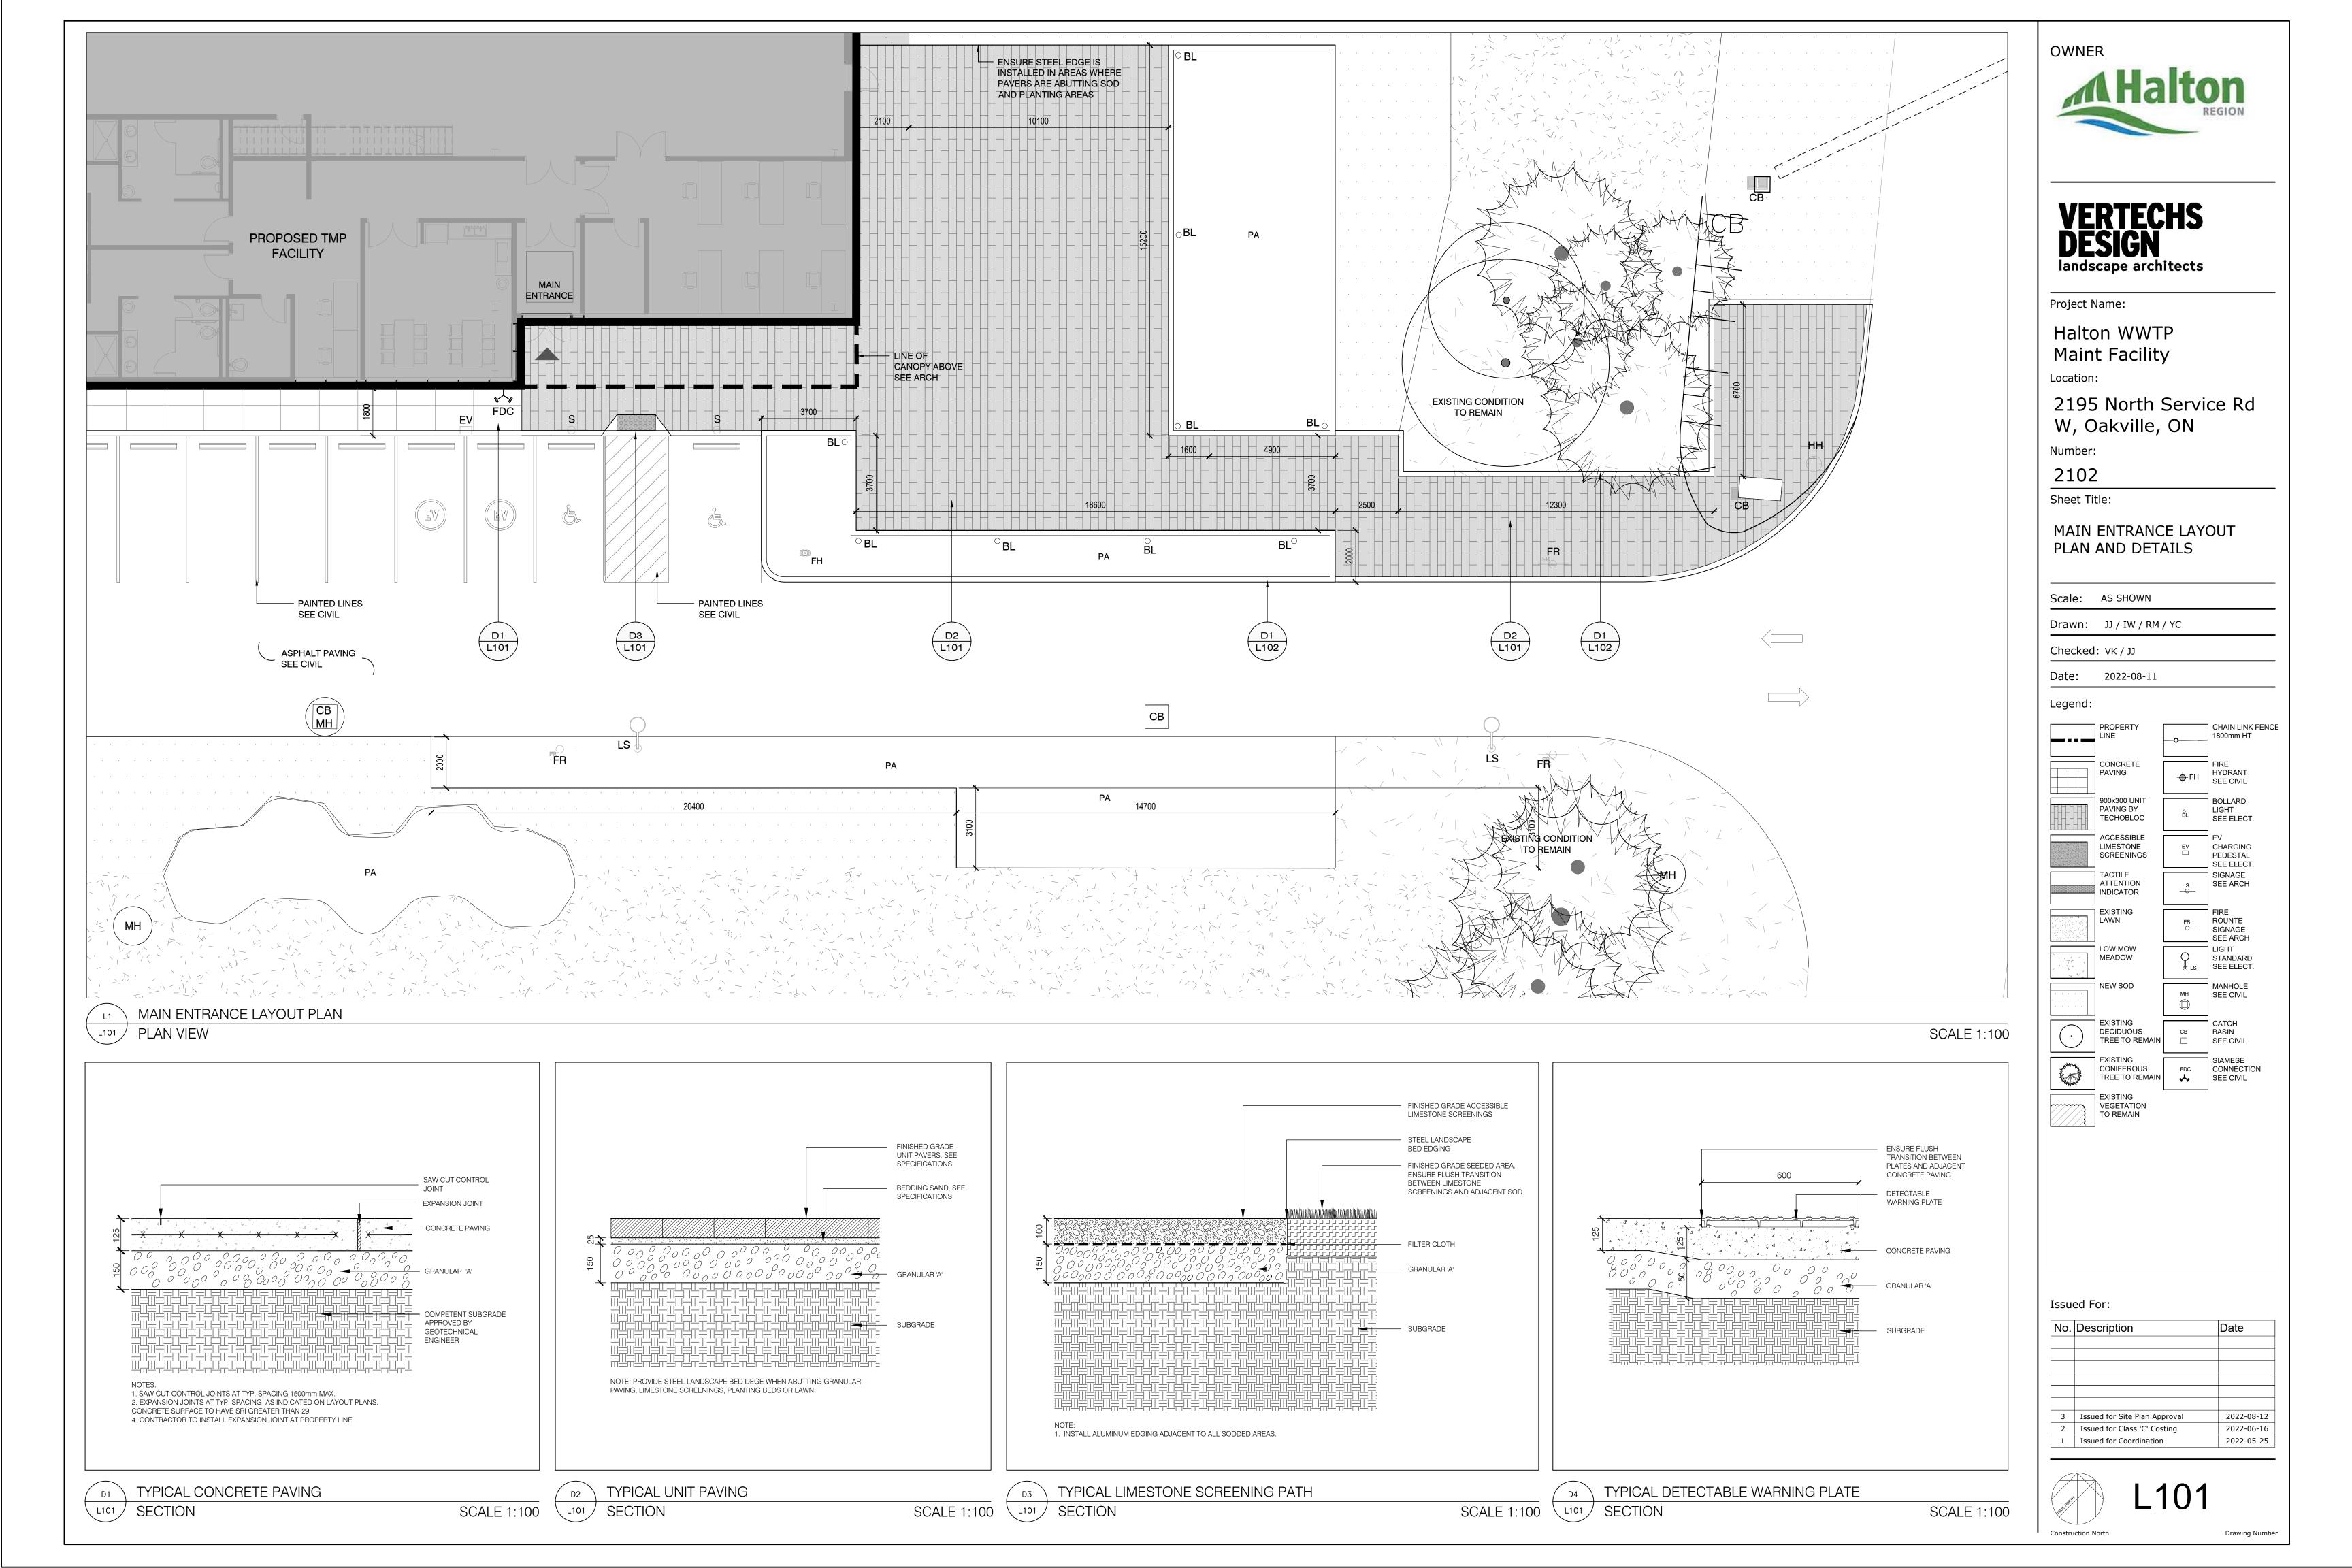

Construction North

Drawing Number

MULTI-STEMMED

DECIDUOUS

CONIFEROUS

CONIFEROUS

GRASSES AND GROUNDCOVERS

DINING TABLE

AND CHAIRS

RECEPTACLE

HYDRANT

SEE CIVIL

SIGNAGE SEE ARCH

STANDARD

SEE ELECT.

MANHOLE

SEE CIVIL

SEE CIVIL

SIAMESE

从

CONNECTION SEE CIVIL


2022-08-12


2022-06-16

2022-05-25

BENCH

SHRUB

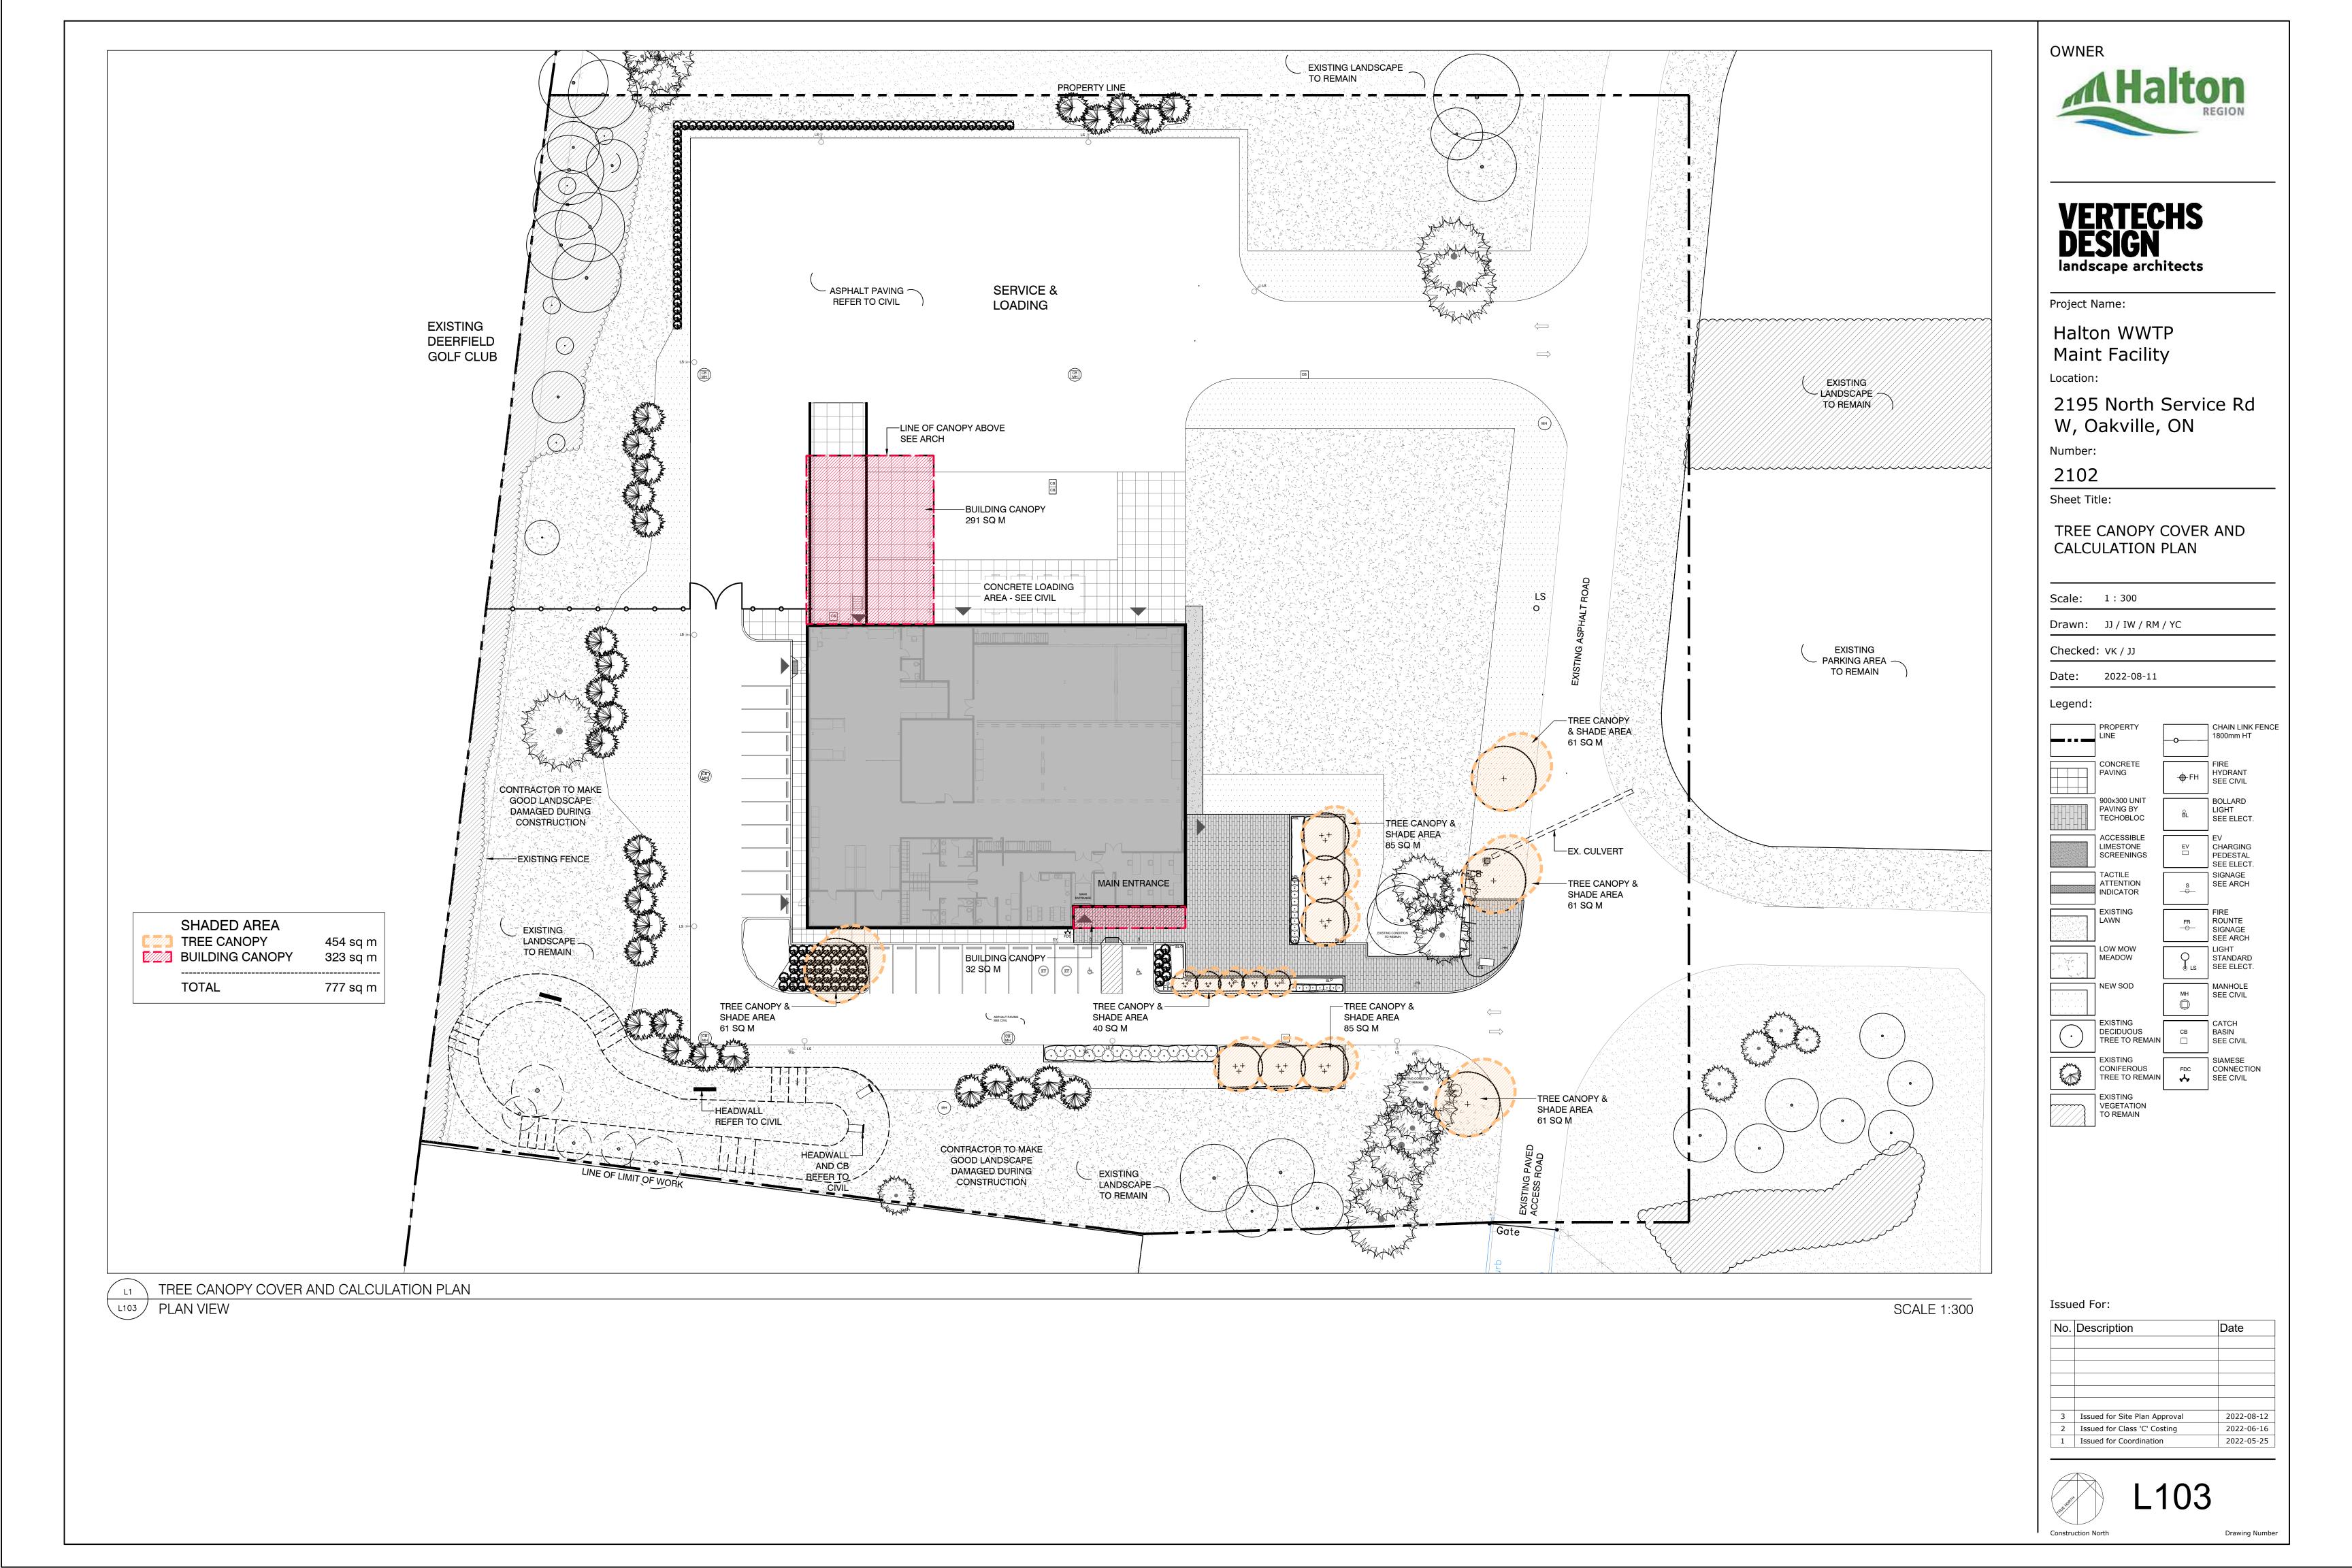

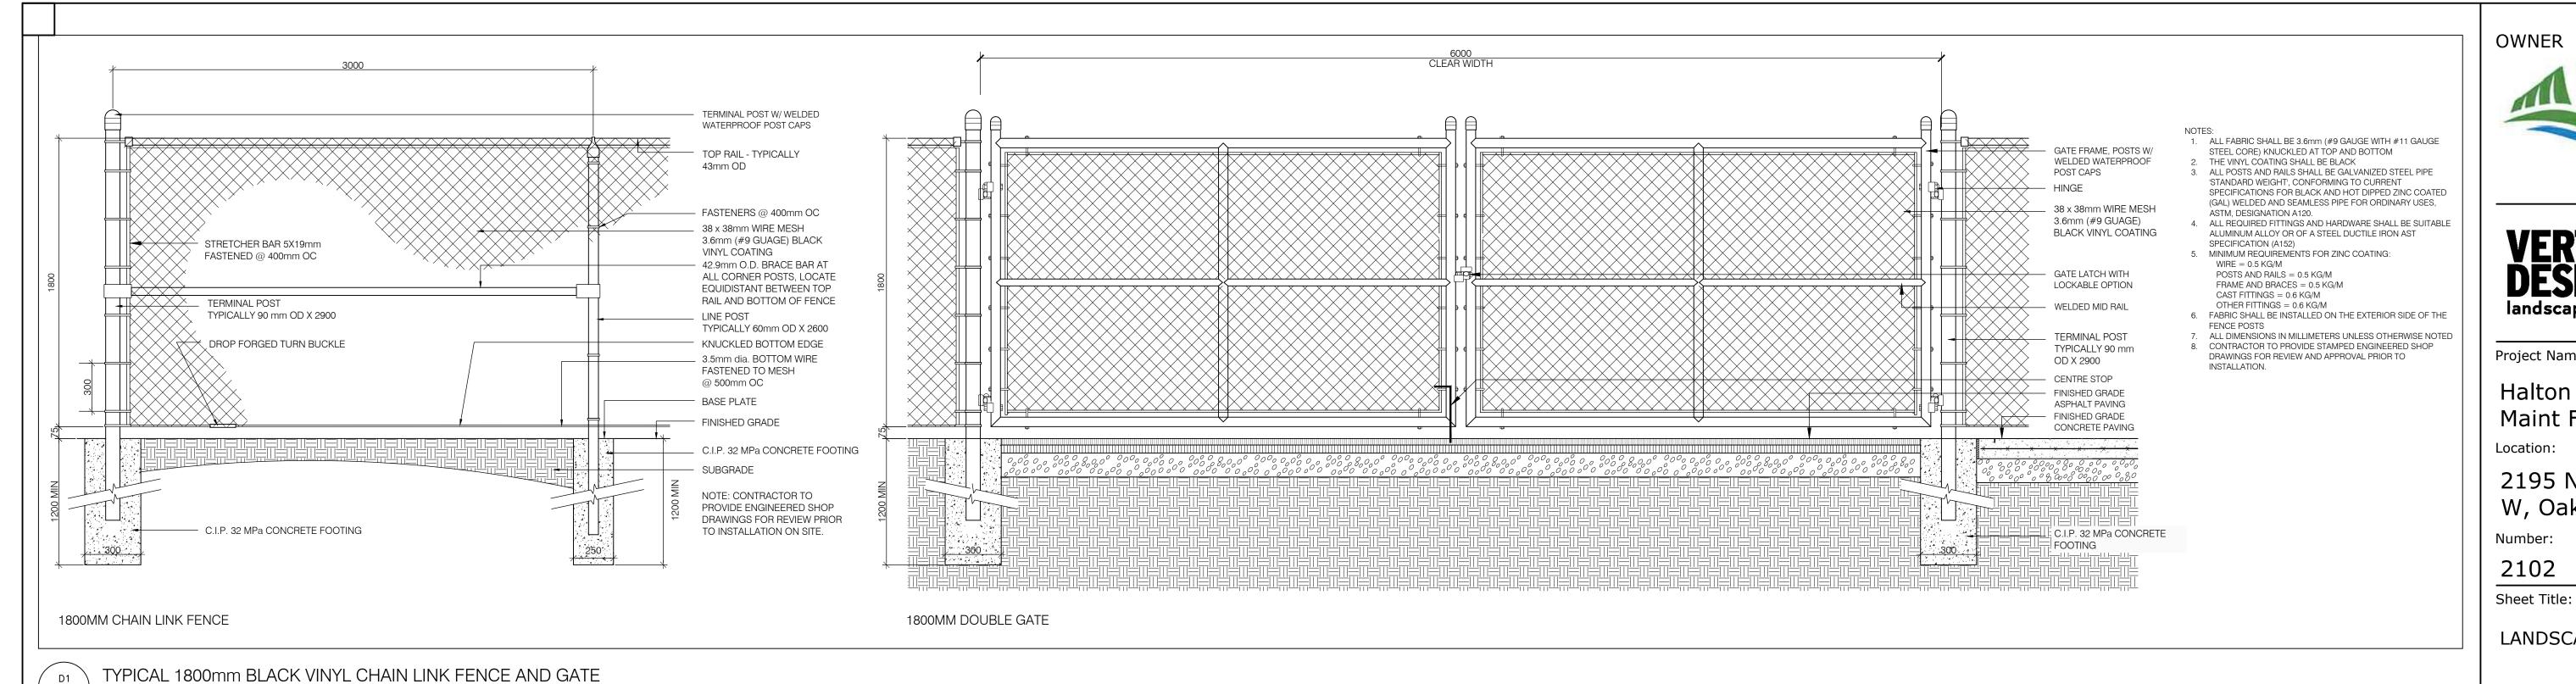

L200 SECTION

OWNER

VERTECHS DESIGN landscape architects

Project Name:

Halton WWTP Maint Facility

2195 North Service Rd W, Oakville, ON

Number:

SCALE 1:20

2102

Scale: AS SHOWN

LANDSCAPE DETAILS

Drawn: JJ / IW / RM / YC Checked: VK / JJ Date: 2022-08-11 Legend: MULTI-STEMMED CONCRETE DECIDUOUS PAVING CONIFEROUS 900x300 UNIT PAVING BY ACCESSIBLE CONIFEROUS SHRUB LIMESTONE SCREENINGS ATTENTION INDICATOR FENCE GRASSES AND GROUNDCOVERS EXISTING DINING TABLE AND CHAIRS LAWN LOW MOW BENCH MEADOW NEW SOD WASTE RECEPTACLE DECIDUOUS TREE TO REMAIN + FH | HYDKAN I SEE CIVIL HYDRANT FR ROUNTE SIGNAGE CONIFEROUS TREE TO REMAIN SEE ARCH LIGHT STANDARD SEE ELECT. VEGETATION MANHOLE MH SEE CIVIL LIGHT SEE ELECT. CATCH PEDESTAL SEE CIVIL SIAMESE SIGNAGE FDC CONNECTION SEE CIVIL SEE ARCH Issued For:

Issued for Coordination

No. Description

3 Issued for Site Plan Approval

2 Issued for Class 'C' Costing

Drawing Number

2022-08-12

2022-06-16 2022-05-25