


North Elevation 1:200

	2200	MPH ROOF 68.80 249.00
RESIDENTIAL ROOF		MPH_Mezz. <u>66.30</u> 246.50 MPH <u>62.80</u>
	5500	243.00
		LEVEL <u>20</u> 57.30 237.50
	7	$\underbrace{LEVEL}_{234.55} \underbrace{19}_{234.55}$
		LEVEL <u>18 (51.40</u> 231.60 LEVEL <u>17 (48.45</u> 228.65
	2950	LEVEL 16 45.50 225.70
	5950	LEVEL 15 42.55 222.75
	3C5	LEVEL <u>14 39.60</u> 219.80
		LEVEL <u>13 36.65</u> 216.85
		LEVEL <u>12 33.40</u> 213.60
	950 <u>-</u>	LEVEL <u>11 (30.45)</u> 210.65
RESIDENTIAL ROOF	2950	LEVEL <u>10 27.50</u> 207.70
		LEVEL <u>09</u> <u>24.55</u> 204.75
	2950 2950	$\underbrace{LEVEL}_{08} \underbrace{08}_{21.30}$
		LEVEL 07 18.35 198.55 LEVEL 06 15.40 195.60
		LEVEL 05 (12.45) 192.65
		LEVEL 04 9.50 189.70
		LEVEL <u>03 6.55</u> 186.75
		LEVEL <u>02 3.60</u> 183.80
	ළ FFE <u>180.20</u>	LEVEL 01 0.00 180.20

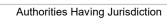

Revisions:

Date:

Date:

Client:

Drawing Title:

Scale:

Drawn by:

JS Checked by:

VPS


Project No.: 21027 Date:

Drawing No.:

June 23, 2022

As indicated

BRANTHAVEN

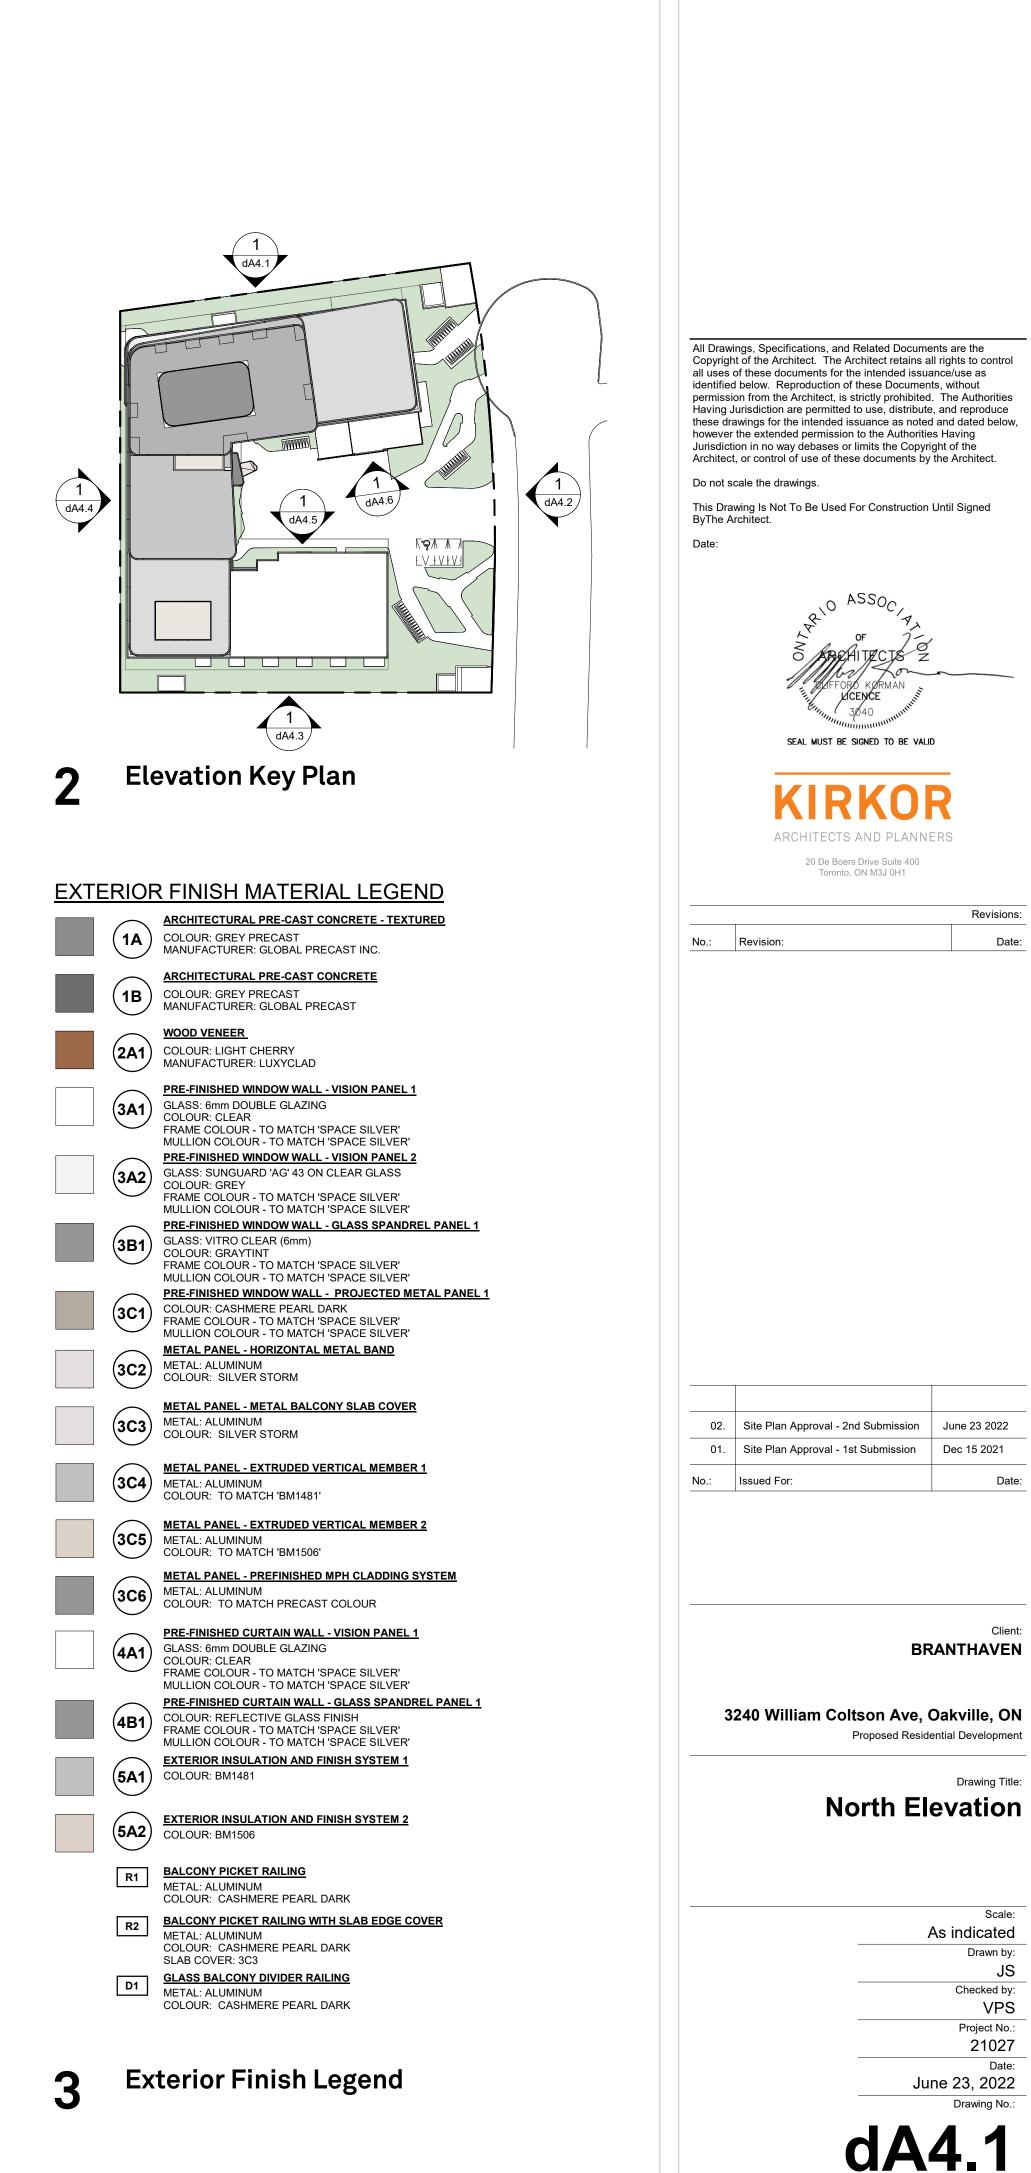





			MPH ROOF 68.80 249.00
			MPH Mezz. <u>66.30</u> 246.50
	RESIDENTIAL ROOF		MPH 62.80 243.00
		5500	
			LEVEL 20 (57.30) 237.50
			LEVEL 19 54.35 234.55
			LEVEL 18 51.40 231.60
			LEVEL 17 (48.45)
		2950	LEVEL 16 (45.50)
			225.70
			LEVEL 15 (42.55) 222.75
			LEVEL 14 (39.60) 219.80
			LEVEL 13 (36.65) 216.85
		3550	LEVEL 12 33.40
		2950	213.60 LEVEL 11 30.45
			210.65
			LEVEL 10 (27.50) 207.70
			LEVEL 09 (24.55) 204.75
			LEVEL 08 (21.30) 201.50
			LEVEL 07 (18.35) 198.55
			LEVEL 06 15.40
		5350	195.60 LEVEL 05 12.45
			192.65
			LEVEL 04 (9.50) 189.70
			LEVEL 03 6.55 186.75
		00 00 N 3B1	LEVEL 02 3.60 183.80
		⁰⁰ ⁰⁰ ⁰⁰ ⁰⁰ ¹⁰ ¹⁰ ¹⁰ ¹⁰	LEVEL 01 0.00 FE - 180.20 180.20


		Authorities Having Jurisdiction
1 (1) (AA4.4) 2	<image/> <image/> <section-header></section-header>	Authorities Having Jurisdiction Jurisdiction To reacible the drawings Dister Correction Correction
	 (3A2) PRE-FINISHED WINDOW WALL - VISION PANEL 2 GLASS: SUNGUARD 'AG' 43 ON CLEAR GLASS COLOUR: GREY FRAME COLOUR - TO MATCH 'SPACE SILVER' MULLION COLOUR - TO MATCH 'SPACE SILVER' MULLION COLOUR - TO MATCH 'SPACE SILVER' GLASS: VITRO CLEAR (6mm) COLOUR: GRAYTINT FRAME COLOUR - TO MATCH 'SPACE SILVER' MULLION COLOUR - TO MATCH 'SPACE SILVER' MULLION COLOUR - TO MATCH 'SPACE SILVER' 	
	3C1 PRE-FINISHED WINDOW WALL - PROJECTED METAL PANEL 1 COLOUR: CASHMERE PEARL DARK FRAME COLOUR - TO MATCH 'SPACE SILVER' MULLION COLOUR - TO MATCH 'SPACE SILVER' METAL PANEL - HORIZONTAL METAL BAND METAL: ALUMINUM COLOUR: SILVER STORM	
	(3C3) METAL: ALUMINUM COLOUR: SILVER STORM	02. Site Plan Approval - 2nd Submission June 23 2022 01. Site Plan Approval - 1st Submission Dec 15 2021
	(3C4) METAL: ALUMINUM COLOUR: TO MATCH 'BM1481'	No.: Issued For: Date:
	METAL PANEL - EXTRUDED VERTICAL MEMBER 2 METAL: ALUMINUM COLOUR: TO MATCH 'BM1506'	
	(3C6) METAL PANEL - PREFINISHED MPH CLADDING SYSTEM METAL: ALUMINUM COLOUR: TO MATCH PRECAST COLOUR	
	(4A1) GLASS: 6mm DOUBLE GLAZING COLOUR: CLEAR FRAME COLOUR - TO MATCH 'SPACE SILVER'	Client: BRANTHAVEN
	(4B1) FRAME COLOUR - TO MATCH 'SPACE SILVER' MULLION COLOUR - TO MATCH 'SPACE SILVER' PRE-FINISHED CURTAIN WALL - GLASS SPANDREL PANEL 1 COLOUR: REFLECTIVE GLASS FINISH FRAME COLOUR - TO MATCH 'SPACE SILVER' MULLION COLOUR - TO MATCH 'SPACE SILVER'	3240 William Coltson Ave, Oakville, ON Proposed Residential Development
	(5A1) EXTERIOR INSULATION AND FINISH SYSTEM 1 COLOUR: BM1481	
	5A2 EXTERIOR INSULATION AND FINISH SYSTEM 2 COLOUR: BM1506	East Elevation
	R1 BALCONY PICKET RAILING METAL: ALUMINUM COLOUR: CASHMERE PEARL DARK	
	BALCONY PICKET RAILING WITH SLAB EDGE COVER METAL: ALUMINUM COLOUR: CASHMERE PEARL DARK	Scale: As indicated
	SLAB COVER: 3C3 D1 GLASS BALCONY DIVIDER RAILING METAL: ALUMINUM	Drawn by: JS Checked by:
•	COLOUR: CASHMERE PEARL DARK	VPS Project No.: 21027 Date:
3	Exterior Finish Legend	June 23, 2022 Drawing No.:
		dA4.2




South Elevation

1:200



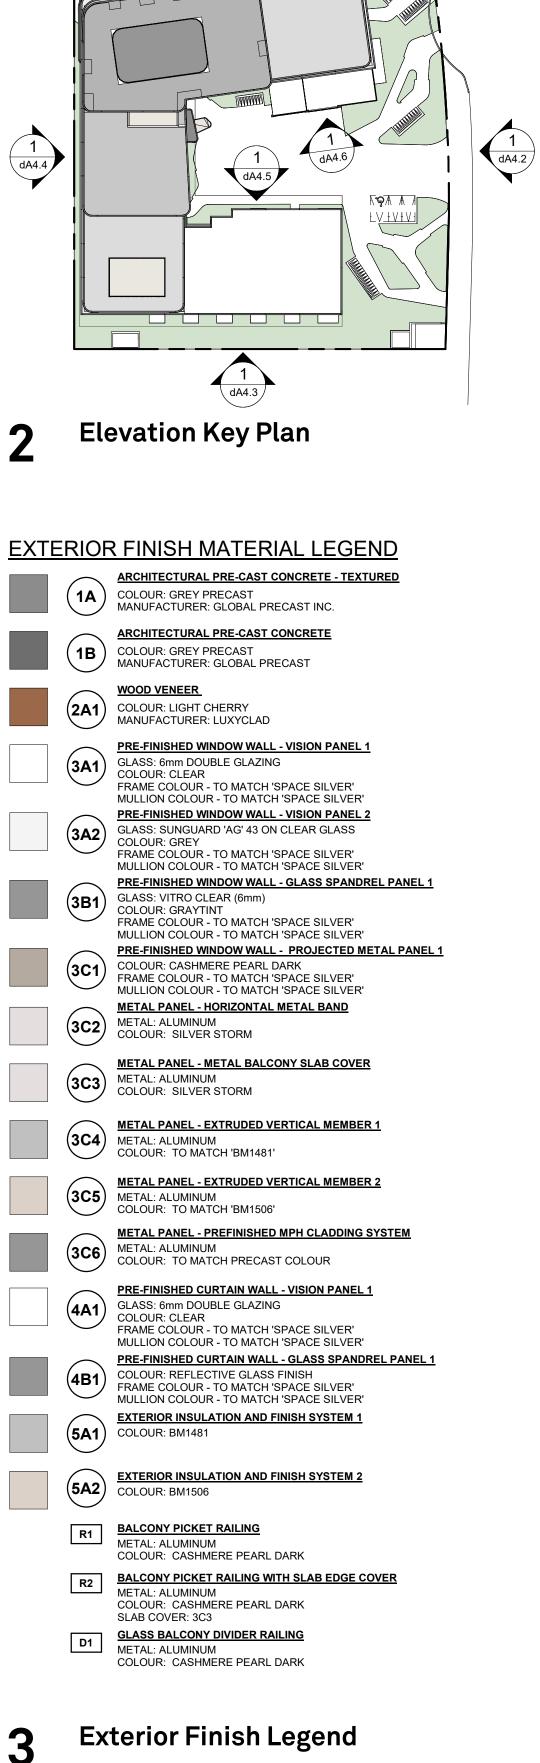


dA4.3

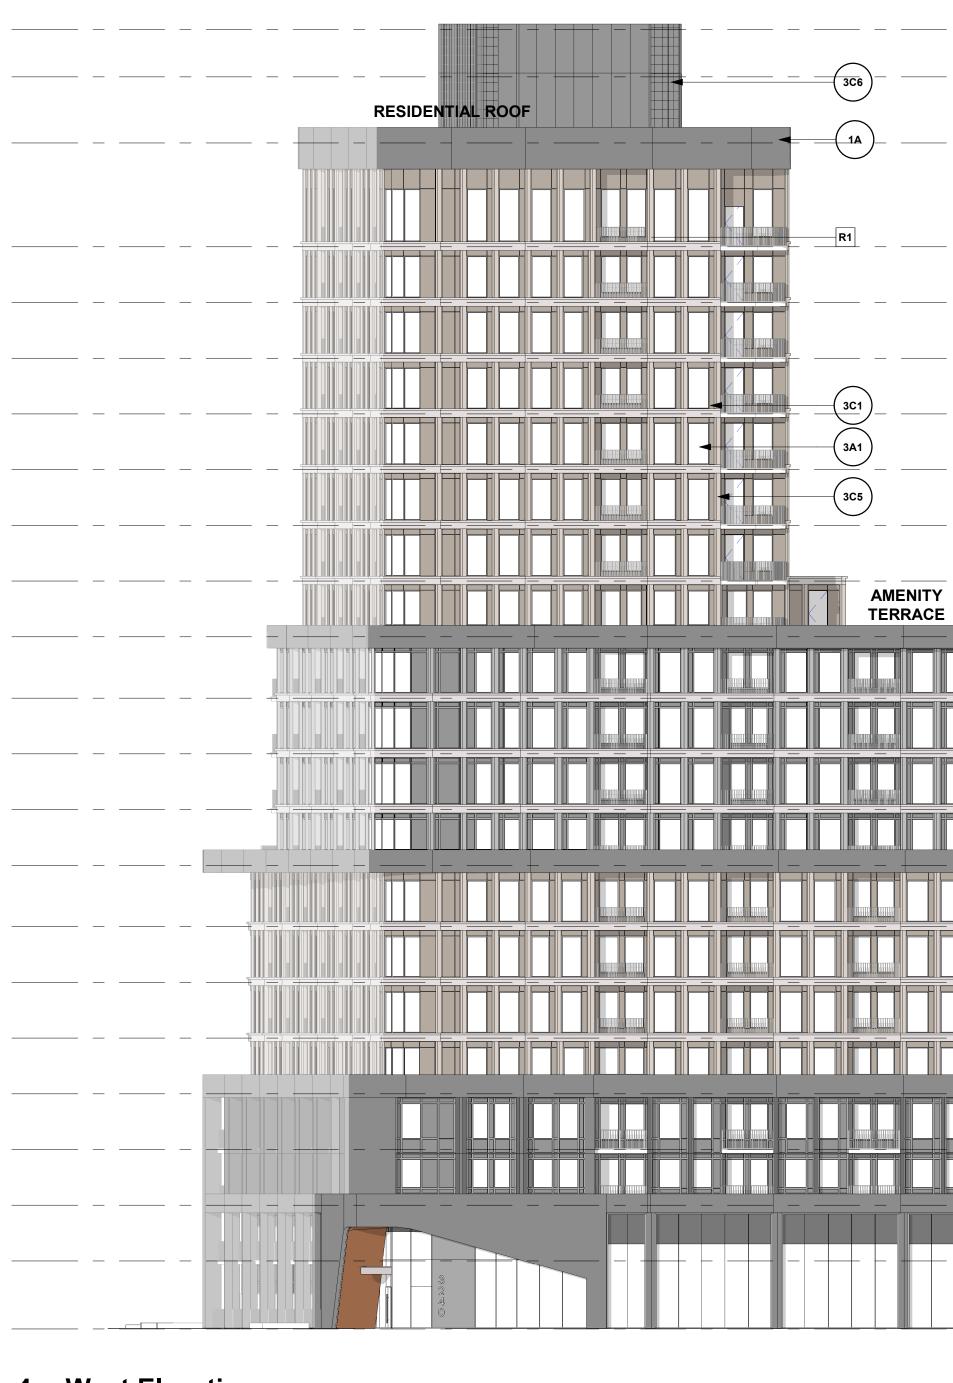

West Elevation 1:200

	 	MPH ROOF 68.80
	2500	MPH Mezz. 66.30
	3200	246.50
	I	MPH 62.80
		243.00
	2500	
	 +	LEVEL 20 57.30 237.50
	2950	\frown
		LEVEL 19 (54.35) 234.55
	³ 	LEVEL 18 231.60
		\frown
		LEVEL 17 (48.45) 228.65
	5950	LEVEL 16
	2950	225.70
	− I −	LEVEL 15 (42.55) 222.75
	5950	LEVEL 14 (39.60)
	5950	219.80
		LEVEL 13 36.65 216.85
3B1	3250	
		LEVEL 12 (33.40) 213.60
3A2	5950	LEVEL 11 (30.45)
	2950	210.65
	_	LEVEL 10 (27.50) 207.70
	5350	LEVEL 09 24.55
	3C5	204.75
		LEVEL 08 21.30 201.50
	\sim - $-$ - \rightarrow	LEVEL 07 (18.35) 198.55
	- 3A1	LEVEL 06
	2950	195.60
		LEVEL 05 (12.45) 192.65
	3B1	LEVEL 04
		189.70
		LEVEL 03 6.55 186.75
		LEVEL 02 (3.60)
	4A1 0000	183.80
	FFE 180.20	LEVEL 01 0.00
	K	180.20

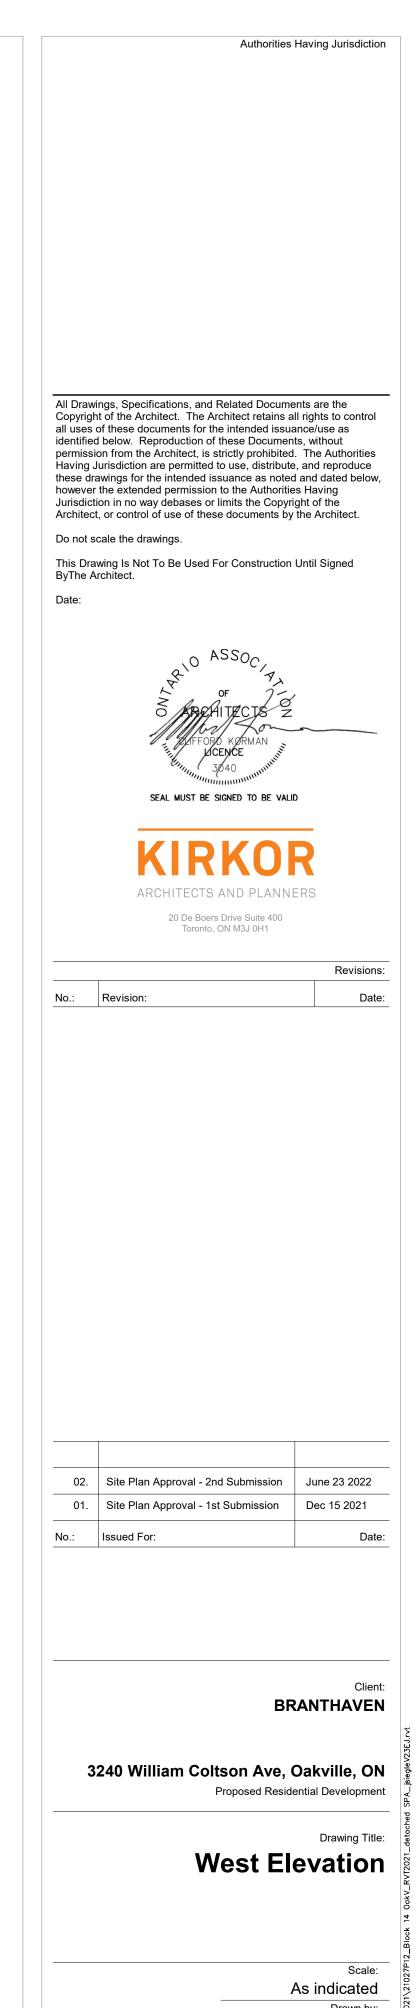

Drawn by: JS

> Checked by: VPS Project No.: 21027

Date: June 23, 2022 Drawing No.:



