BRONTE ROAD **FUTURE** DEVELOPMENT ① EXISTING RESIDENTIAL NATURALIZATION WORKS - SUBMITTED IN SEPARATE PACKAGE (LN1-LN8) BRONTE CREEK PROVINCIAL PARK BRONTE RIVER KEYMAP

BRONTE RIVER LIMITED PARTNERSHIP

BRONTE RIVER OAKVILLE, ON

SITE PLAN APPROVAL LANDSCAPE PACKAGE

List of Drawings

- Landscape Plan Landscape Plan
- Landscape Plan
 Canopy Coverage Plan
- Detail Plans Outdoor Amenity
 Detail Plans Entry Plan
- Planting Details & Notes
 Paving, Curb & Wall Details
 Steps & Railing Details
 Site Furnishings Details

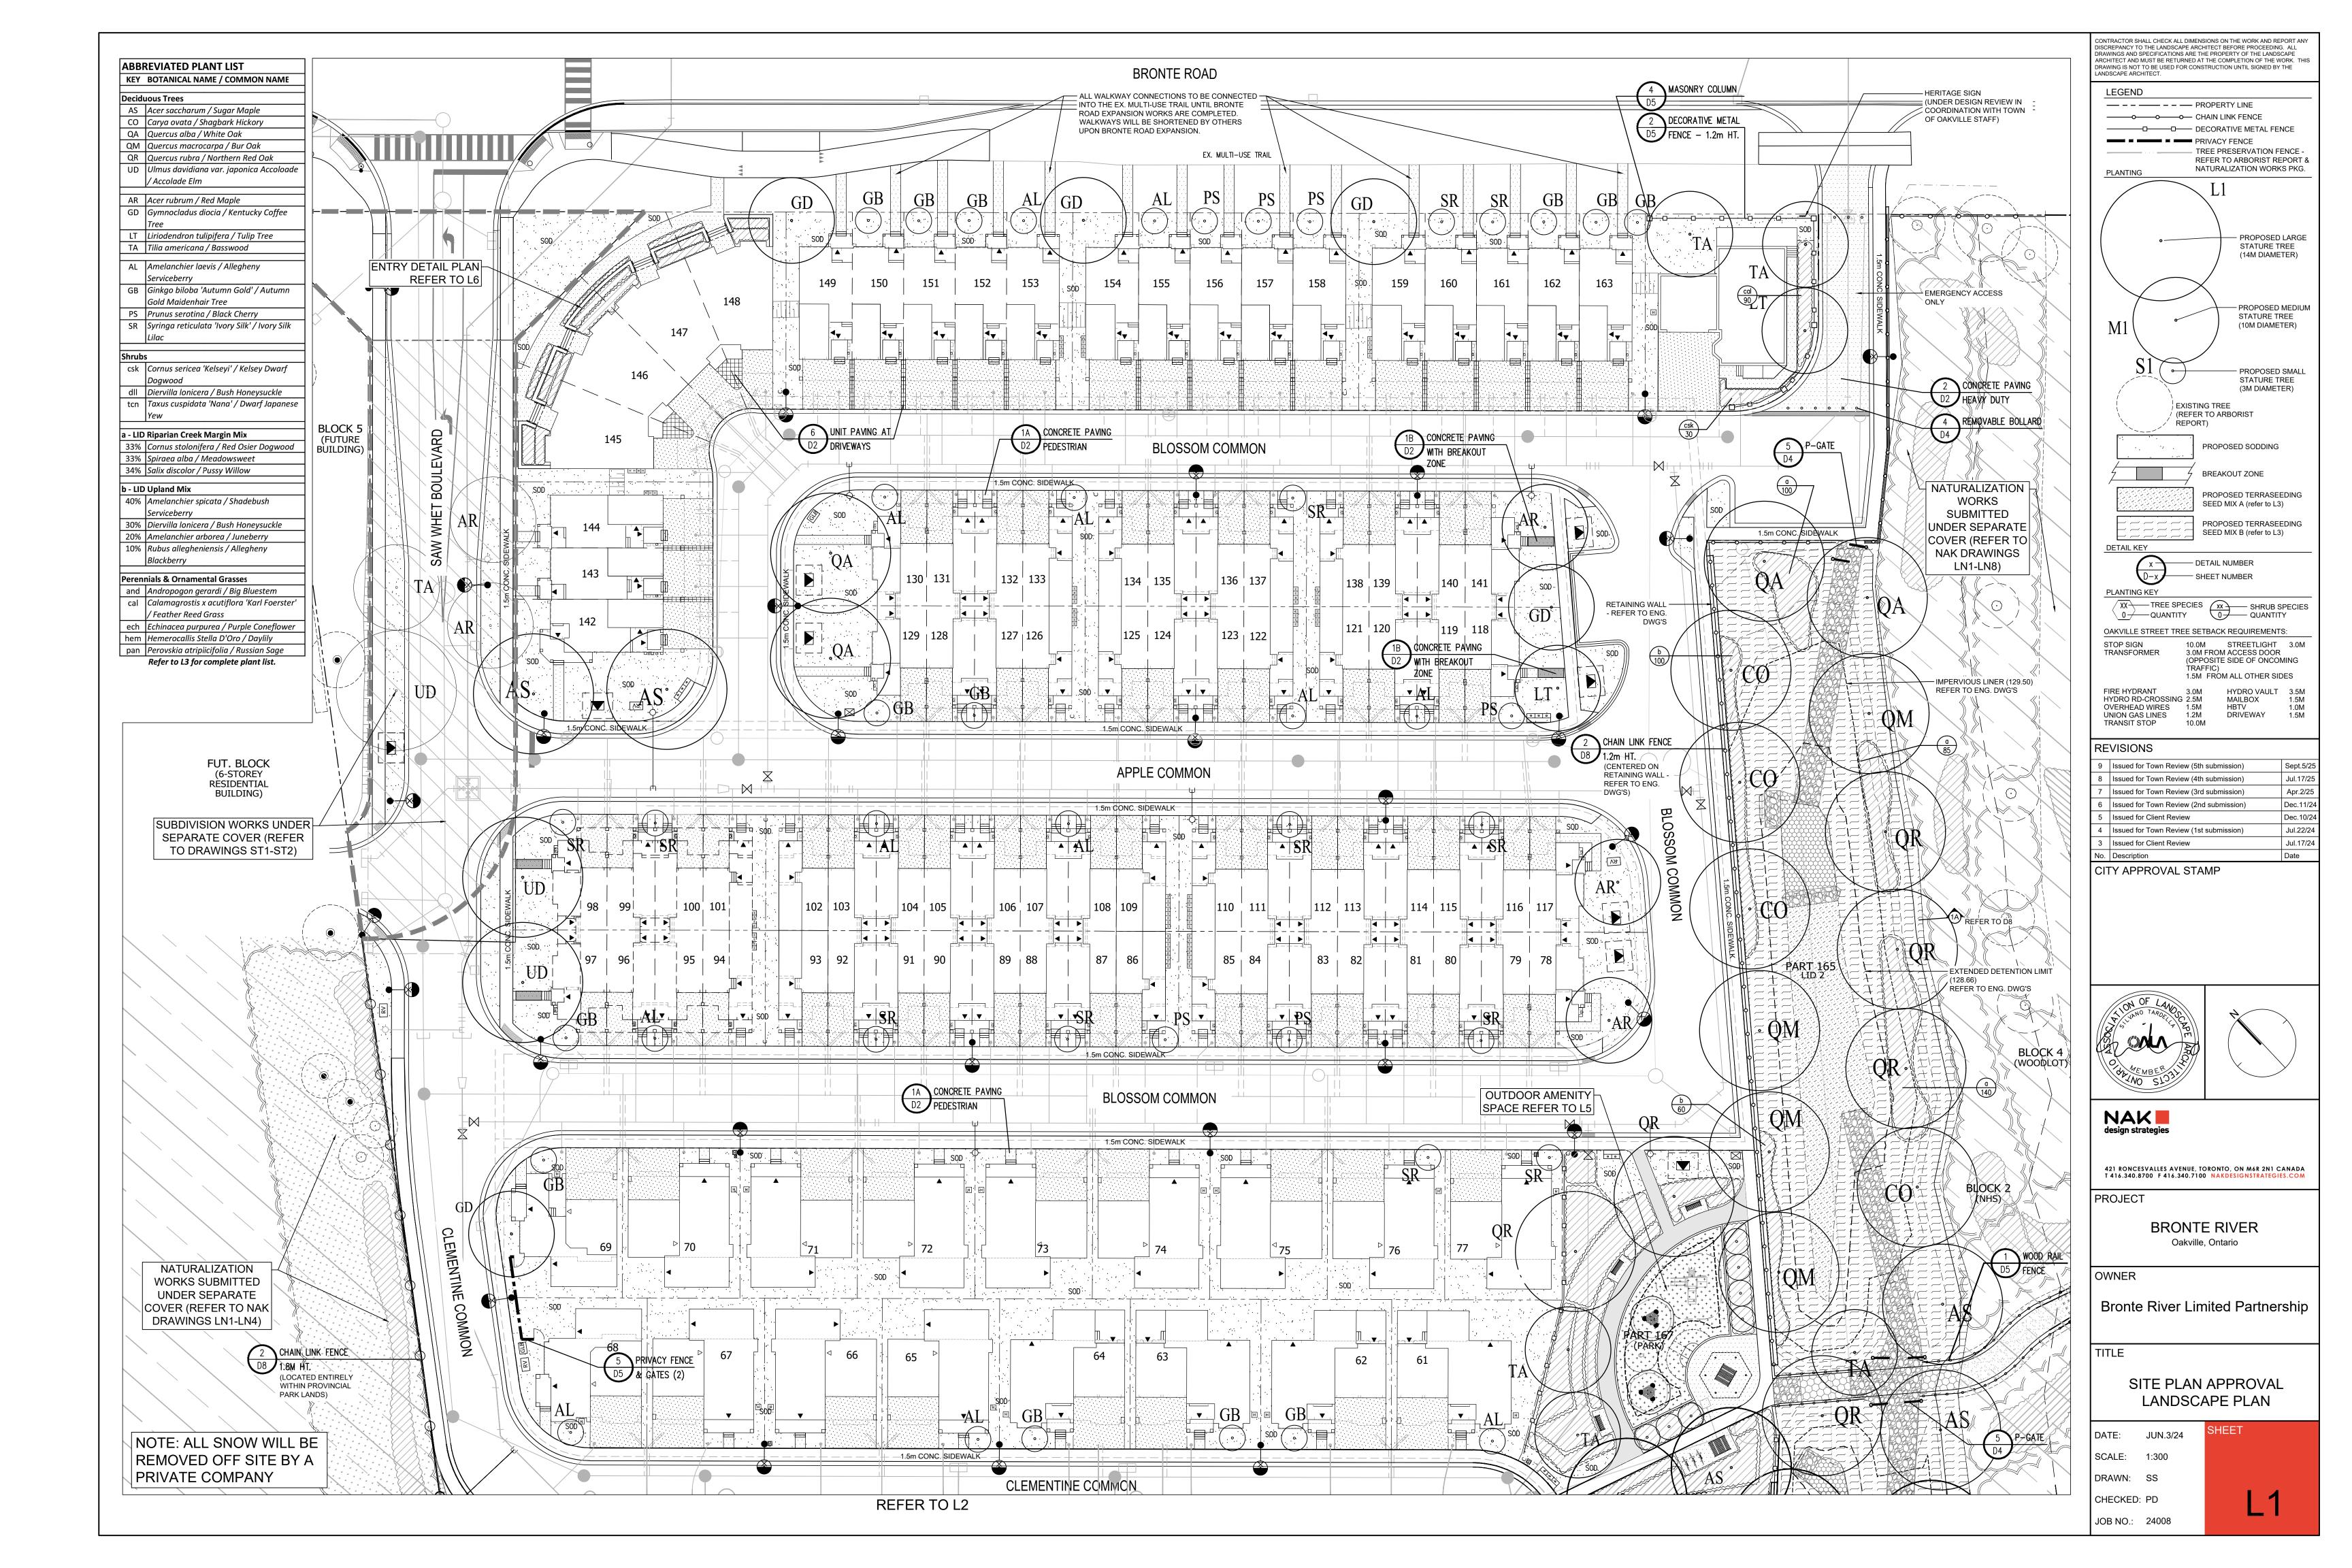
- Fencing Details
 Play Area Details
- Shade Structure Details LID Sections & Fencing Details
- Engineering Curb Details

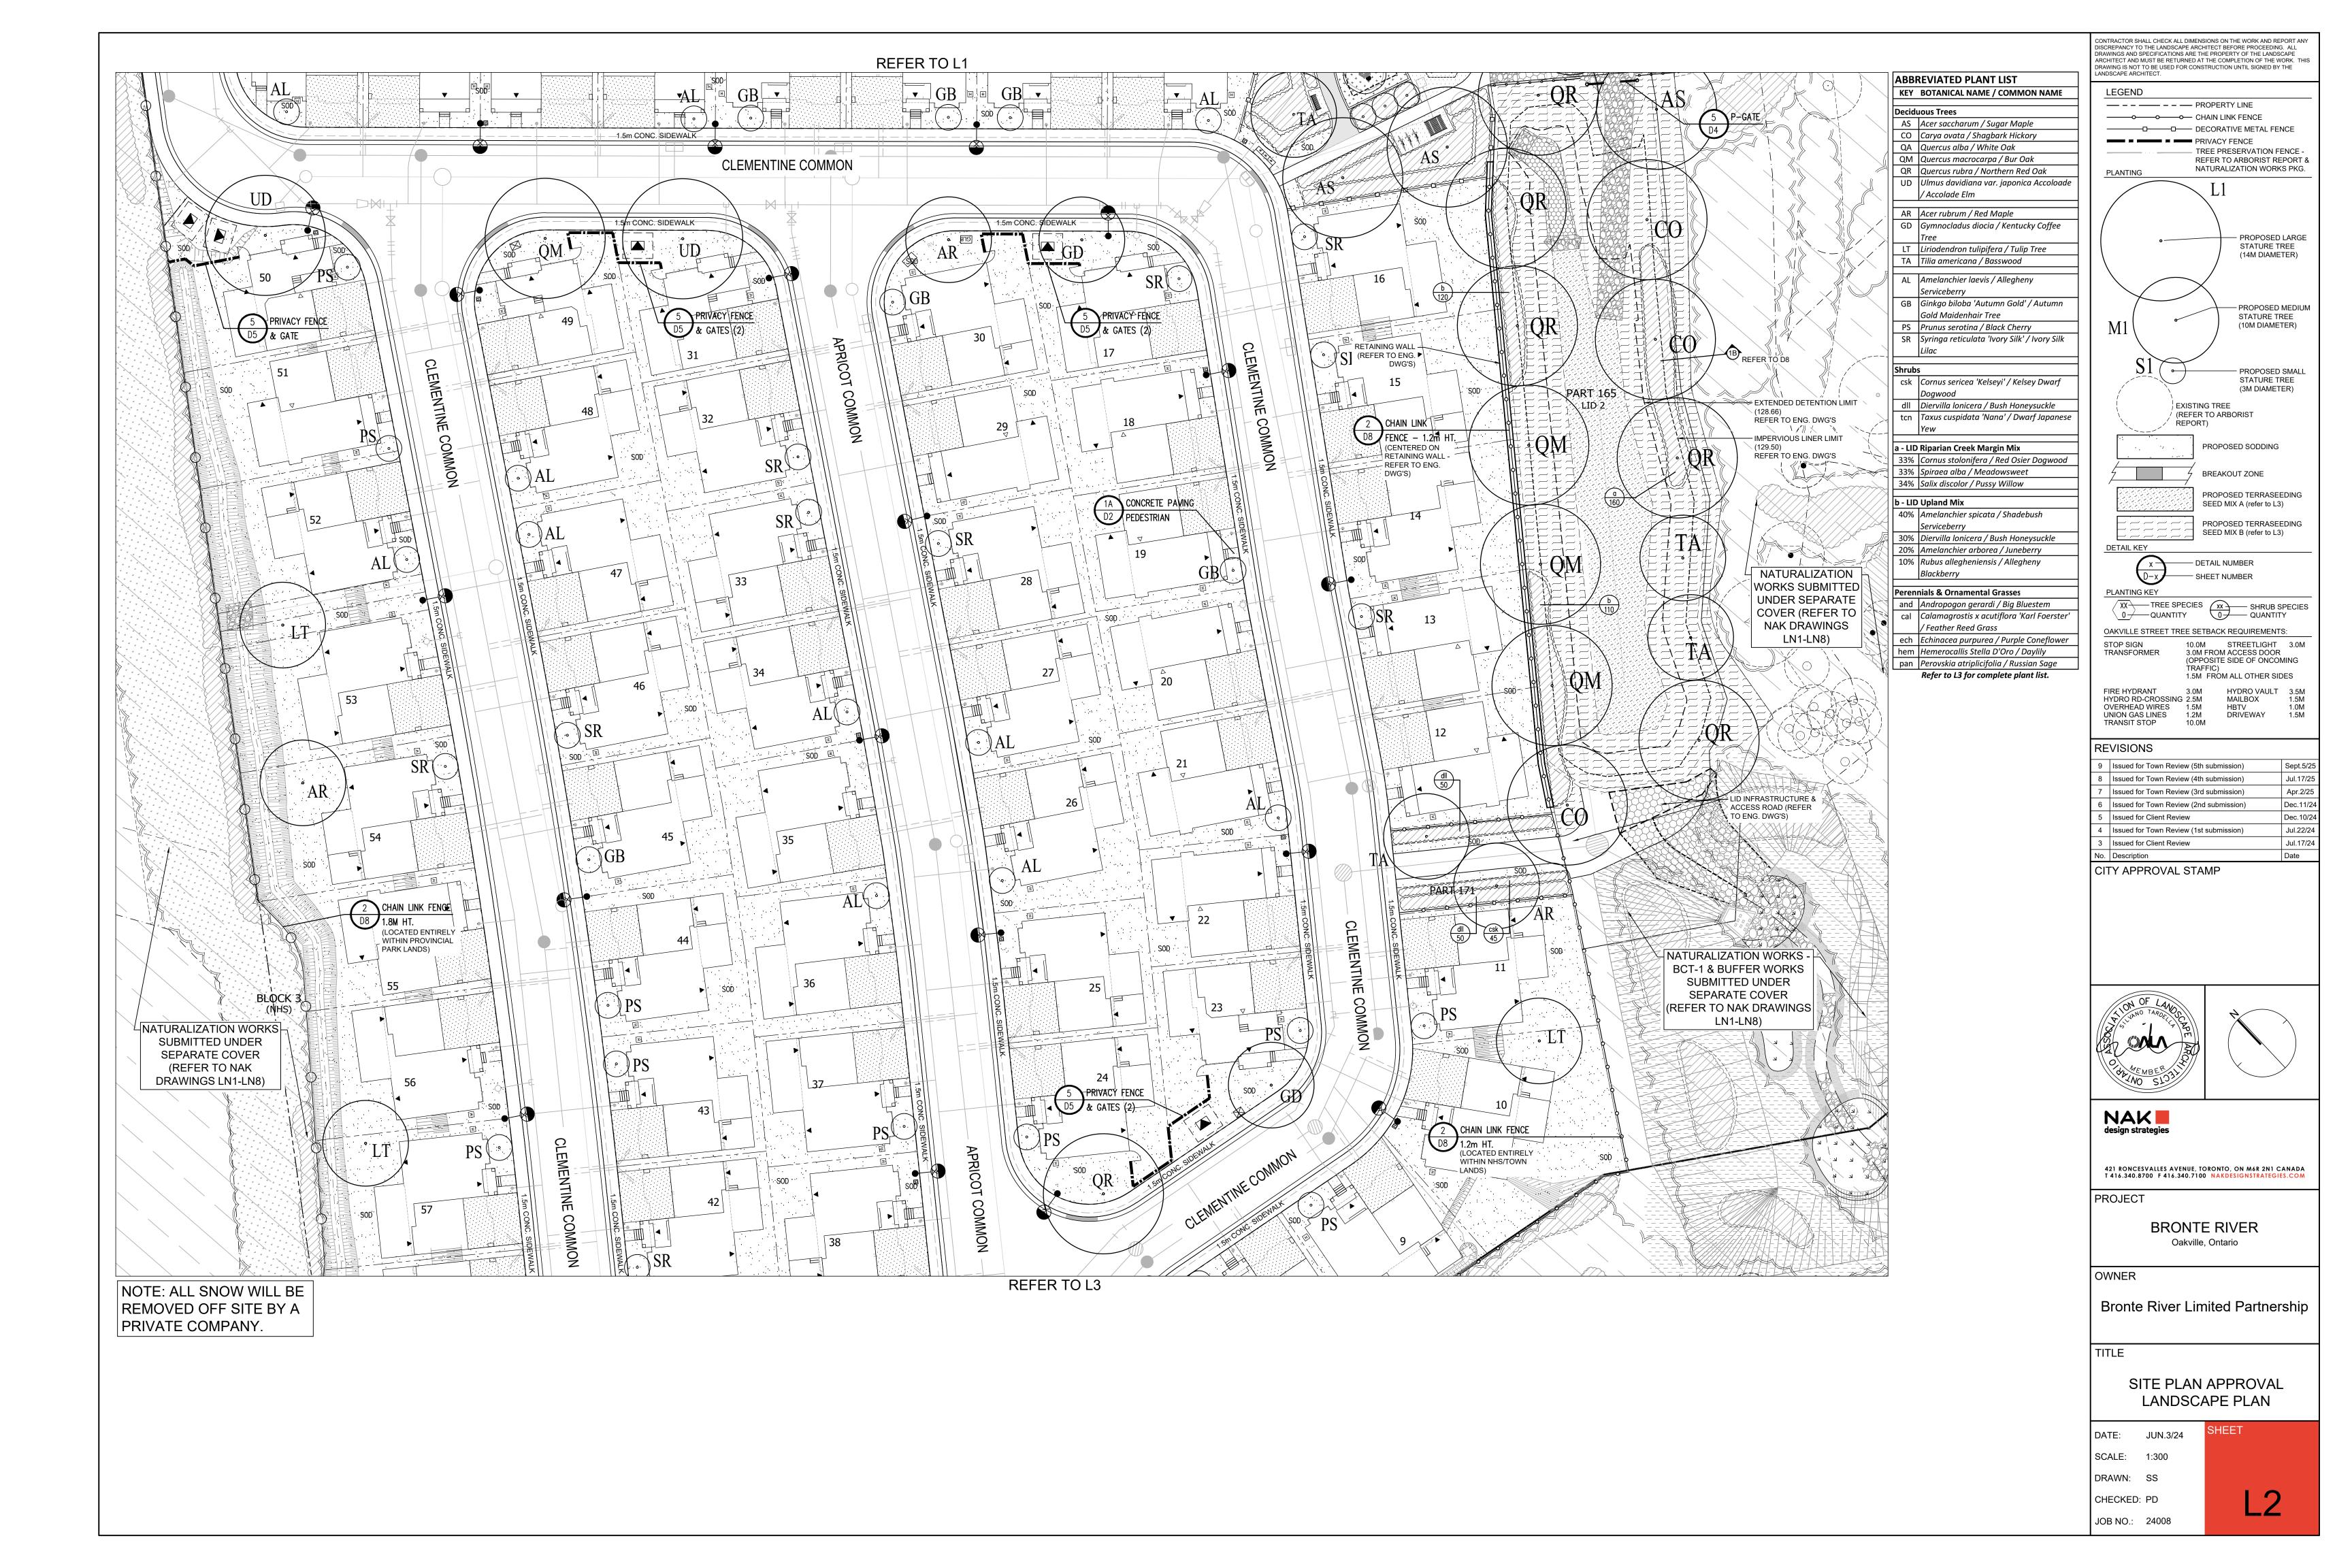
Issued for Client Review July 5, 2024 July 11, 2024 Issued for Client Review Issued for Client Review July 17, 2024 Issued for Town Review - 1st submission July 22, 2024 Issued for Client Review December 10, 2024 Issued for Town Review - 2nd submission December 11, 2024 April 2, 2025 Issued for Town Review - 3rd submission July 17, 2025 Issued for Town Review - 4th submission

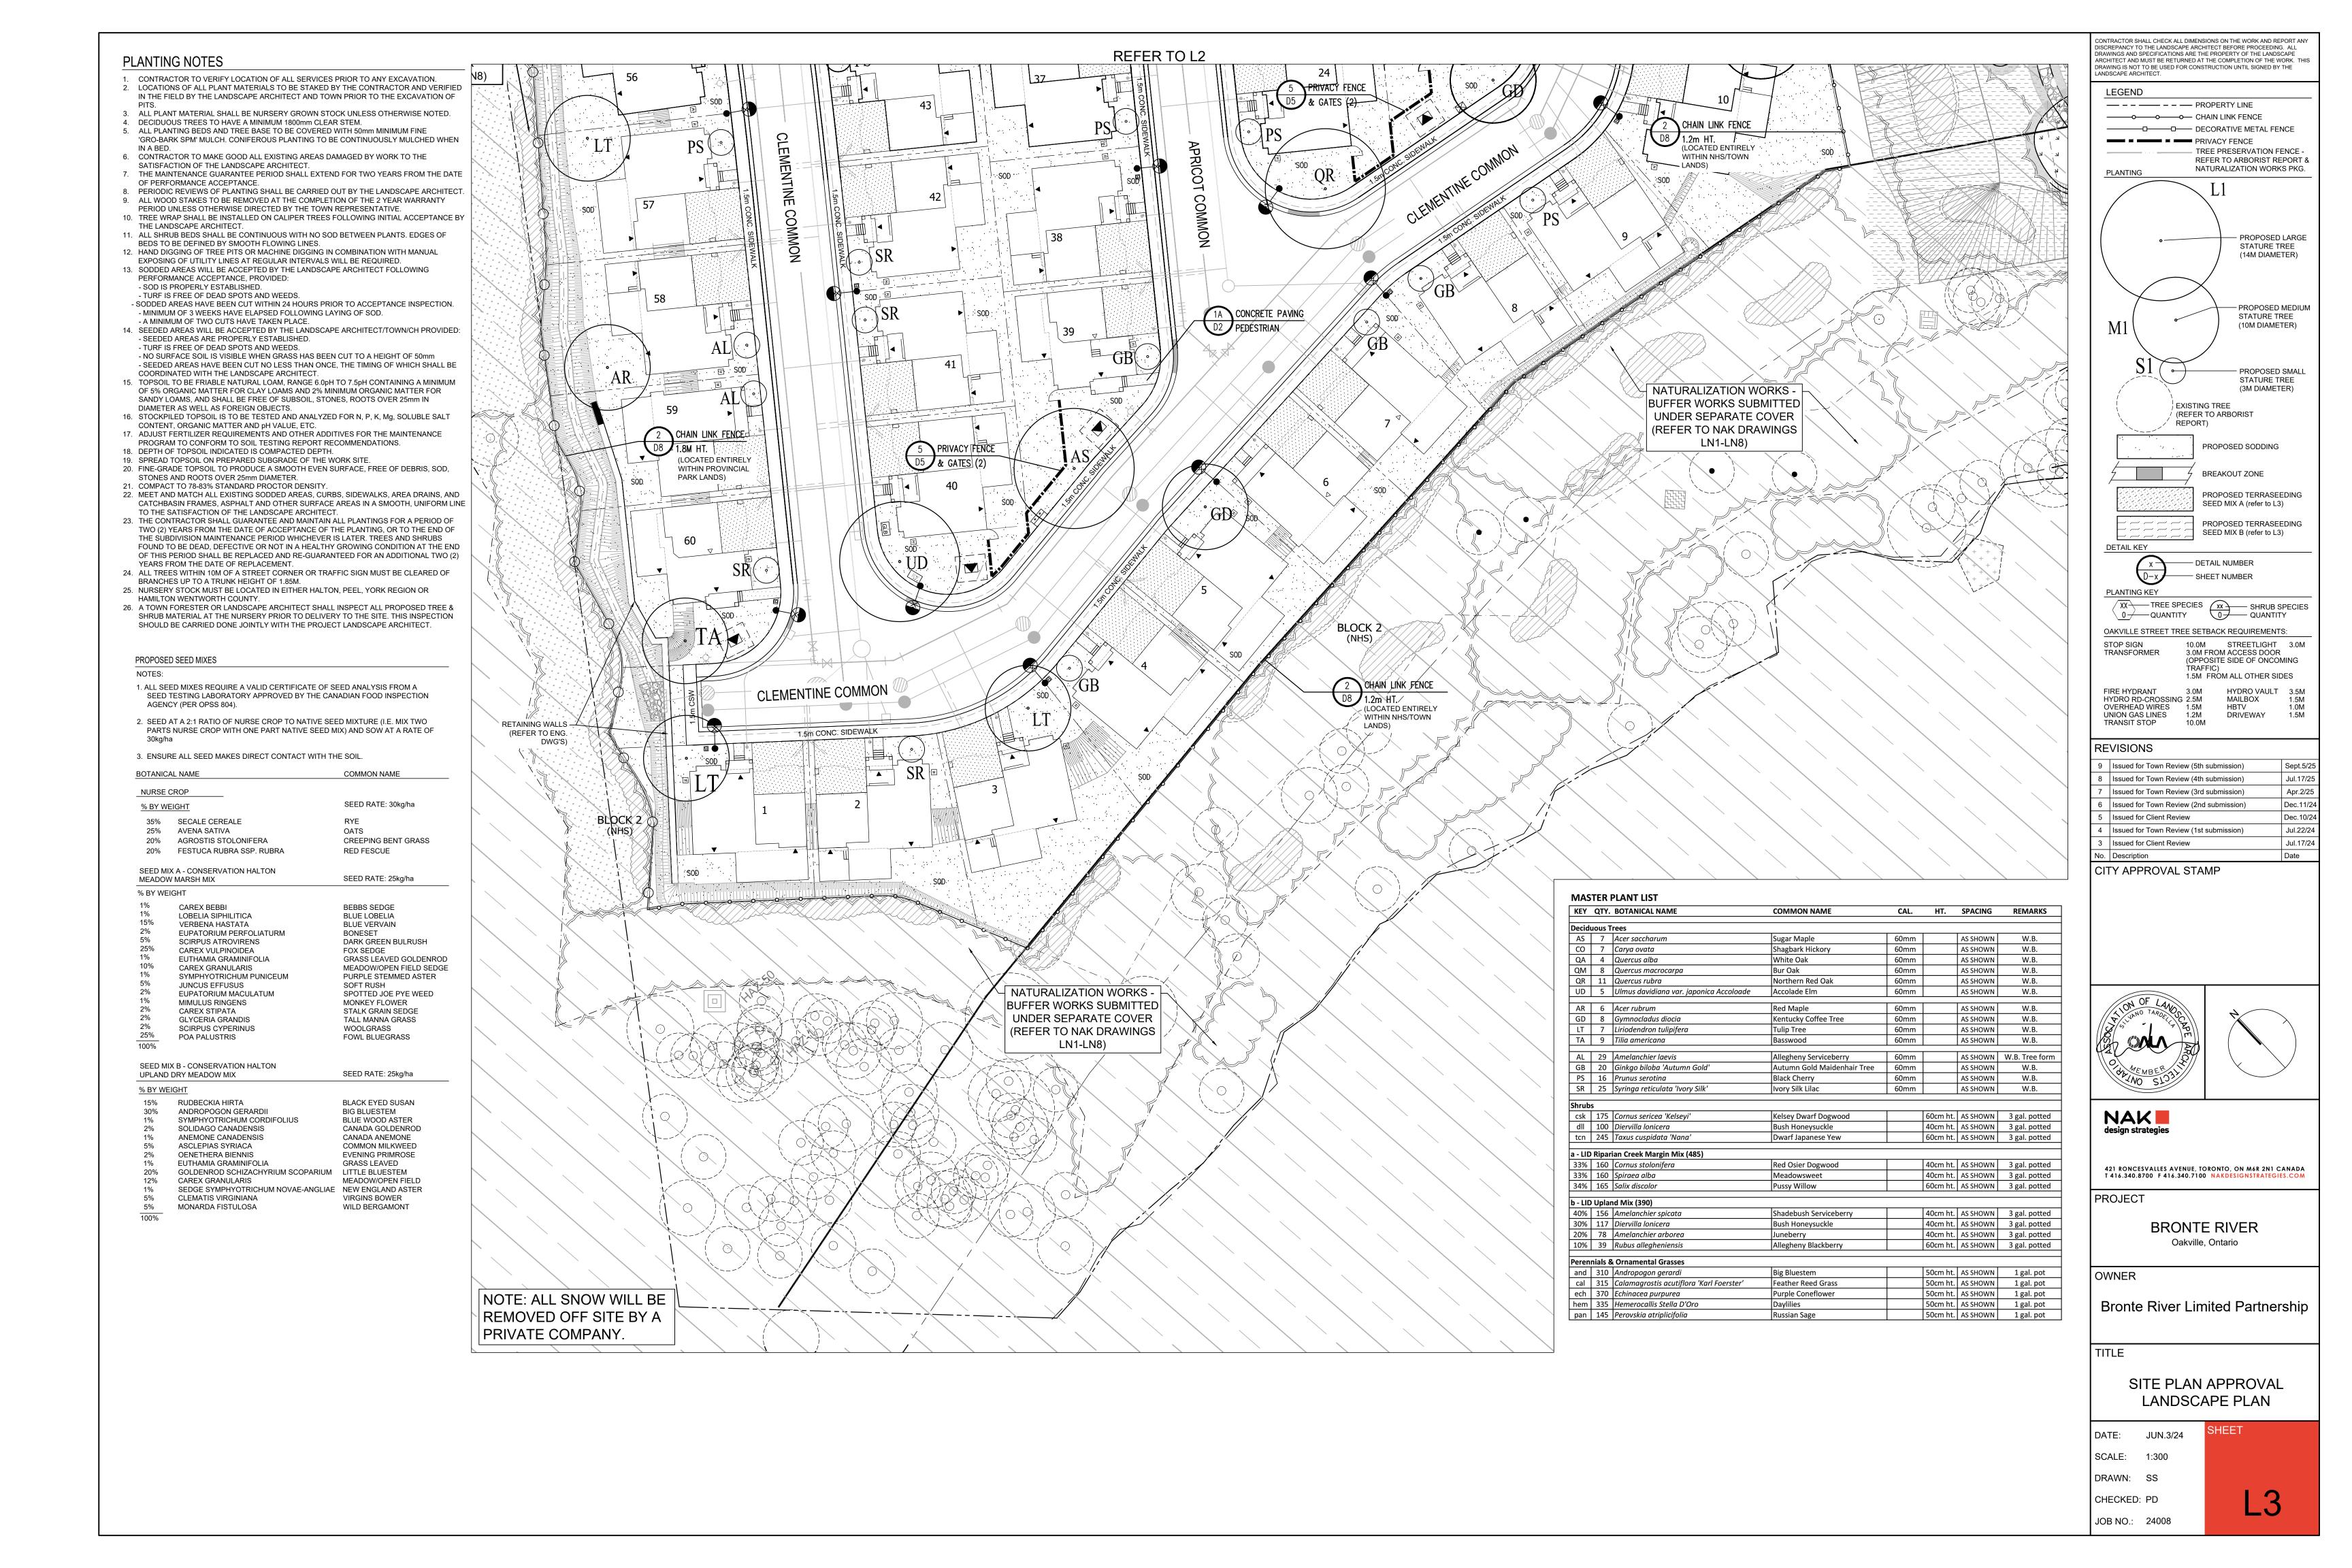
September 5, 2025

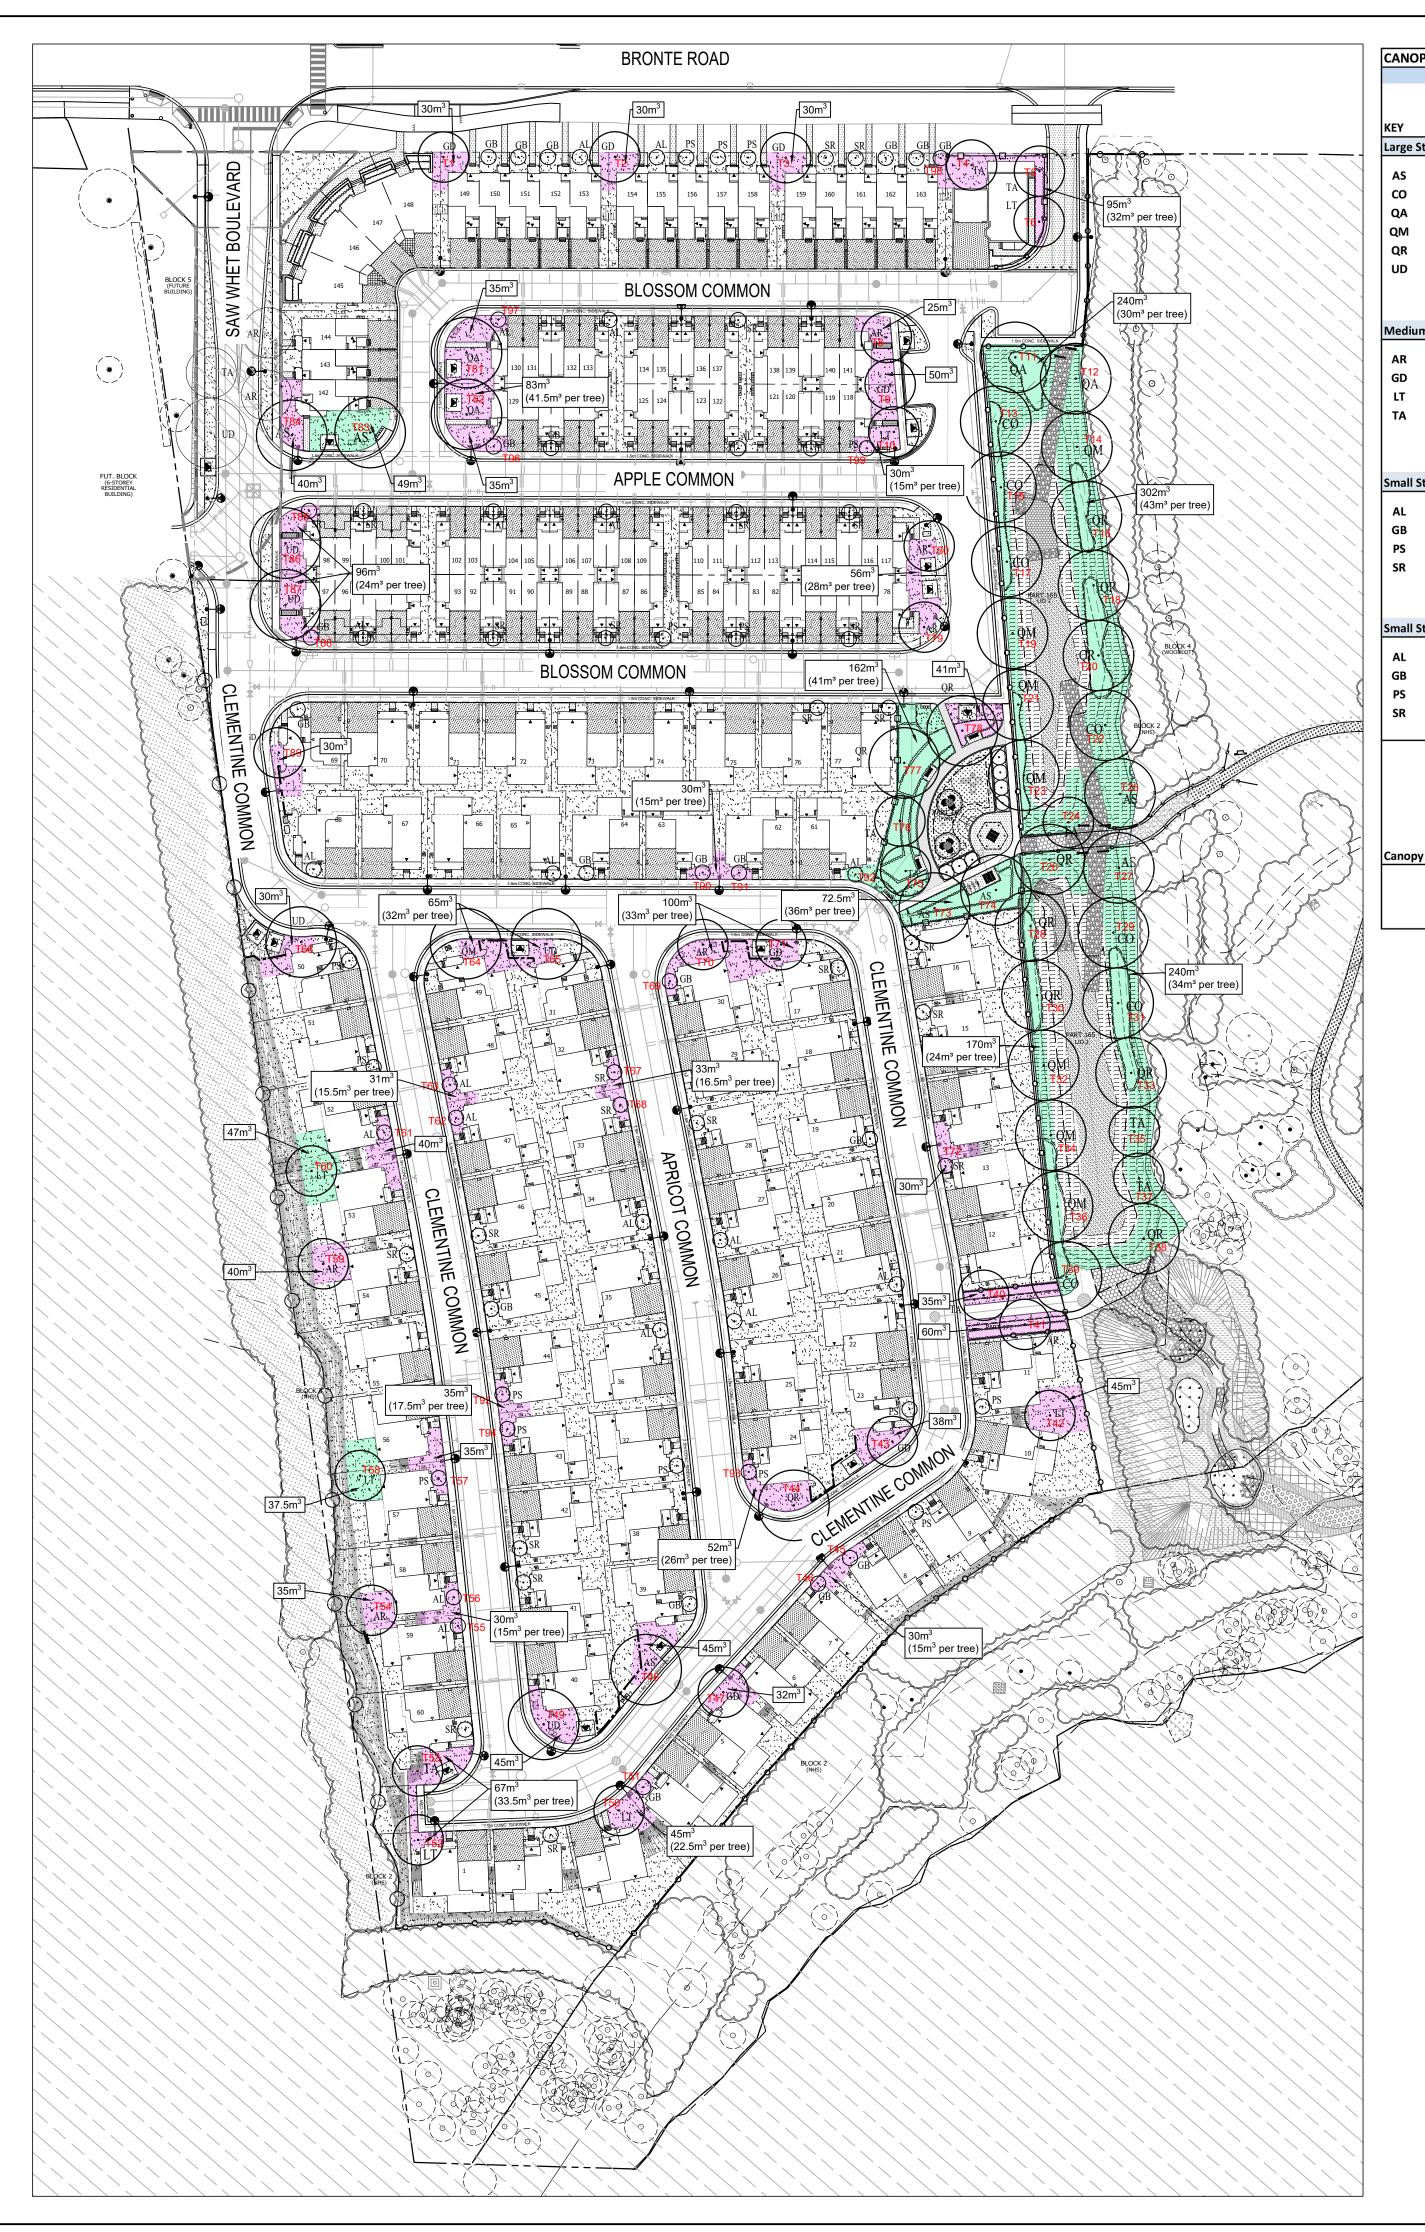
Issued for Town Review - 5th submission











KEY	Botanical Name	Common Name	Size/Remarks	Qty	Crown Area per tree (m2)	Canopy Area Sub- total (m2)	% of To Canop Area
	Stature Trees (14+m spread)	Common Name	Size/ Nemains	Qty	(1112)	total (III2)	Alca
AS	ACER SACCHARUM	SUGAR MAPLE	60mm cal., W.B.	7	154.0	1,078	7.1%
СО	CARYA OVATA	SHAGBARK HICKORY	60mm cal., W.B.	7	154.0	1,078	7.1%
QA	QUERCUS ALBA	WHITE OAK	60mm cal., W.B.	4	154.0	616	4.19
QM	QUERCUS MACROCARPA	BURR OAK	60mm cal., W.B.	8	154.0	1,232	8.29
QR	QUERCUS RUBRA	RED OAK	60mm cal., W.B.	11	154.0	1,694	11.2
UD	ULMUS DAVIDIANA VA. JAPONICA ACCOLADE	ACCOLADE ELM	60mm cal., W.B.	5	154.0	770	5.19
		LA	RGE STATURE TREE SUBTOTAL	42		6,468	
Vlediu	m Stature Trees (10-13m spread)						
AR	ACER RUBRUM	RED MAPLE	60mm cal., W.B.	7	78.5	550	7.19
GD	GYMNOCLADUS DIOCIA	KENTUCKY COFFEE TREE	60mm cal., W.B.	8	78.5	628	8.2
LT	LIRIODENDRON TULIPIFERA	TULIP TREE	60mm cal., W.B.	7	78.5	550	7.1
TA	TILIA AMERICANA	BASSWOOD	60mm cal., W.B.	9	78.5	707	9.2
		MEDI	IUM STATURE TREE SUBTOTAL	31		2,434	
imall :	Stature Trees (3-9m spread)						
AL	AMELANCHIER LAEVIS	ALLEGHENY SERVICEBERRY	60mm cal., B&B	7	7.0	49	7.1
GB	GINKGO BILOBA 'AUTUMN GOLD'	AUTUMN GOLD MAIDENHAIR TREE	60mm cal., B&B	8	7.0	56	8.2
PS	PRUNUS SEROTINA	BLACK CHERRY	60mm cal., B&B	6	7.0	42	6.1
SR	SYRINGA RETICULATA 'IVORY SILK'	IVORY SILK LILAC	60mm cal., B&B	4	7.0	28	4.1
		SMA	LL STATURE TREE SUBTOTAL	25		175	
mall	Stature Trees (3-9m spread) - insufficent soil volume						
AL	AMELANCHIER LAEVIS	ALLEGHENY SERVICEBERRY	60mm cal., B&B	22			
GB	GINKGO BILOBA 'AUTUMN GOLD'	AUTUMN GOLD MAIDENHAIR TREE	60mm cal., B&B	12			
PS	PRUNUS SEROTINA	BLACK CHERRY	60mm cal., B&B	10			
SR	SYRINGA RETICULATA 'IVORY SILK'	IVORY SILK LILAC	60mm cal., B&B	21			
		,	CANOPY COVERAGE				
			TREE TOTAL	98		9,077	m²
		NATURA	LIZATION WORKS - 3m Band			2,200	m²
			OVERLAP			685	m^2
			TOTAL (excluding overlap)		,	10,592	m²
anop	y Summary		Site Area			52,865	m²
			Site Canopy Cover		,	20.0%	-'''
		1-	and Use Canopy Cover Target			20%	-

	Dionie ix		
LE NAN		iver - 1300, 1316, 1326, 1342 and	
NOPY	COVER TARGET 20%	(BASED ON LAND USE)	
		CATEGORY	SOIL VOLUME
REE#	SPECIES	S, M, L	per TREE (m³
T1 T2	Gymnocladus diocia Gymnocladus diocia	<u>M</u>	30
T3	Gymnocladus diocia	M	30
T4 T5	Ginkgo biloba 'Autumn Gold Tilia americana	<u>M</u> M	32
T6	Tilia americana Tilia americana	M	32
T8	Acer rubrum	M	25
T9 T10	Gymnocladus diocia Liriodendron tulipifera	M	50 15
T11	Quercus alba		30
T12	Quercus alba	<u>L</u>	43
T13	Carya ovata Quercus macrocarpa	<u>L</u>	<u>30</u> 43
T15	Carya ovata	L	30
T16 T17	Quercus rubra Carya ovata	<u>L</u>	43 30
T18	Quercus alba		43
T19	Quercus macrocarpa	<u>L</u>	30
T20 T21	Quercus rubra Quercus macrocarpa	<u>L</u>	43 30
T22	Carya ovata	L	43
T23 T24	Quercus macrocarpa	L	30
T25	Tilia americana Acer saccharum	<u>WI</u>	43
T26	Quercus rubra	L	24
T27 T28	Acer saccharum Quercus rubra	<u>L</u>	24
T29	Carya ovata		34
T30	Quercus rubra	L	24
T31 T32	Carya ovata Quercus macrocarpa		<u>34</u> 24
T33	Quercus rubra		34
T34	Quercus macrocarpa	L	24
T35 T36	Tilia americana Quercus macrocarpa	<u>M</u> L	<u>34</u> 24
T37	Tilia americana		34
Г38 Г39	Quercus rubra Carya ovata	<u>L</u>	24 24
T40	Tilia americana		35
Γ41	Acer rubrum		60
Γ42 Γ43	Liriodendron tulipifera Gymnocladus diocia	M	<u>45</u> 38
Г44	Quercus rubra	L	26
Γ45 Γ46	Ginkgo biloba 'Autumn Gold		15 15
Γ47	Ginkgo biloba 'Autumn Gold Gymnocladus diocia	<u> </u>	32
48	Acer saccharum	L	45
49 50	Ulmus davidiana va. Japonio Liriodendron tulipifera	a Accolade L	<u>45</u> 22.5
Γ51	Ginkgo biloba 'Autumn Gold		22.5
Γ52	Liriodendron tulipifera	M	33.5
53 54	Tilia americana Acer rubrum	M M	33.5
T55	Amelanchier laevis		15
56	Amelanchier laevis	<u> </u>	15
57 58	Prunus serotina Liriodendron tulipifera	<u>S</u> 	35 37.5
59	Acer rubrum	M	40
Г <u>60</u> Г61	Liriodendron tulipifera Amelanchier laevis	M	47
62	Amelanchier laevis		15.5
Γ63	Amelanchier laevis		15.5
64 65	Quercus macrocarpa Ulmus davidiana va. Japonid	ca Accolade L	32
66	Ulmus davidiana va. Japonio	a Accolade L	30
67	Syringa reticulata 'Ivory Silk'	<u></u>	16.5
Г <u>68</u> Г69	Syringa reticulata 'Ivory Silk' Ginkgo biloba 'Autumn Gold		16.5 33
70	Acer rubrum	M	33
71	Gymnocladus diocia	M	33
Γ72 Γ73	Syringa reticulata 'Ivory Silk' Acer saccharum	<u>s</u> 	30
Г74	Acer saccharum	L	36
Γ75 Γ76	Tilia americana Tilia americana	<u>M</u> M	41
76 77	Quercus rubra	<u></u>	41
78	Quercus rubra	L	41
79 80	Acer rubrum Acer rubrum	M M	28 28
80 <u>8</u> 81	Quercus alba	<u></u> L	41.5
82	Quercus alba	L	41.5
83 84	Acer saccharum Acer saccharum	<u>L</u>	49
85	Syringa reticulata 'Ivory Silk'	<u></u> S	24
86	Ulmus davidiana va. Japonid	a Accolade L	24
Г87 Г88	Ulmus davidiana va. Japonid Ginkgo biloba 'Autumn Gold		24 24
г <u>өө</u> Г89	Gymnocladus diocia		30
Г90	Ginkgo biloba 'Autumn Gold	S	15
Г <u>91</u> Г92	Ginkgo biloba 'Autumn Gold Amelanchier laevis	<u> </u>	<u>15</u> 41
г <u>92</u> Г93	Prunus serotina	<u> </u>	26
T94	Prunus serotina	S	17.5
	Prunus serotina	<u></u>	17.5
Г95 Г96	Ginkan hilaha Mutuma Cald	· · · · · · · · · · · · · · · · · · ·	35
Г95 Г96 Г97	Ginkgo biloba 'Autumn Gold' Amelanchier laevis	<u> </u>	35 35
796		S	

CANOPY CALCULATION CHART

FILE NUMBER

CONTRACTOR SHALL CHECK ALL DIMENSIONS ON THE WORK AND REPORT ANY DISCREPANCY TO THE LANDSCAPE ARCHITECT BEFORE PROCEEDING. ALL DRAWINGS AND SPECIFICATIONS ARE THE PROPERTY OF THE LANDSCAPE ARCHITECT AND MUST BE RETURNED AT THE COMPLETION OF THE WORK. THIS DRAWING IS NOT TO BE USED FOR CONSTRUCTION UNTIL SIGNED BY THE LANDSCAPE ARCHITECT. LEGEND PROPERTY LINE

———— DECORATIVE METAL FENCE PRIVACY FENCE TREE PRESERVATION FENCE -REFER TO ARBORIST REPORT & NATURALIZATION WORKS PKG.

PROPOSED LARGE STATURE TREE (14M DIAMETER)

PROPOSED MEDIUM STATURE TREE (10M DIAMETER) __PROPOSED SMALL STATURE TREE (3M DIAMETER) EXISTING TREE (REFER TO ARBORIST REPORT)

PROPOSED SODDING BREAKOUT ZONE PROPOSED TERRASEEDING - SEED MIX A (refer to L3)

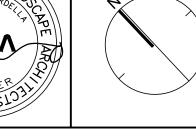
PROPOSED TERRASEEDING - SEED MIX B (refer to L3) SOIL DEPTHS 750MM DEPTH 500MM DEPTH

REVISIONS

9 Issued for Town Review (5th submission) 8 Issued for Town Review (4th submission) Jul.17/25 Apr.2/25 Issued for Town Review (3rd submission) 6 Issued for Town Review (2nd submission) 5 Issued for Client Review Jul.22/24 4 Issued for Town Review (1st submission) 3 Issued for Client Review Jul.17/24

CITY APPROVAL STAMP





NAK design strategies

421 RONCESVALLES AVENUE, TORONTO, ON M6R 2N1 CANADA T 416.340.8700 F 416.340.7100 NAKDESIGNSTRATEGIES.COM

PROJECT

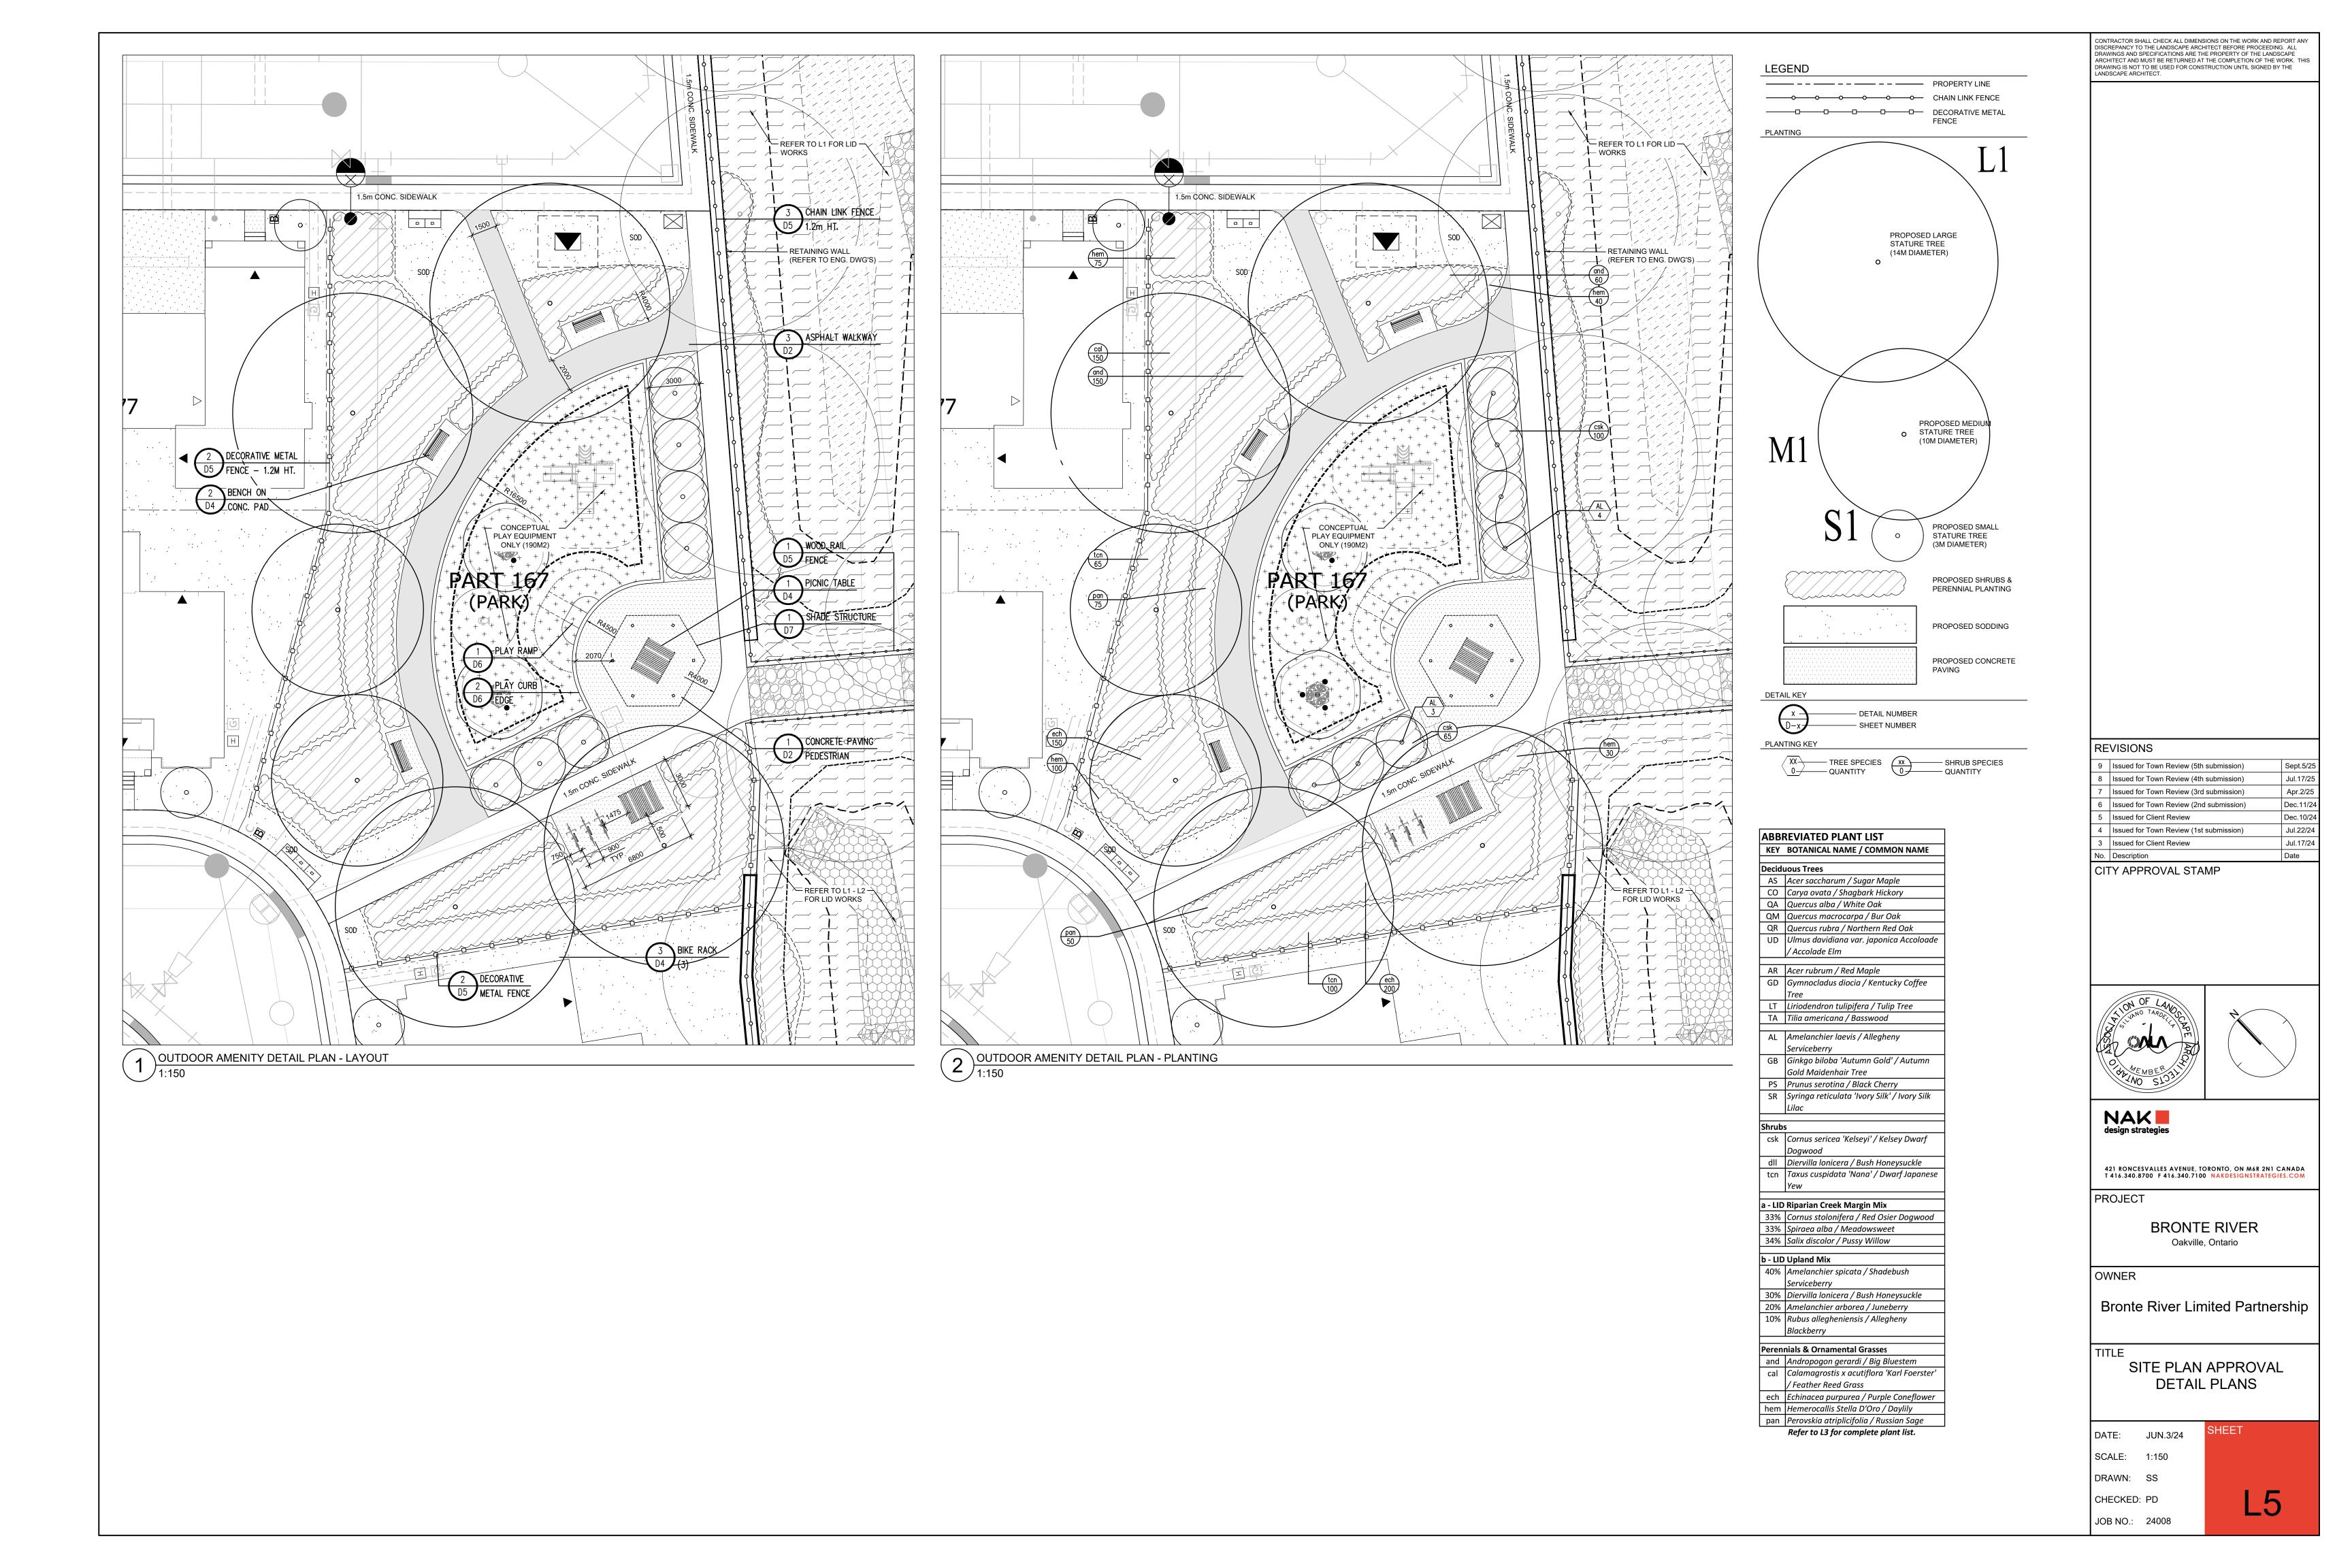
BRONTE RIVER Oakville, Ontario

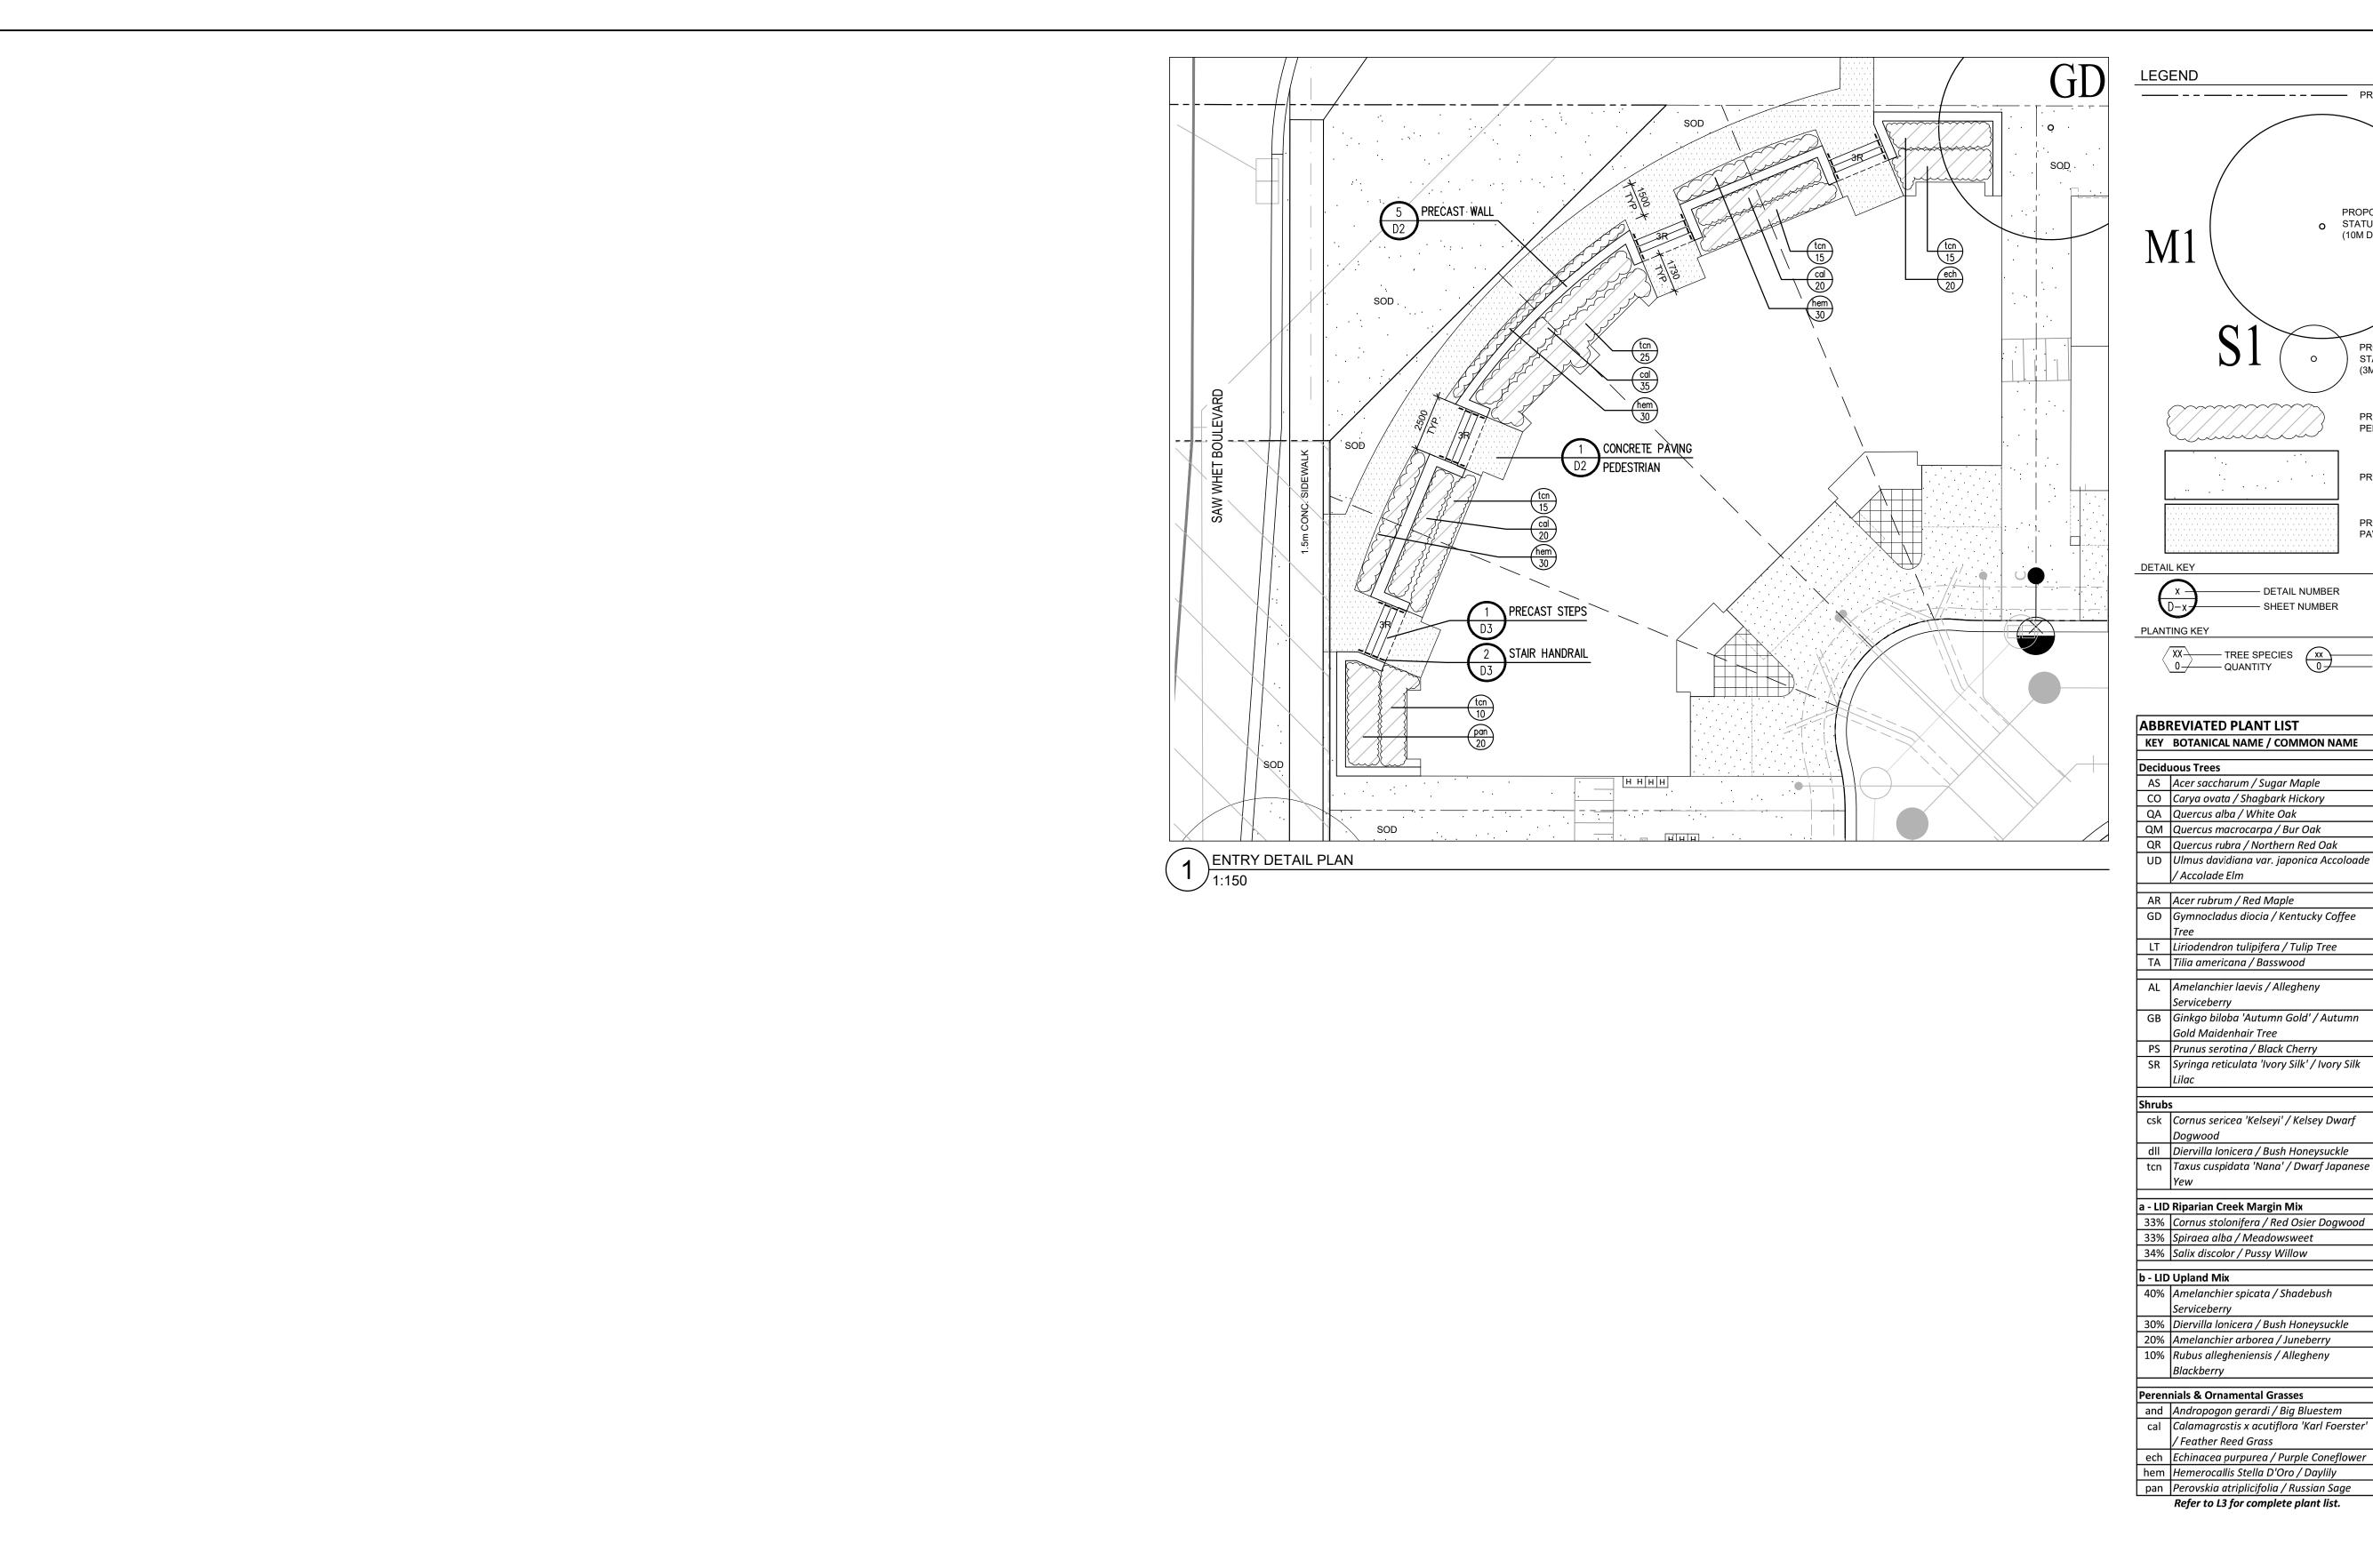
OWNER

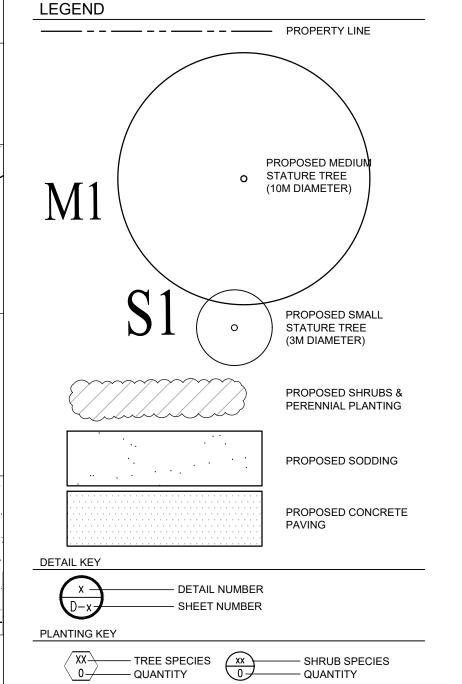
Bronte River Limited Partnership

SITE PLAN APPROVAL CANOPY COVERAGE PLAN

DATE: JUN.3/24 SCALE: 1:750 DRAWN: SS CHECKED: PD







ABBREVIATED PLANT LIST

Deciduous Trees

- AS Acer saccharum / Sugar Maple
- CO Carya ovata / Shagbark Hickory QA Quercus alba / White Oak
- QR | Quercus rubra / Northern Red Oak

GD Gymnocladus diocia / Kentucky Coffee

- LT Liriodendron tulipifera / Tulip Tree
- AL Amelanchier laevis / Allegheny
- GB | Ginkgo biloba 'Autumn Gold' / Autumn Gold Maidenhair Tree
- PS Prunus serotina / Black Cherry
- SR | Syringa reticulata 'Ivory Silk' / Ivory Silk
- csk | Cornus sericea 'Kelseyi' / Kelsey Dwarf
- dll Diervilla lonicera / Bush Honeysuckle tcn | Taxus cuspidata 'Nana' / Dwarf Japanese

a - LID Riparian Creek Margin Mix

- 33% | Cornus stolonifera / Red Osier Dogwood
- 33% Spiraea alba / Meadowsweet 34% Salix discolor / Pussy Willow

b - LID Upland Mix

- 40% Amelanchier spicata / Shadebush Serviceberry
- 30% Diervilla lonicera / Bush Honeysuckle 20% Amelanchier arborea / Juneberry
- 10% Rubus allegheniensis / Allegheny Blackberry

Perennials & Ornamental Grasses

- and Andropogon gerardi / Big Bluestem cal Calamagrostis x acutiflora 'Karl Foerster'
- / Feather Reed Grass
- ech | Echinacea purpurea / Purple Coneflower hem Hemerocallis Stella D'Oro / Daylily
- pan Perovskia atriplicifolia / Russian Sage Refer to L3 for complete plant list.


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REVISIONS

9	Issued for Town Review (5th submission)	Sept.
8	Issued for Town Review (4th submission)	Jul.1
7	Issued for Town Review (3rd submission)	Apr.2
6	Issued for Town Review (2nd submission)	Dec.1
5	Issued for Client Review	Dec.1
4	Issued for Town Review (1st submission)	Jul.2
3	Issued for Client Review	Jul.1
No.	Description	Date

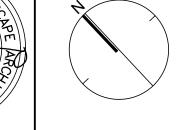CITY APPROVAL STAMP





NAK design strategies

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PROJECT

BRONTE RIVER Oakville, Ontario

OWNER

Bronte River Limited Partnership

TITLE

SITE PLAN APPROVAL **DETAIL PLANS**

DATE: JUN.3/24 SCALE: 1:150

DRAWN: SS

CHECKED: PD JOB NO.: 24008

SPECIES AND STANDARDS OF TREES

Final tree species choice is to be approved by Development Engineering Urban Forestry. Species and cultivars of trees, as well as the standard for that species and cultivar are to comply with the Canadian Standards for Nursery Stock, Canadian Nursery Landscape Association, as

<u>ORIGIN</u>

Information concerning the geographical origin of seed or cuttings used to produce the trees used in this contract shall be made available to Development Engineering Urban Forestry on demand. If the plant material is of an origin unsuitable climatically to the Oakville area in the opinion of Nursery planting stock must be located in either Halton, Peel, York Region or Hamilton

Development & Environmental Engineering is to inspect all proposed trees for planting at the nursery prior to delivery to the site. This inspection should be carried done jointly with the

All trees shall conform to species and/or variety named in the species list. No substitutions will

SIZE OF TREES

Unless otherwise stated by Development Engineering Urban Forestry all deciduous trees planted All 300 cm trees must have a minimum of 185 cm of clear stem, measured from the ground, unless approved by Development Engineering Urban Forestry.

Trees must be transported to the planting site in a manner that will minimize damage to crowns, boles or roots. Balled and burlapped (B/B) trees must have no cracks in the ball to be accepted. Trees, whether balled or burlapped, must have their root systems in a moist state at all times.

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TEMPORARY STORAGE

If conditions preclude immediate use of tree stock, balled and burlapped trees shall be stored in a sheltered spot protected from sun and wind. The root balls shall be kept in a moist state at all times by watering as required.

PLANTING and TREE SPECIES LOCATIONS

Residential Street Trees

All street tree planting locations must conform to the approved Street Tree Planting Plan and any deviation to the plan must be approved by Development Engineering Urban Forestry.

<u>Commercial Street Trees</u>

Street tree planting locations shall be installed as per either the approved Landscaping Plan or Street Tree Planting Plan that forms part of the development project and any change from the plan must be approved by Development Engineering Urban Forestry.

Tree Species Mix Configuration

Tree groupings are not to exceed 3 of any one species type in a row on one side of the road, and no more than 4 trees in total for groupings that are divided with the opposite

BACKFILLING

Backfilling* is to be placed in layers approximately 15 cm in depth and firmly tamped in place in such a manner that the tree retains its vertical position without support. Particular care is to be taken to ensure that no air pockets remain under or around roots and that damage does not occur to the root system. The fill shall be thoroughly watered immediately after planting. Backfilled soil is to be placed to bring the top level of the root ball 7.6 cm higher than the existing surrounding grade to allow for settling.

At grade, a ridge of soil located at the edge of the planting hole shall be formed to a height of 9 cm, to act as a catch basin for any subsequent watering's and to retain mulch.

Balled and burlapped trees shall have the burlap cut and removed to approximately one-half the root ball height to prevent the burlap from acting as a wick thereby drying out the ball. All ropes used to contain the root ball shall be cut unless made of 100% natural fabric that will decay. For root balls encased in wire baskets the entire wire basket must be cut and removed prior to the backfilling phase.

The crown of the tree shall be pruned from the bottom up at the time of planting to remove all dead and damaged branches. The terminal or leader is not to be pruned unless broken. All cuts shall be made using approved standards and Guidelines for pruning set out by the ANSI A300 pruning standards (2001 Edition), and the Illustrated Guide to Pruning, 2nd Edition (2002 ISA), H:\DEVELOPMENT ENGINEERING\Urban Forestry\Tree Planting Standards\SPECIFICATIONS FOR TREE PLANTING.docxH:\DEVELOPMENT ENGINEERING\Urban Forestry\Tree Planting Standards\SPECIFICATIONS FOR TREE PLANTING.docxSPECIFICATIONS FOR TREE PLANTING.docx

leaving no stubs. On all cuts over 2 cm in diameter and bruises or scars on the bark, the injured cambium shall be traced back to living tissue and removed. Wounds shall be smoothed and shaped so as not to retain water. Large wounds produced by any means other than branch pruning may render the tree unacceptable, requiring replacement subject to the directions of Development Engineering Urban Forestry.

STAKING

All balled and burlapped trees shall, immediately after planting, be supported by two wooden stakes driven outside the ball in line with the direction of the prevailing wind (west-east). For this type of tree, B/B, the stakes are to be driven at least 70 cm below grade line. The stakes must be driven deep enough that there is at least 5 cm between the top of the stakes and the first branch. Stake placement shall be such that no main roots are severed by the stake being driven into the ground. Metal stakes are prohibited.

The following specification will be applied: non shredded woodchips measuring between 2.5 cm and 5.0 cm in width and placed to a depth of between 5.0 cm to 7.5 cm spread the following distance from the root collar:

DBH (cm) average radius from root collar (m) o to 10 11 to 40

Woodchips are not to be in contact with the tree trunk and must be applied no later than 48


All plantings shall be inspected by the project Arborist or Landscape Architect for compliance. Plantings which do not meet the specifications listed above, or which need straightening or correction as to settling, will not be accepted by the town until such problems are corrected.

MINIMUM ROOT BALL DIAMETER

The minimum acceptable root ball diameter for balled and burlapped trees shall be: 70 cm for 60 mm caliper trees 85 cm for 75 mm caliper trees 100 cm for 100 mm caliper trees

65 cm for 150 cm tall conifer stock

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TOPSOIL IN PLANTING AREAS SHOULD BE COMPACTED TO 80-85% SPD

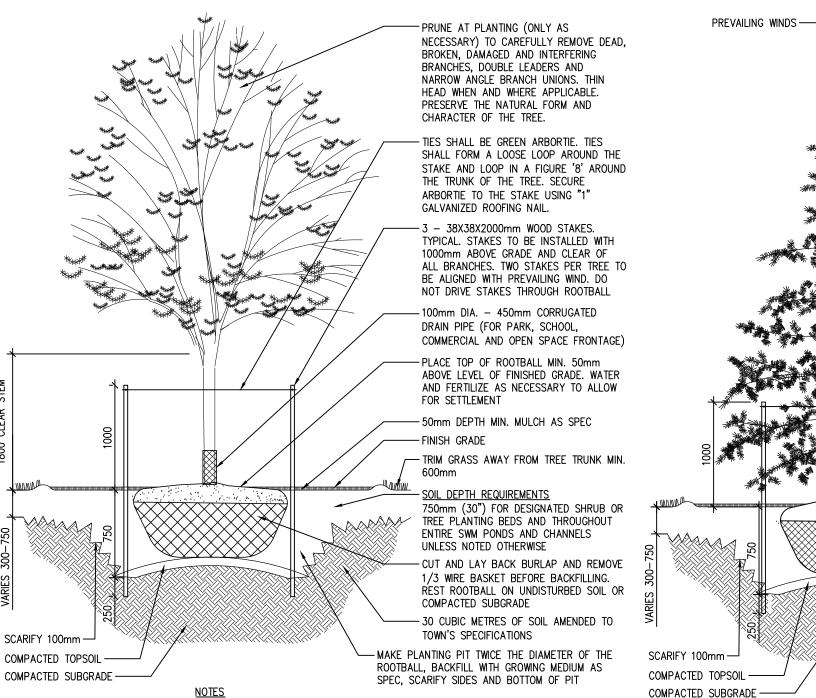PREVAILING WINDS ----PRUNE AT PLANTING (ONLY AS NECESSARY) TO CAREFULLY REMOVE DEAD, BROKEN, DAMAGED AND INTERFERING BRANCHES, DOUBLE LEADERS AND NARROW ANGLE BRANCH UNIONS. THIN HEAD WHEN AND WHERE APPLICABLE. PRESERVE THE NATURAL FORM AND CHARACTER OF THE TIES SHALL BE GREEN ARBORTIE. TIES SHALL FORM A LOOSE LOOP AROUND THE STAKE AND LOOP IN A FIGURE '8' AROUND THE TRUNK OF THE TREE. SECURE ARBORTIE TO THE STAKE USING "1" GALVANIZED ROOFING NAIL. -3 - 38X38X2000mm WOOD STAKES. TYPICAL. STAKES TO BE INSTALLED WITH 1000mm ABOVE GRADE AND CLEAR OF ALL BRANCHES, TWO STAKES PER TREE TO BE ALIGNED WITH PREVAILING WIND. DO NOT DRIVE STAKES THROUGH ROOTBALL -100mm DIA. - 450mm CORRUGATED DRAIN PIPE (FOR PARK, SCHOOL, COMMERCIAL AND OPEN SPACE FRONTAGE) -PLACE TOP OF ROOTBALL MIN. 50mm ABOVE

LEVEL OF FINISHED GRADE. WATER AND FERTILIZE AS NECESSARY TO ALLOW FOR SETTLEMENT -50mm DEPTH MIN. MULCH AS SPEC -FINISH GRADE

- TRIM GRASS AWAY FROM TREE TRUNK MIN. 600mm SOIL DEPTH REQUIREMENTS 750mm (30") FOR DESIGNATED SHRUB OR TREE

OTHERWISE -CUT AND LAY BACK BURLAP AND REMOVE 1/3 WIRE BASKET BEFORE BACKFILLING. REST ROOTBALL ON UNDISTURBED SOIL OR COMPACTED -30 CUBIC METRES OF SOIL AMENDED TO TOWN'S SPECIFICATIONS -MAKE PLANTING PIT TWICE THE DIAMETER OF THE ROOTBALL, BACKFILL WITH GROWING MEDIUM

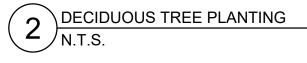
PONDS AND CHANNELS UNLESS NOTED

PLANTING BEDS AND THROUGHOUT ENTIRE SWM


AS SPEC, SCARIFY SIDES AND BOTTOM OF PIT TOPSOIL IN PLANTING AREAS SHOULD BE COMPACTED TO 80-85% SPD (MAX. 150mm LIFTS)


PLANTING SOIL AND WORK SOIL BETWEEN ROOTS. PLANT

SHRUB WITHOUT DISTURBING ROOT BALL.



(MAX. 150mm LIFTS)

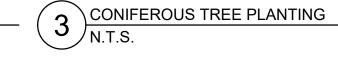

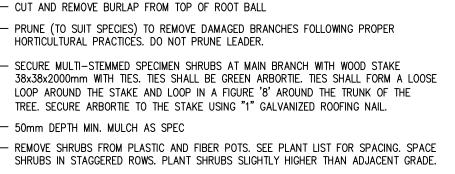


EQUIVALENT. OVERLAP MAT AND CUT AS REQUIRED — TO INSTALL PLANTING

- COMPACTED TOPSOIL - PLANTING SOIL MIX: LIGHTLY COMPACT AND WATER WELL TO ELIMINATE AIR POCKETS AND PREVENT SETTLEMENT. TOPSOIL IN PLANTING AREAS SHOULD BE COMPACTED

MULTI-STEM TREE, SHRUB AND WHIP PLANTING

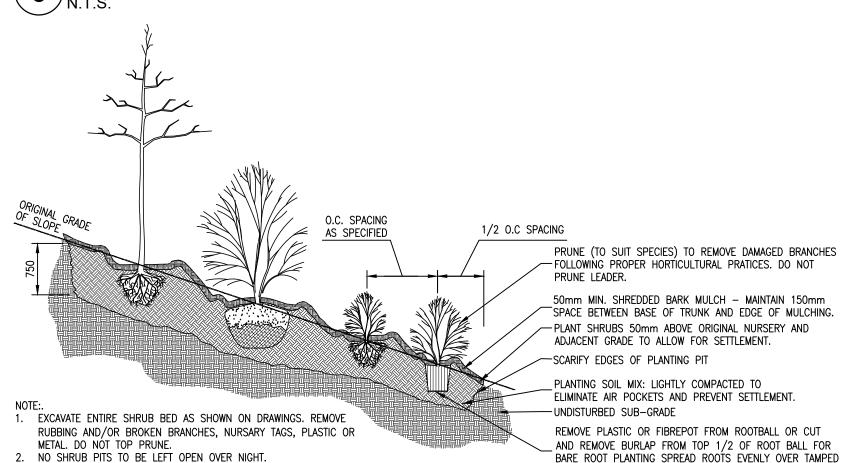TO 80-85% SPD (MAX. 150mm LIFTS)



- SCARIFY SUBGRADE OF PLANTING BED

`\MULTI-STEM TREE, SHRUB AND WHIP PLANTING ON SLOPE ∕N.T.S.

3. PROVIDE 100mm EARTH SAUCER AROUND SHRUB BED WITH 100mm

WIDE SMOOTH BED EDGE TO RETAIN MULCH.

REVISIONS

No. Description

Issued for Town Review (5th submission)

Issued for Town Review (4th submission)

Issued for Town Review (3rd submission

Issued for Town Review (2nd submission

Issued for Town Review (1st submission

Issued for Client Review

3 Issued for Client Review

CITY APPROVAL STAMP

Sept.5/2

Jul.17/25

Apr.2/25

Dec 11/24

Dec. 10/2

Jul.22/24

Jul.17/24

NAK

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PROJECT

BRONTE RIVER Oakville, Ontario

OWNER

Bronte River Limited Partnership

TITLE

PLANTING DETAILS & NOTES

DATE: JUN.3/24 SCALE: AS SHOWN DRAWN: SS

CHECKED: PD

JOB NO.: 24008

Dev. Eng. Urban Forestry, it will be refused. Wentworth County.

FORM AND VIGOUR OF TREES

All trees shall be true to type, structurally sound with no evidence of dead branches, sunscald, frost cracks, abraded or broken bark and be free of insect or disease infestation. All trees shall have full, well developed crowns with one distinctive vertical leader, and root system typical of the species. All parts shall be moist and show active green cambium when cut. All trees must meet these specifications at the time of planting. The project Arborist or Landscape Architect is to confirm compliance with the standards.

project Landscape Architect.

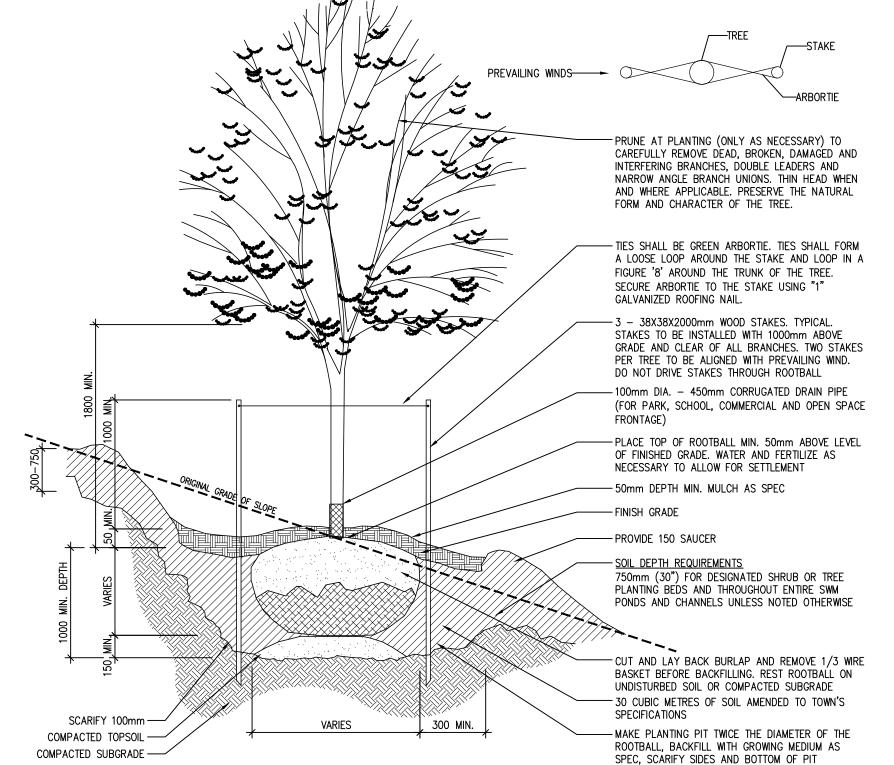
CONFORMITY TO SPECIES AND VARIETY

be accepted unless approved by Development Engineering Urban Forestry.

shall be 300 cm - 350 cm (9"8 and 11"5) in overall height, and at least 60 mm in caliper.

SHIPPING OF TREES

TOWN OF OAKVILLE PLANTING SPECIFICATIONS




DECIDUOUS TREE PLANTING ON SLOPE

[/]N.T.S.


TOPSOIL IN PLANTING AREAS SHOULD BE COMPACTED TO 80-85% SPD (MAX. 150mm LIFTS)

PREVAILING WINDS -- PRUNE AT PLANTING (ONLY AS NECESSARY) TO ----ARBORTIE CAREFULLY REMOVE DEAD, BROKEN, DAMAGED AND INTERFERING BRANCHES, DOUBLE LEADERS AND NARROW ANGLE BRANCH LINIONS THIN HEAD WHEN AND WHERE APPLICABLE. PRESERVE THE NATURAL FORM AND CHARACTER OF THE TREE. - TIES SHALL BE GREEN ARBORTIE. TIES SHALL FORM A LOOSE LOOP AROUND THE STAKE AND LOOP IN A FIGURE '8' AROUND THE TRUNK OF THE TREE. SECURE ARBORTIE TO THE STAKE USING "1" GALVANIZED ROOFING NAIL. -3 - 38X38X2000mm WOOD STAKES. TYPICAL. STAKES TO BE INSTALLED WITH 1000mm ABOVE GRADE AND CLEAR OF ALL BRANCHES. TWO STAKES PER TREE TO BE ALIGNED WITH PREVAILING WIND. DO NOT DRIVE STAKES THROUGH ROOTBALL -100mm DIA. - 450mm CORRUGATED DRAIN PIPE (FOR PARK, SCHOOL, COMMERCIAL AND OPEN SPACE - PLACE TOP OF ROOTBALL MIN. 50mm ABOVE LEVEL OF FINISHED GRADE. WATER AND FERTILIZE AS NECESSARY TO ALLOW FOR SETTLEMENT - 50mm DEPTH MIN. MULCH AS SPEC -FINISH GRADE - PROVIDE 150 SAUCER - SOIL DEPTH REQUIREMENTS 750mm (30") FOR DESIGNATED SHRUB OR TREE PLANTING BEDS AND THROUGHOUT ENTIRE SWM PONDS AND CHANNELS - UNLESS NOTED OTHERWISE CUT AND LAY BACK BURLAP AND REMOVE 1/3 WIRE SCARIFY 100mm -BASKET BEFORE BACKFILLING. REST ROOTBALL ON UNDISTURBED SOIL OR COMPACTED SUBGRADE COMPACTED TOPSOIL -- 30 CUBIC METRES OF SOIL AMENDED TO TOWN'S COMPACTED SUBGRADE -SPECIFICATIONS - MAKE PLANTING PIT TWICE THE DIAMETER OF THE ROOTBALL, BACKFILL WITH GROWING MEDIUM AS TOPSOIL IN PLANTING AREAS SHOULD BE COMPACTED TO 80-85% SPD (MAX. 150mm LIFTS) SPEC, SCARIFY SIDES AND BOTTOM OF PIT
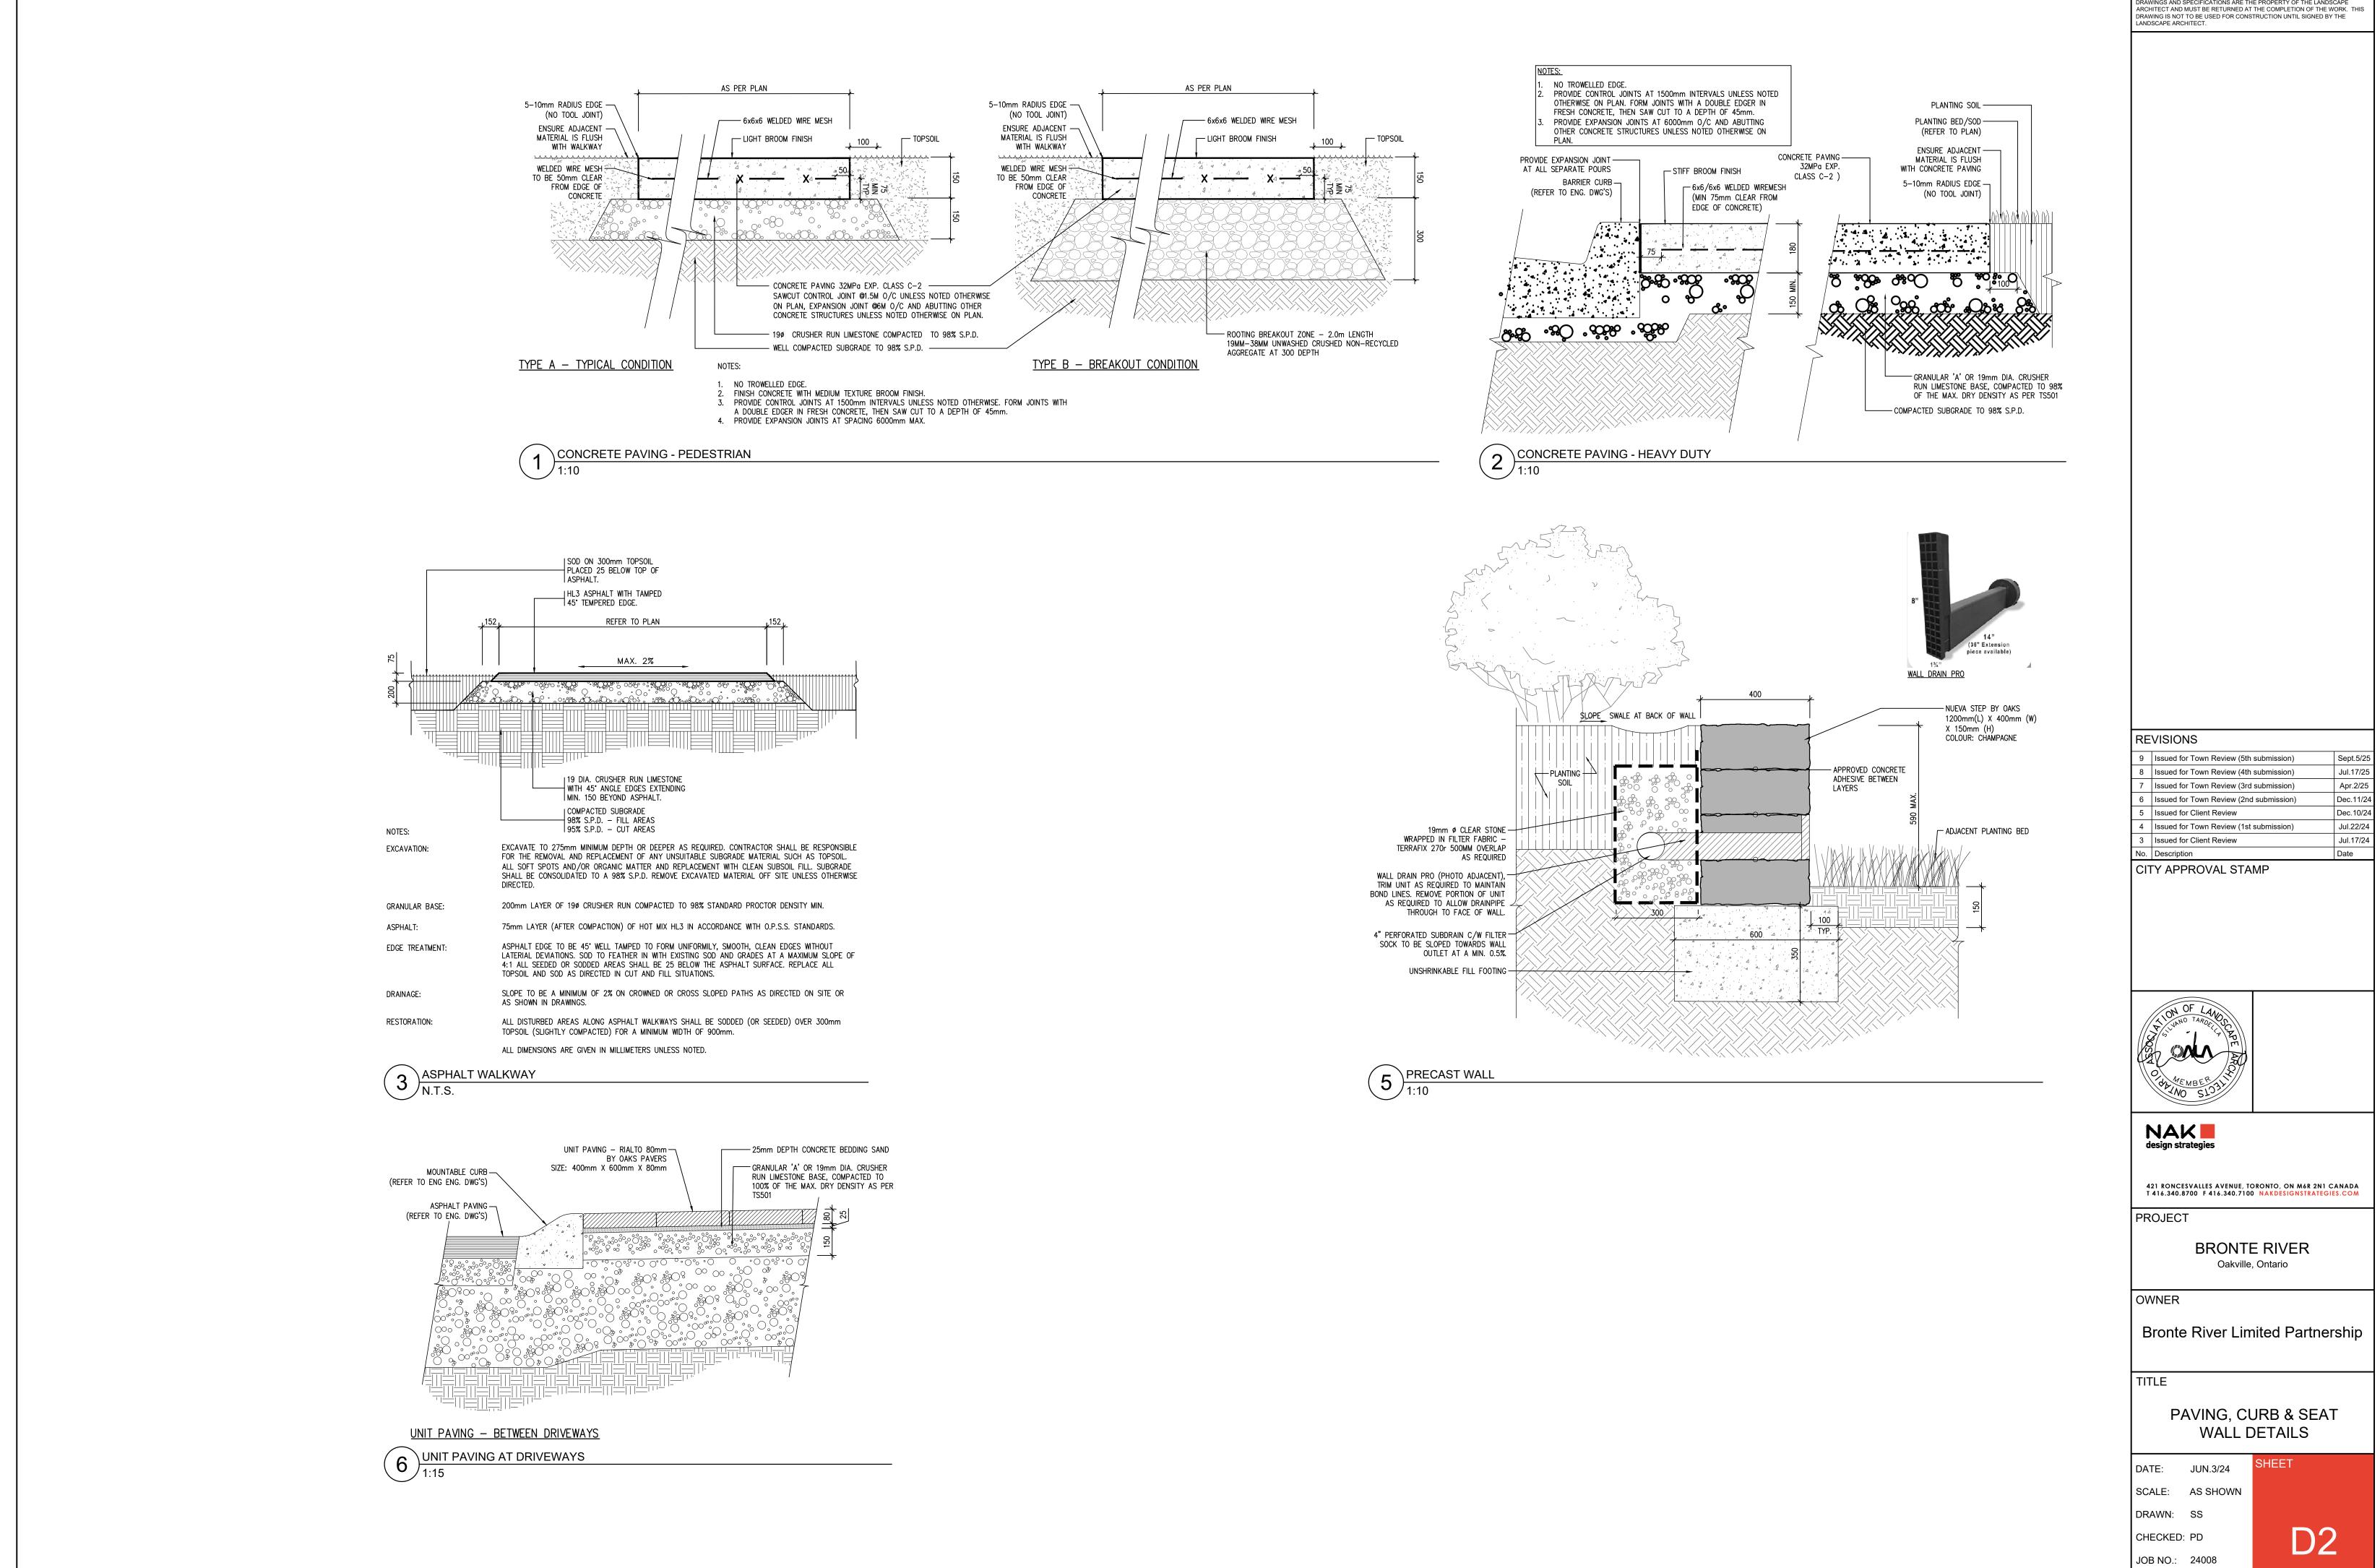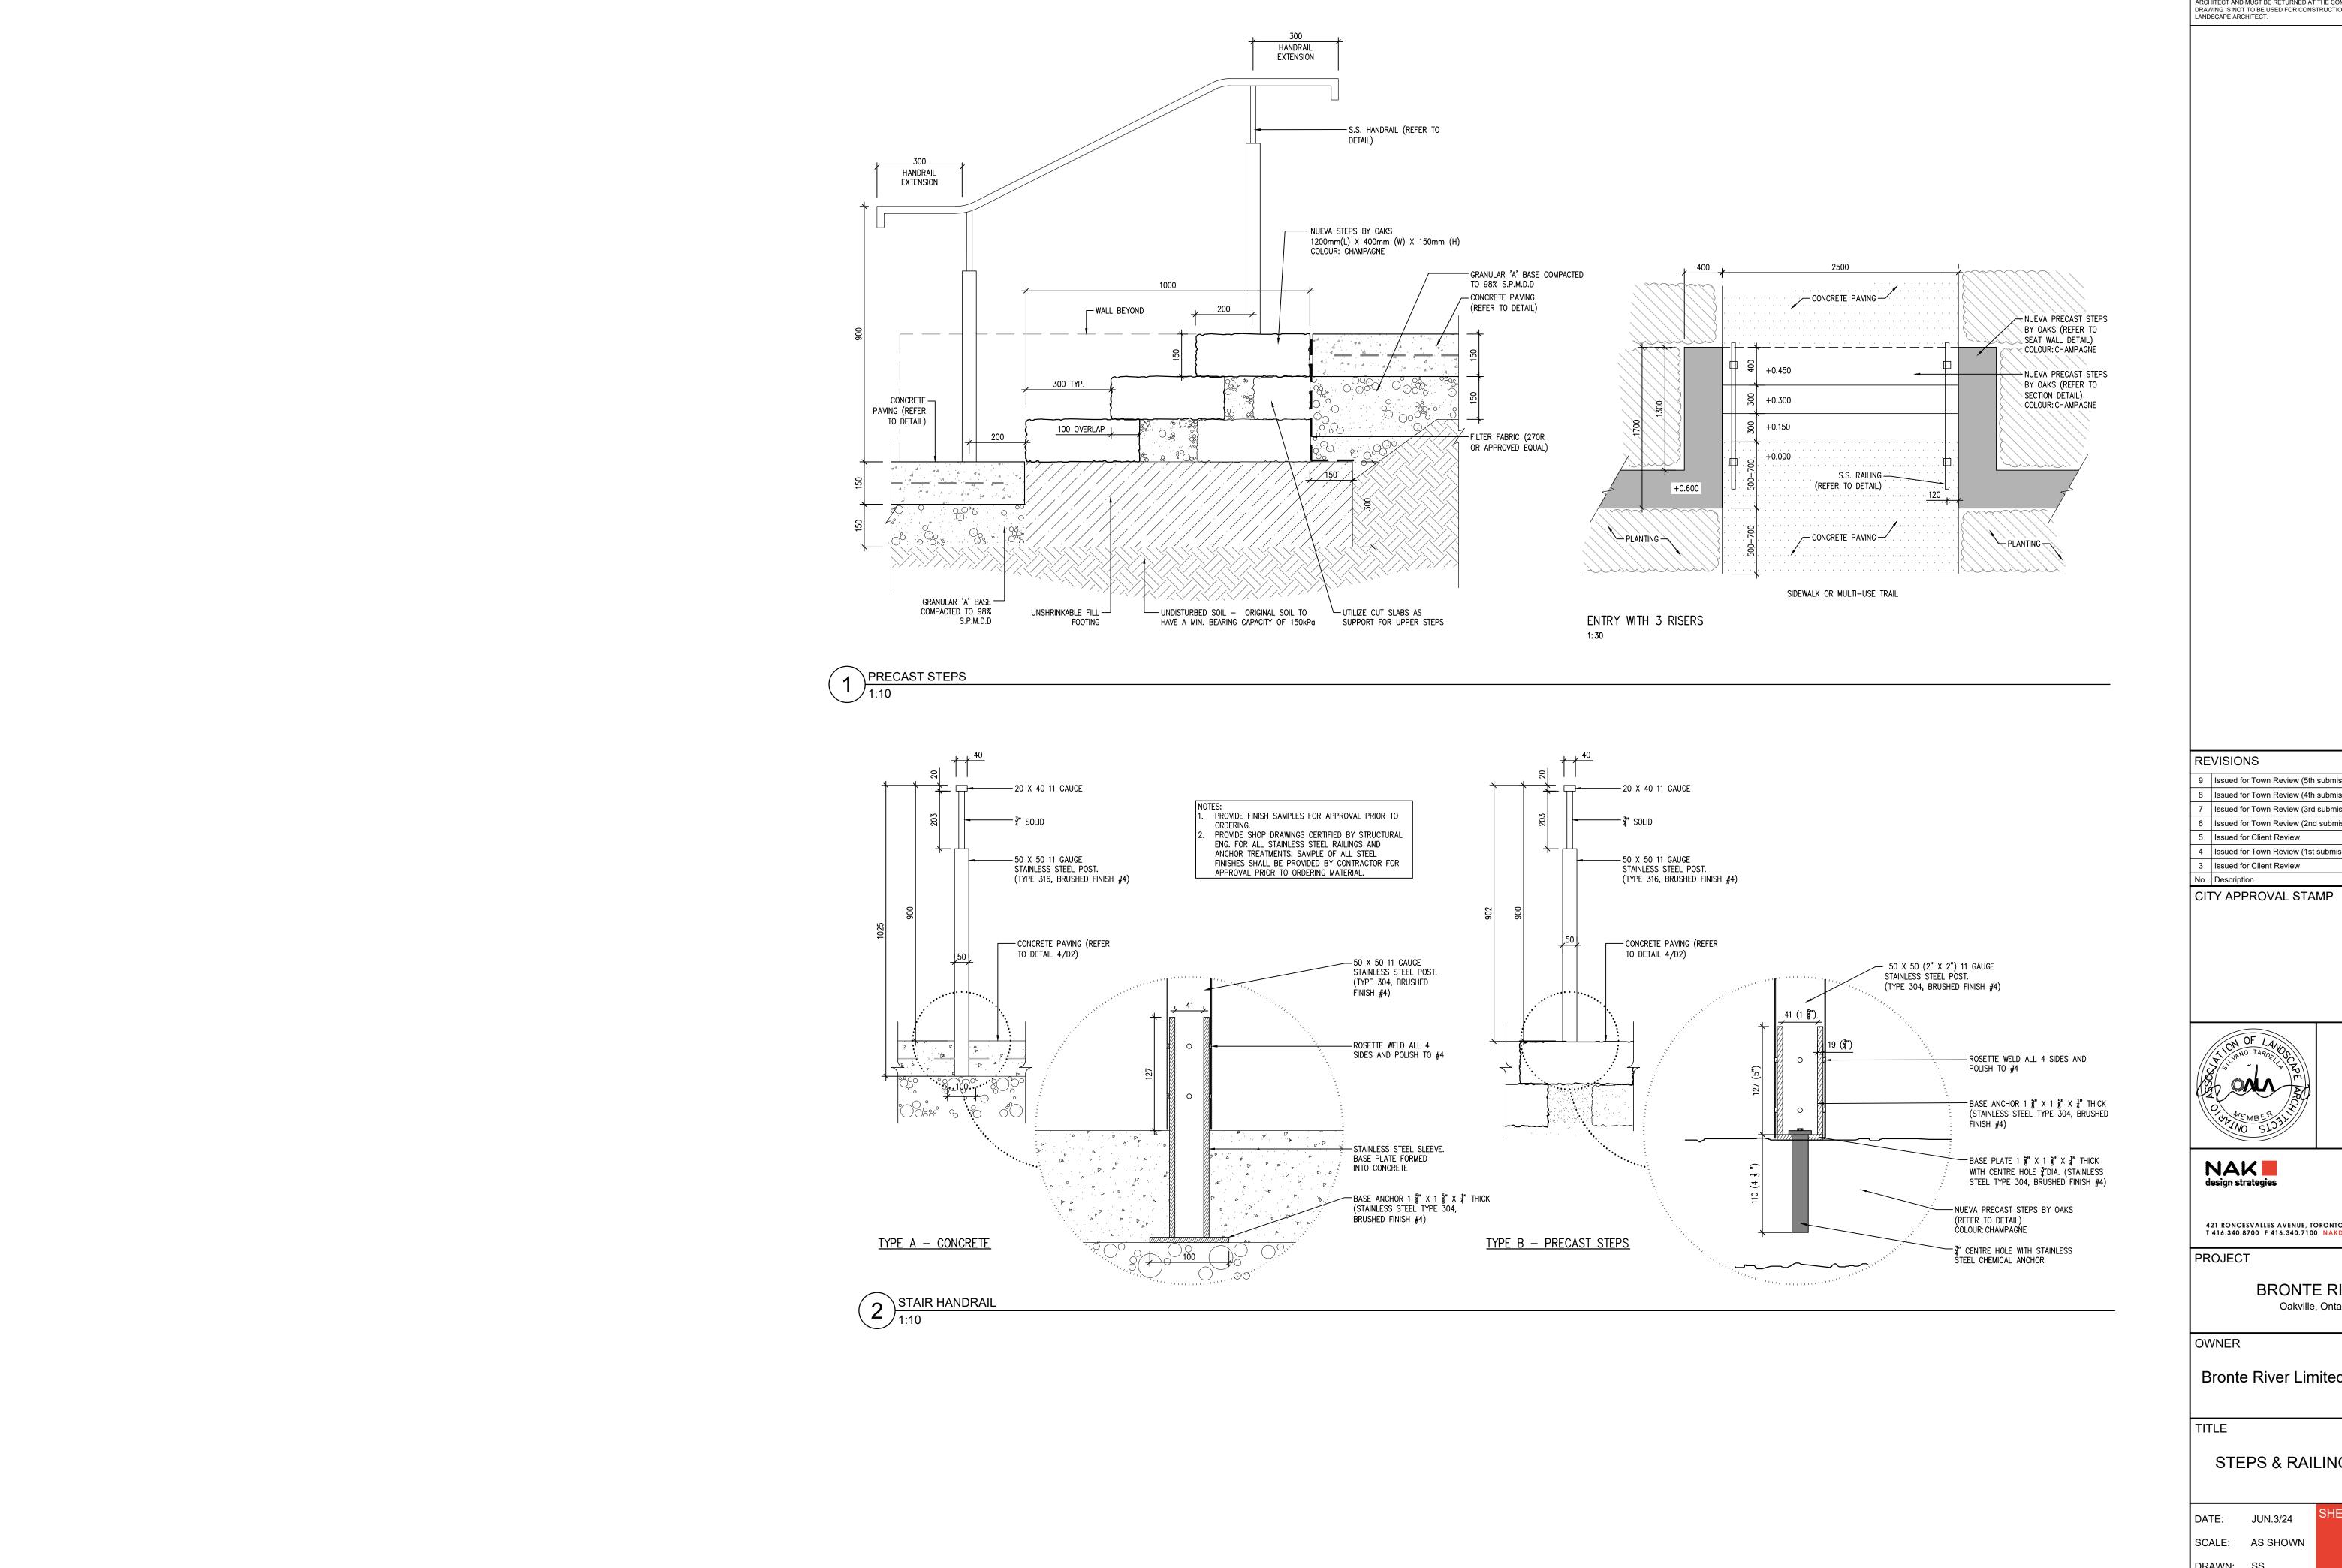
`\CONIFEROUS TREE PLANTING ON SLOPE



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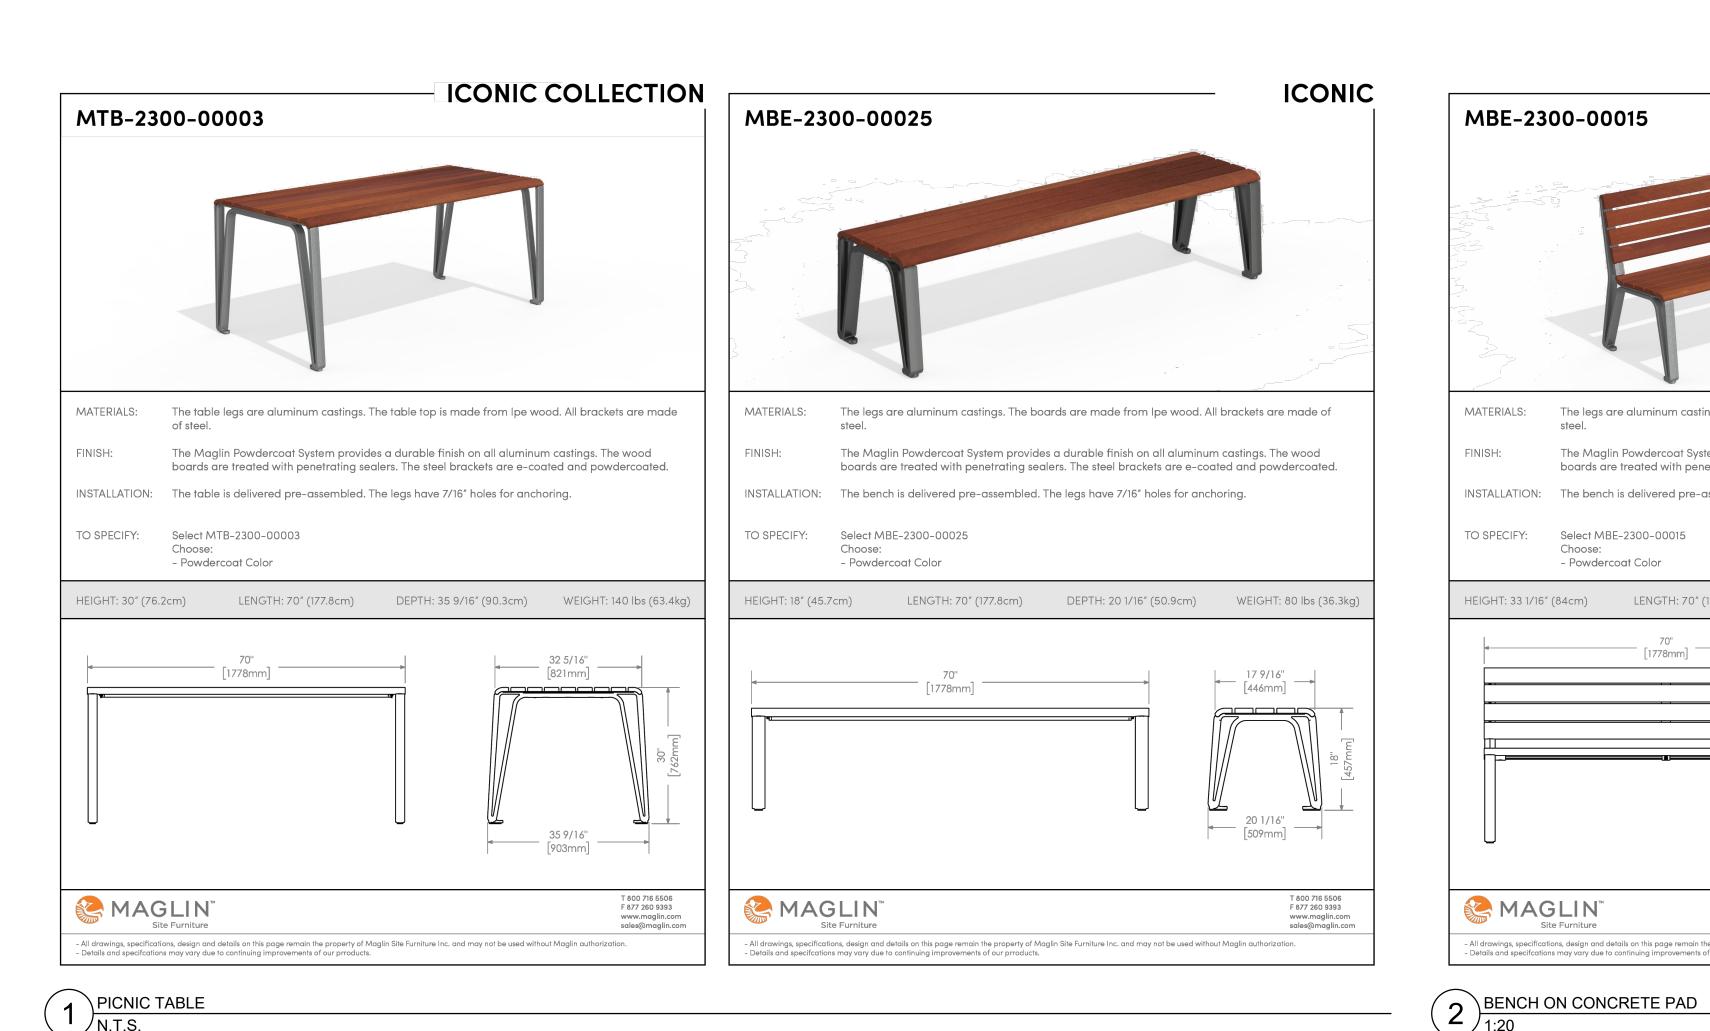
BRONTE RIVER Oakville, Ontario

Bronte River Limited Partnership

STEPS & RAILING DETAILS

DRAWN: SS

CHECKED: PD



ICONIC

Sustainability Facts

Unit Size One (1) MBR-2300-00001 Bike Rack

Carbon footprint (GWP) 139 kg CO2-Eq Measured in kilograms of carbon dioxide equivalent

1.9 m3 water

WEIGHT: 18 lbs (8kg)

T 800 716 5506 F 877 260 9393

www.maglin.com sales@maglin.com

Total energy use (TPE)

Measured in cubic metres of water

Type III Environmental Product Declaration

Waster use (WDP)

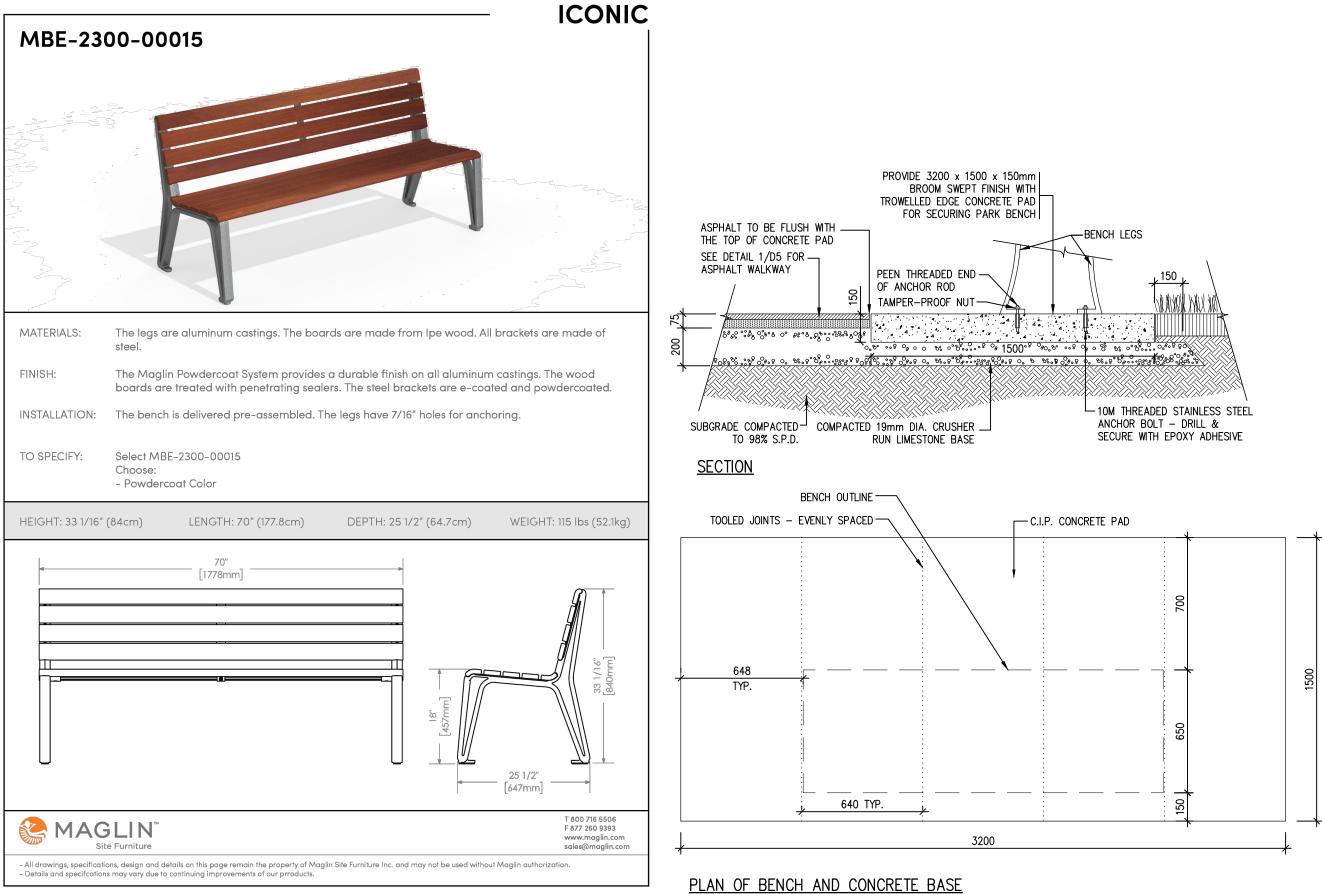
LEED v4.1 Credits

Material Inventory
Low VOC finishes

WIDTH: 2" (5.1cm)

Free of Red List substance

Material recyclability



Select MBR-2300-00001

- Powdercoat Color

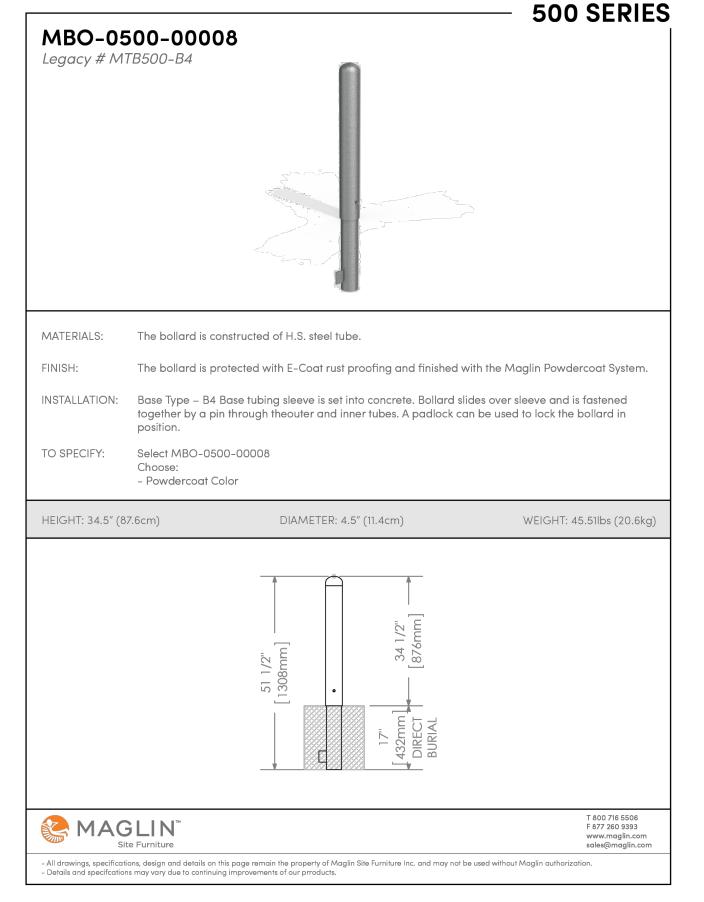
HEIGHT: 26 1/2" (67.3cm) LENGTH: 20 1/2" (52cm)

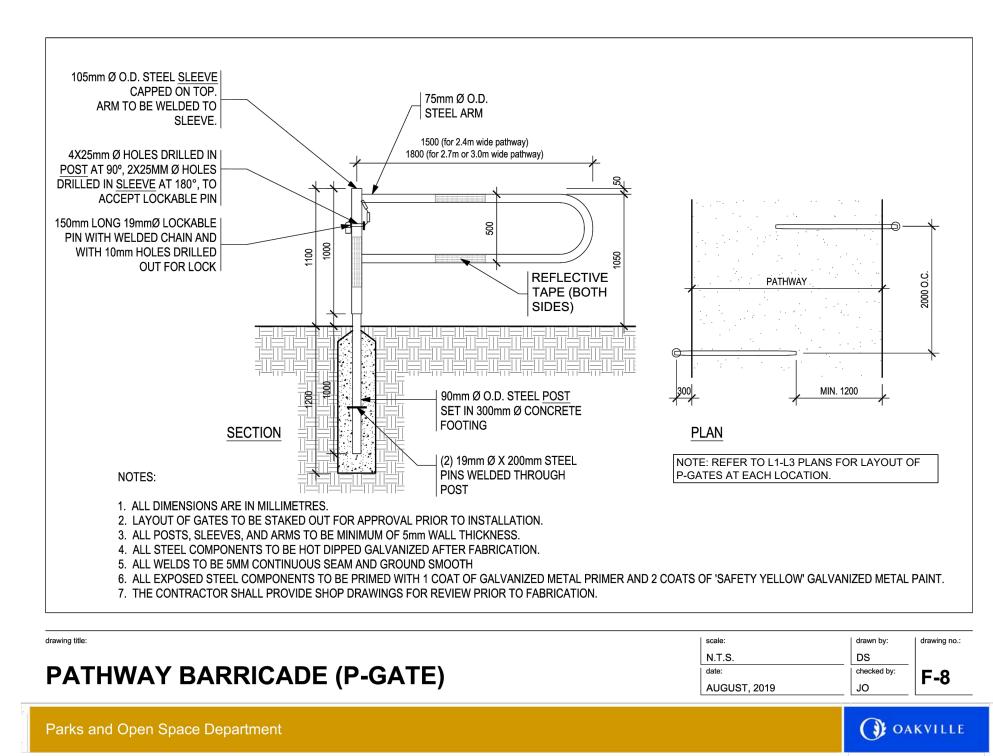
DESCRIPTION: 2300 Series - Iconic Bike Rack: Cast Aluminum, Surface Mount, 2 Bike Configuration

The Maglin Powdercoat System provides a durable finish on all aluminum castings.

INSTALLATION: The bike rack is delivered in parts. Reference INSTALL_MBR-2300-00001 PDF for more information.

MBR-2300-00001





- All drawings, specifications, design and details on this page remain the property of Maglin Site Furniture Inc. and may not be used without Maglin authorization.

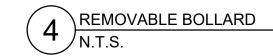
- Details and specifications may vary due to continuing improvements of our products.

BIKE RACK
N.T.S.

MAGLIN

FINISH:

TO SPECIFY:




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CITY APPROVAL STAMP



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PROJECT

BRONTE RIVER
Oakville, Ontario

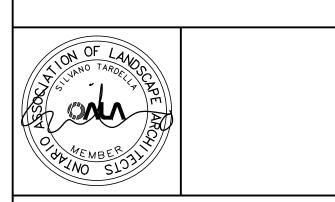OWNER

JOB NO.: 24008

Bronte River Limited Partnership

TITLE

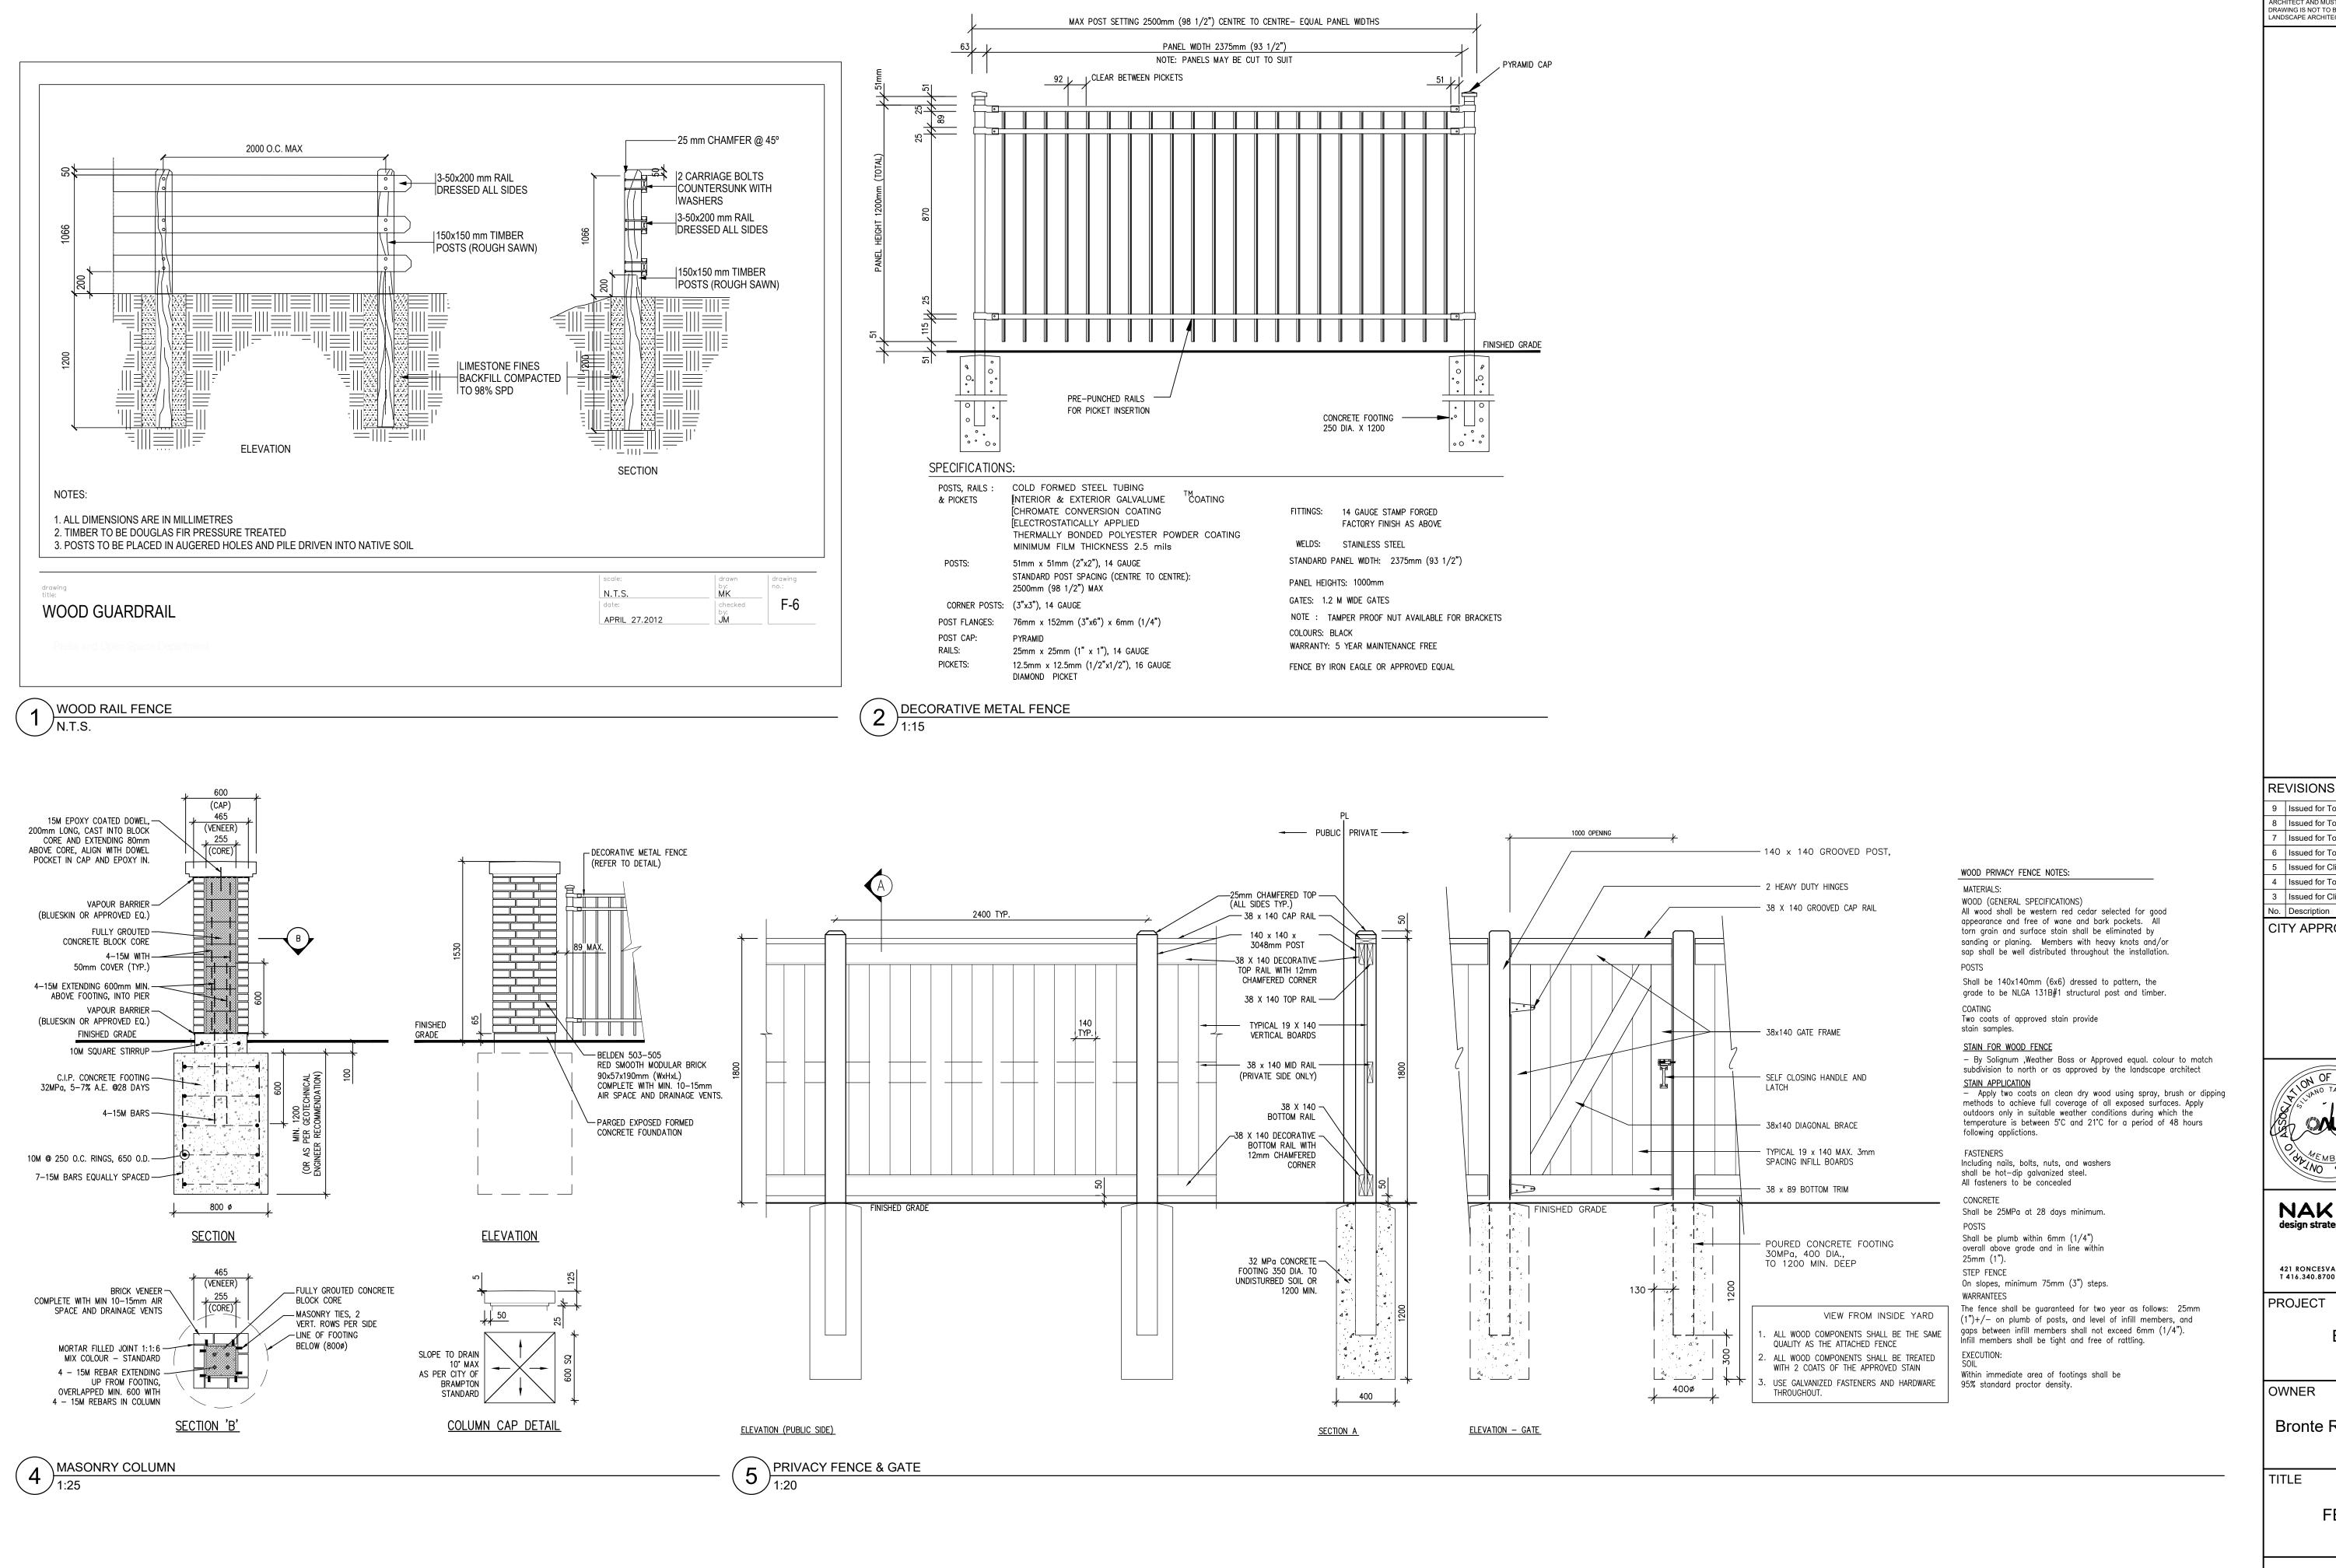
SITE FURNISHINGS DETAILS

DATE: JUN.3/24

SCALE: AS SHOWN

DRAWN: SS

CHECKED: PD




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BRONTE RIVER Oakville, Ontario

OWNER

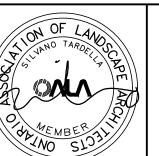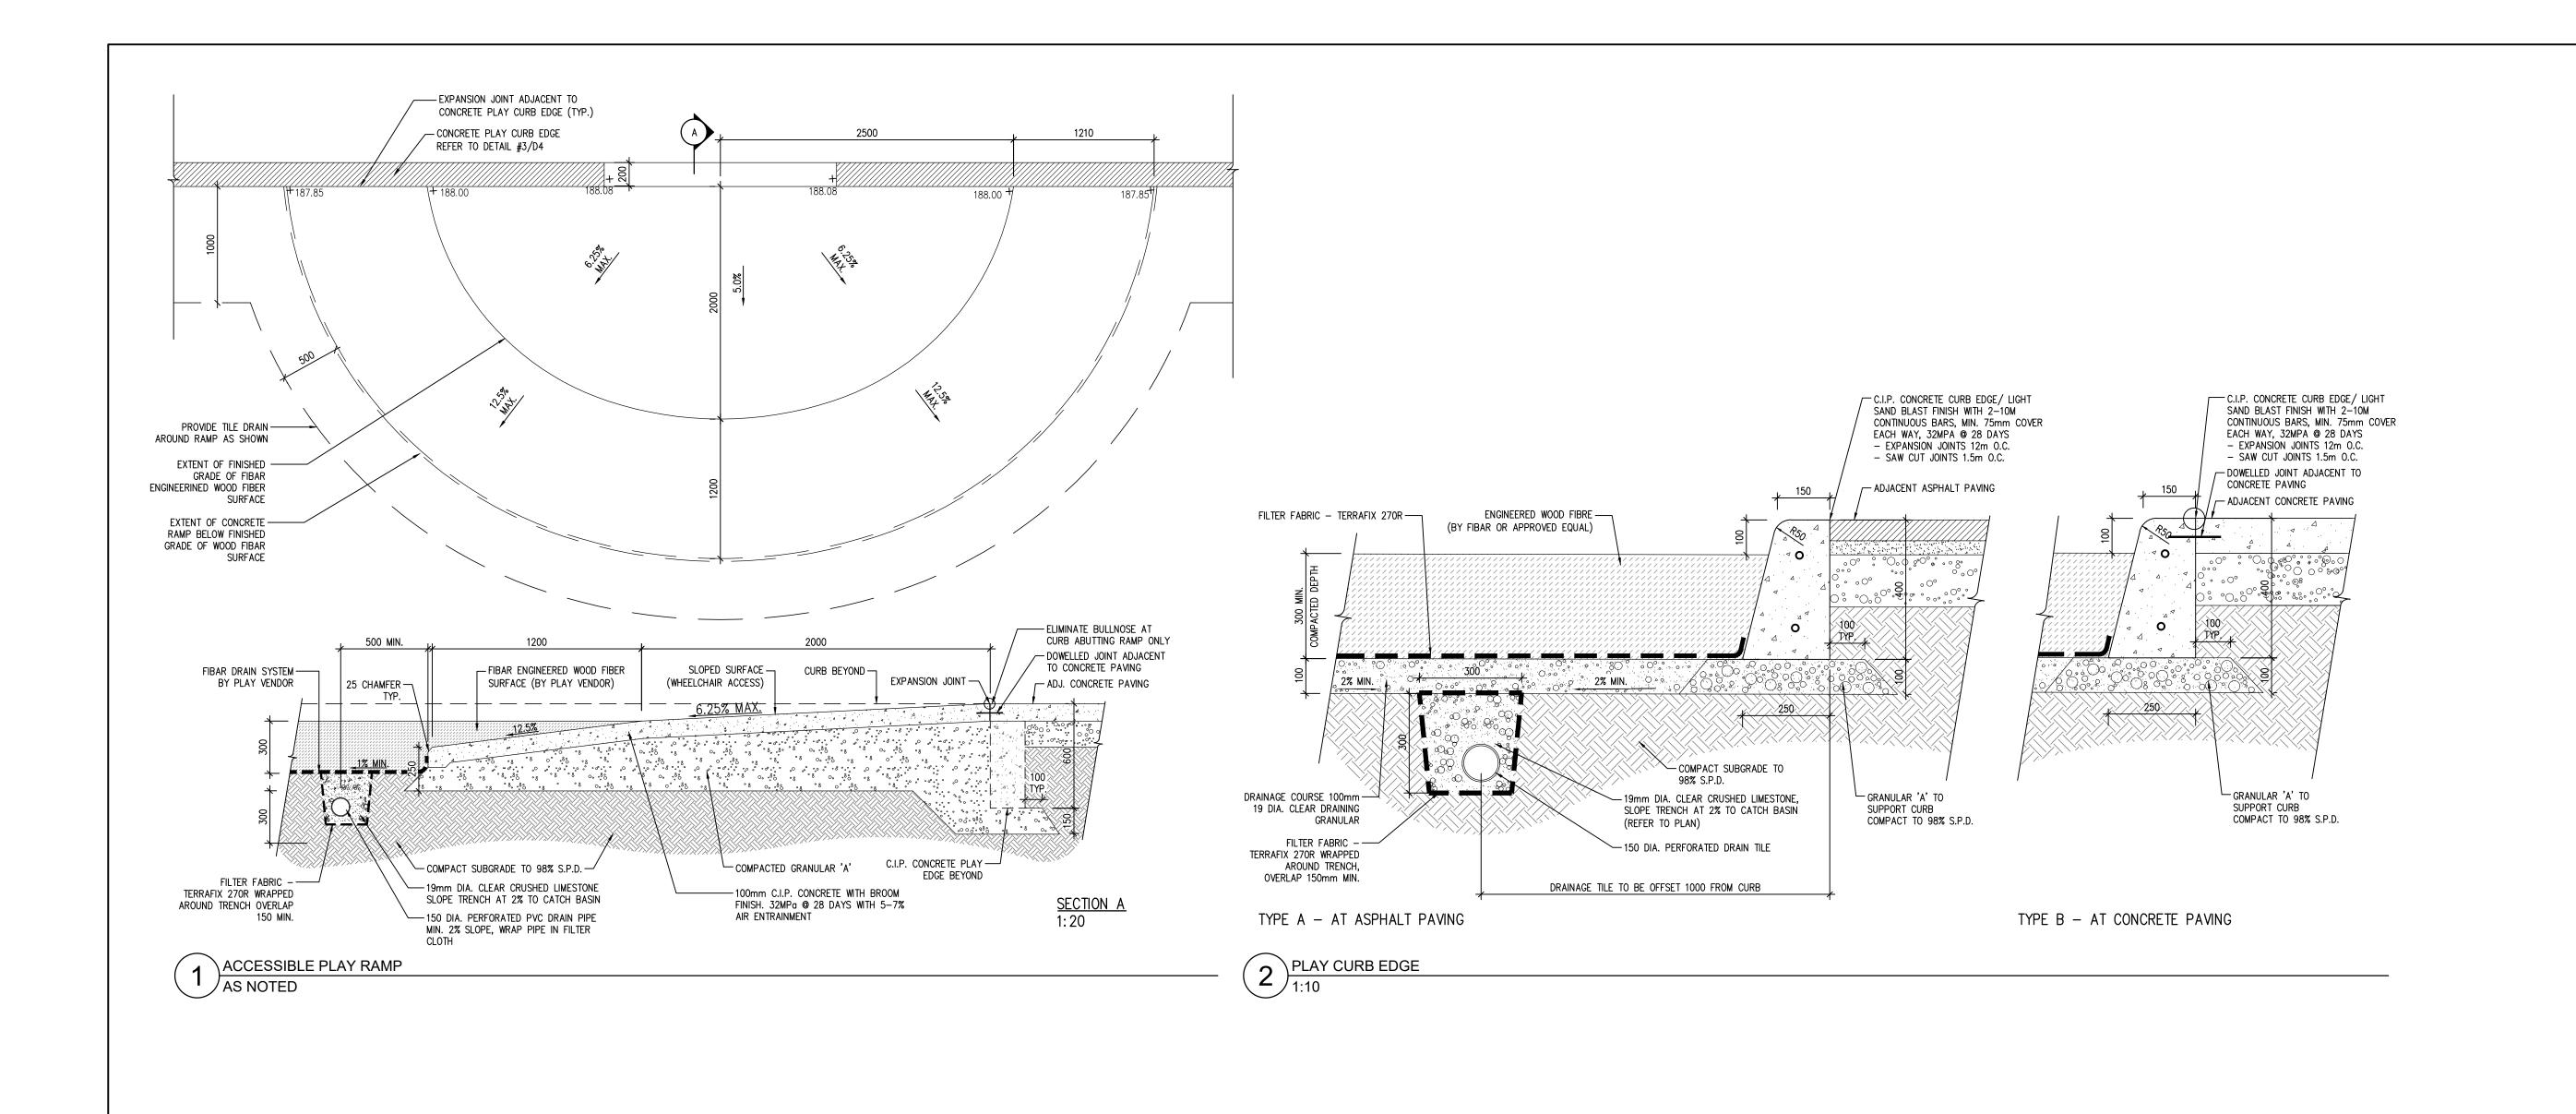
Bronte River Limited Partnership

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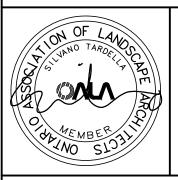


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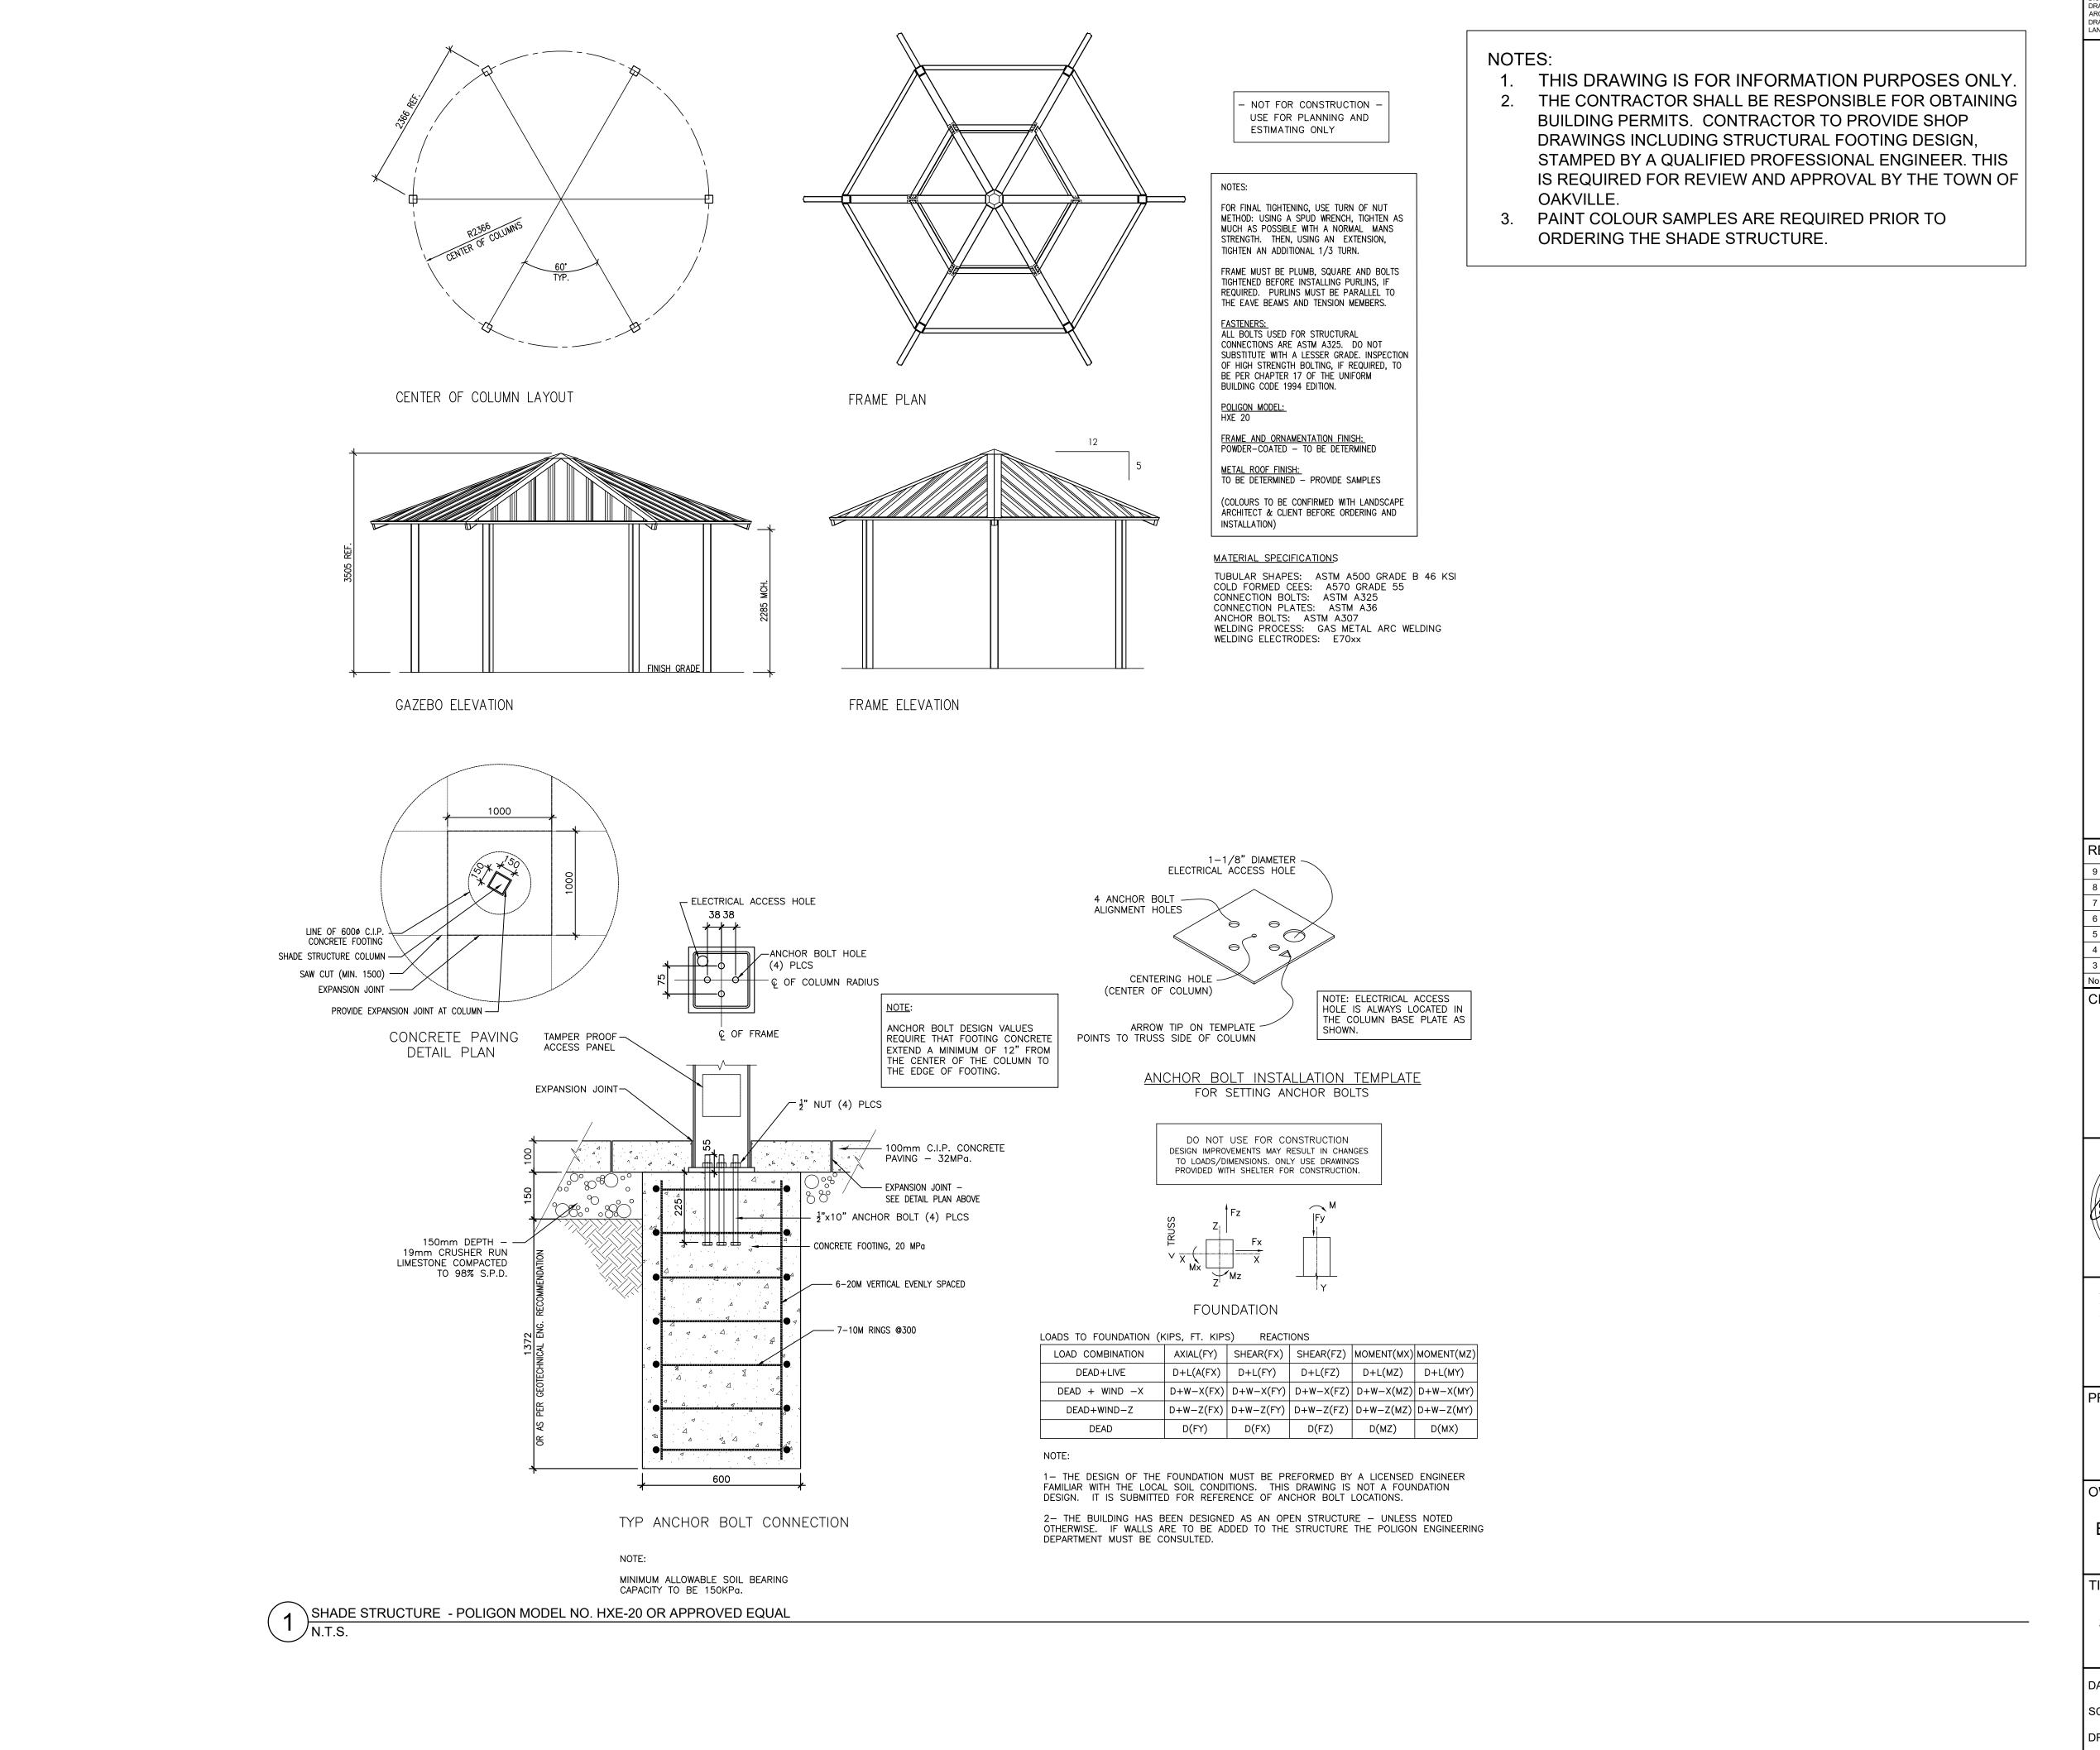
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PLAY AREA DETAILS

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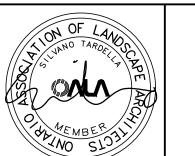
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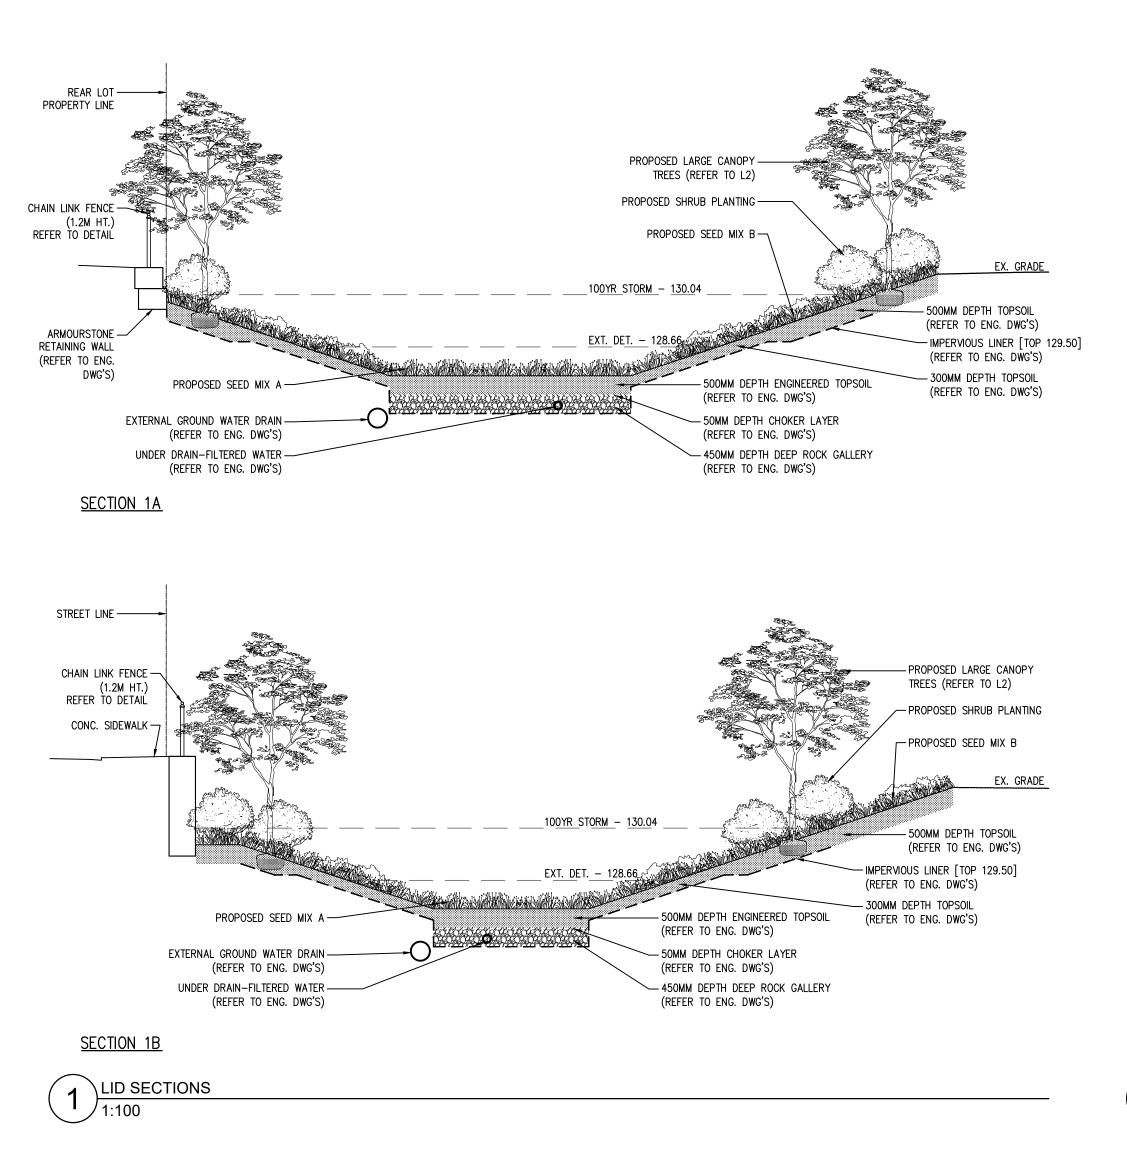
SHADE STRUCTURE DETAILS


DATE: JUN.3/24 SCALE: AS SHOWN

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JOB NO.: 24008

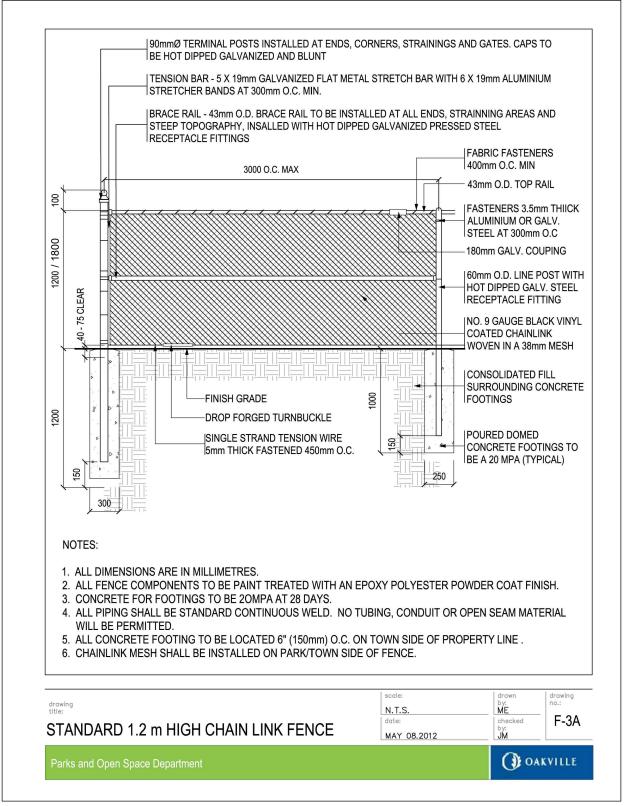D7





— CHAIN LINK FENCE (REFER TO DETAIL) - SECURE POST WITH HIGH PERFORMANCE, NON-SHRINK, CEMENTIOUS GROUT FROM BOTTOM UP TO TOP OF CAP. GROUT COLOUR MATCHED TO PRECAST. GROUT MUST BE APPLIED IN ACCORDANCE WITH MANUFACTURERS SPECIFICATIONS. CORE DRILLED VOID MUST BE CLEAN AND FREE OF DEBRIS PRIOR TO GROUTING __ ARMOURSTONE RETAINING WALL (REFER TO ENG. DWG) - APPROVED BACKFILL ADJACENT LID PLANTING — (REFER TO L1-L2) DRAINAGE TILE CHAIN LINK FENCE INSTALLATION ON

RETAINING WALL 1:25

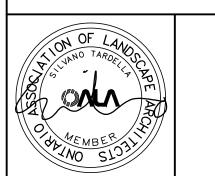
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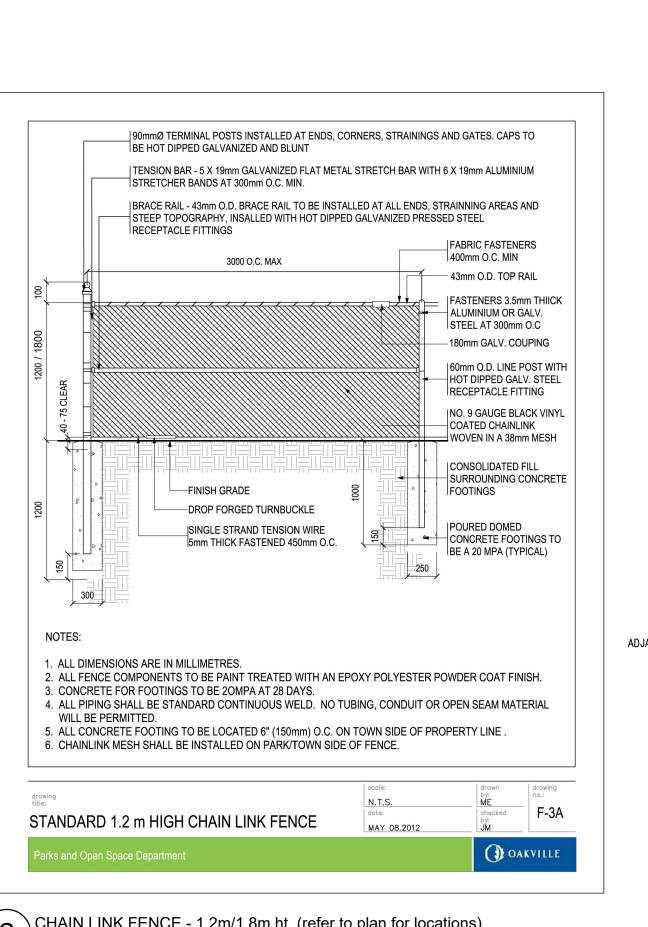
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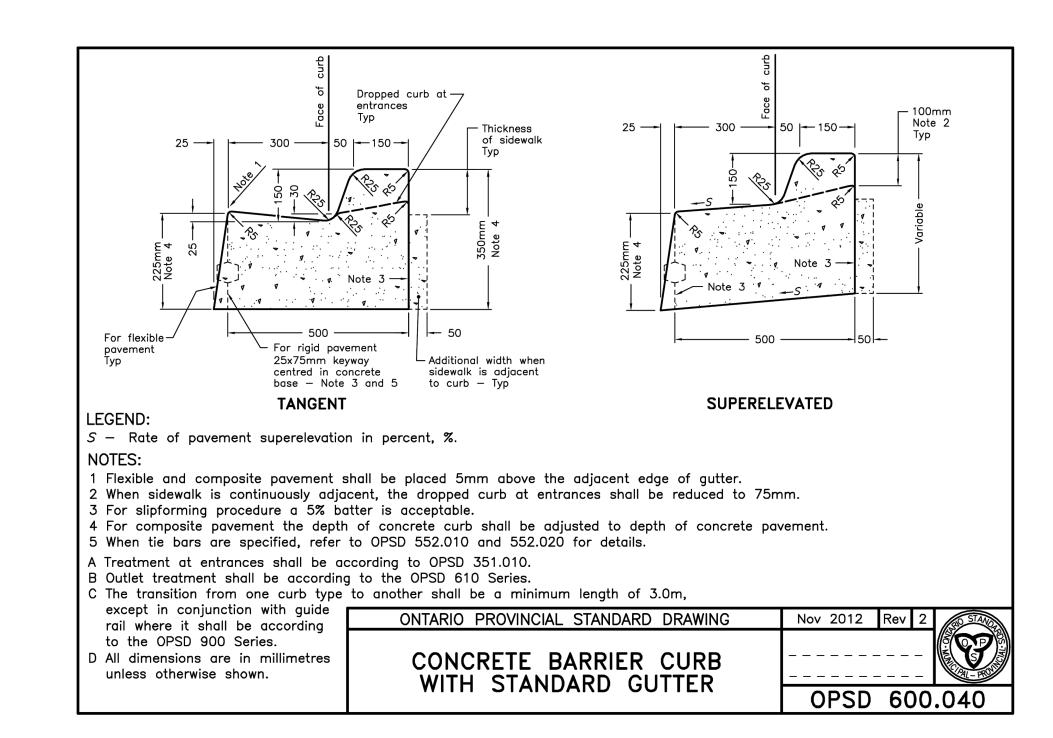
LID SECTIONS & FENCING **DETAILS**

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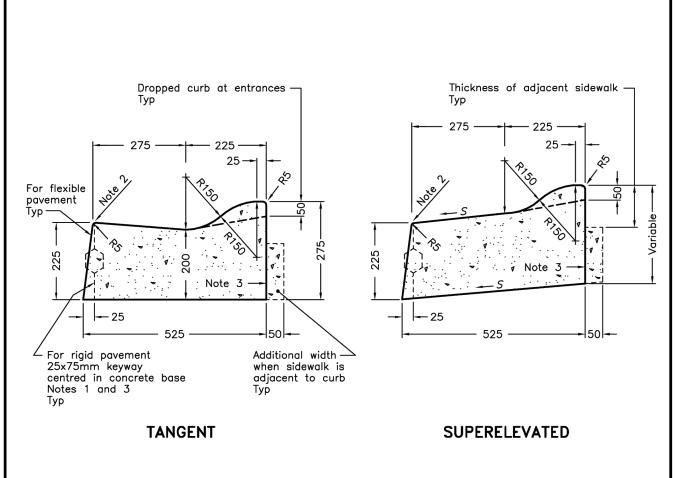






NOTES:

1. THIS DRAWING IS FOR REFERENCE PURPOSES ONLY. 2. REFER TO ENGINEERING DRAWING AG-1 ABOVE GROUND SERVICING PLAN FOR SPECIFIC LOCATIONS OF EACH TYPE OF CURB.



LEGEND:

S — Rate of pavement superelevation in percent, %.

- 1 When curb and gutter is adjacent to concrete pavement or base, this drawing shall be used in conjunction with OPSD 552.010 and 552.020.
- 2 Flexible and composite pavement shall be placed 5mm above the adjacent edge of gutter.
- 3 For slipforming procedure a 5% batter is acceptable.
- A Treatment at entrances shall be according to OPSD 351.010.
- B Outlet treatment shall be according to the OPSD 610 Series.
- C The transition from one curb type to another shall be a minimum length of 3.0m, except in conjunction with guide rail where it shall be according to the OPSD 900 Series.
- D All dimensions are in millimetres unless otherwise shown.

ONTARIO PROVINCIAL STANDARD DRAWING	Nov 2012	Rev	2 STAND
CONCRETE SEMI-MOUNTABLE		·	
CURB WITH STANDARD GUTTER	OPSD	60	0.060

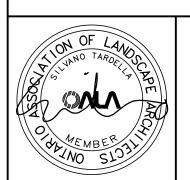
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