

100 NUGGET AVENUE, TORONTO, ONTARIO M1S 3A7 • TEL: (416) 754-8515 • FAX: (416) 754-8516

						III AAN TON
BARRIE	MISSISSAUGA	OSHAWA	NEWMARKET	GRAVENHURST	PETERBOROUGH	HAMILTON
TEL: (705) 721-7863	TEL: (905) 542-7605	TEL: (905) 440-2040	TEL: (905) 853-0647	TEL: (705) 684-4242	TEL: (905) 440-2040	TEL: (905) 777-7956
FAX: (705) 721-7864	FAX: (905) 542-2769	FAX: (905) 725-1315	FAX: (416) 754-8516	FAX: (705) 684-8522	FAX: (905) 725-1315	FAX: (905) 542-2769

# A REPORT TO SHERBORNE LODGE DEVELOPMENTS LIMITED c/o TRINISON MANAGEMENT CORPORATION

# PHASE ONE ENVIRONMENTAL SITE ASSESSMENT

#### PROPOSED RESIDENTIAL DEVELOPMENT

382 BURNHAMTHORPE ROAD WEST TOWN OF OAKVILLE

Reference No. 1410-E133

October 9, 2014

# **DISTRIBUTION**

5 Copies - Trinison Management Corporation

#### **LIMITATIONS OF LIABILITY**

This report was prepared by Soil Engineers Ltd. for the account of Sherborne Lodge Developments Limited c/o Trinison Management Corporation, and for review by its designated agents, financial institutions and government agencies, and can be used for development approval purposes by the Town of Oakville and their peer reviewer who may rely on the results of the report. The material in it reflects the judgements of Wilson Jiang, Ph.D., and Ian Chiu, P.Eng., QP<sub>ESA</sub> in light of the information available at the time of preparation. Any use which a Third Party makes of this report, and/or any reliance on decisions to be made based on it, are the responsibility of such Third Parties. Soil Engineers Ltd. accepts no responsibility for damages, if any, suffered by any Third Party as a result of decisions made or actions based on this report.

One must understand that the mandate of Soil Engineers Ltd. is to obtain readily available past and present information pertinent to the Phase One Property for a Phase One Environmental Site Assessment only. No other warranty or representation, expressed or implied, as to the accuracy of the information is included or intended by this assessment. Site conditions, environmental or otherwise, are not static, and this report documents site conditions observed at the time of the site reconnaissance.

It should be noted that the information supplied in this report is not sufficient to obtain approval for disposal of excess soil or materials generated during any construction.

# **TABLE OF CONTENTS**

1.0	EXI	CUTIVE SUMMARY	1
2.0	INT	RODUCTION	2
	2.1	Phase One Property Information	2
	2.2	Contact Information.	
3.0	SCO	PE OF INVESTIGATION	5
4.0	REV	IEW OF RECORDS	6
	4.1	General	6
		(i) Phase One Study Area	6
		(ii) First Developed Use	6
		(iii) Fire Insurance Plans	7
		(iv) Chain of Title	7
		(v) Review of Previous Environmental Reports	
	4.2	Environmental Source Information	8
		(i) Ministry of the Environment	8
		(ii) Environment Canada	
		(iii) Other Sources	10
	4.3	Physical Setting Sources	13
		(i) Aerial Photographs	
		(ii) Topography, Hydrology and Geology	
		(iii) Fill Material and Topsoil	15
		(iv) Water Bodies and Areas of Natural Significance	
		(v) Well Records	16
	4.4	Occupancy Search	
	4.5	Summary of Records Review	
5.0	INT	ERVIEWS	19
	5.1	Summary of Interviews	

# TABLE OF CONTENTS (Cont'd)

6.0	SITI	E RECONNAISSANCE	20
	6.1	General	20
	6.2	Specific Observations at Phase One Property	
		(i) Building Inspection	
		(ii) Hazardous Materials	
		(iii) Underground Storage Tanks	
		(iv) Above-Ground Storage Tanks	
		(v) Substance Containers	
		(vi) Waste Management and Maintenance Practices	
		(vii) Air Quality and Noise	
		(viii) Water Wells and Septic System	
		(ix) Phase One Study Area Inspection	
		(x) Enhanced Property Investigation	
		(xi) Written Description of Investigation	
	6.3	Summary of Site Reconnaissance	
7.0	REV 7.1 7.2	VIEW AND EVALUATION OF INFORMATION	28 28
		(i) Potentially Contaminating Activity Classification	
		(ii) Other Environmental Items	
	7.3	Areas of Potential Environmental Concern	
	7.4	Phase One Conceptual Site Plan	32
3.0	CON	NCLUSION	
	8.1	Phase Two ESA Recommendation	
	8.2	RSC Requirements	33
	8.3	Environmentally Sensitive Area, Body of Water, ANSI	
	8.4	Legal Requirements	34
9.0	RFF	ERENCES	35
	1/1		



# **TABLES**

Table 1 - Property Identification Number and Property Description  Table 2 - Structures on Phase One Property  Table 3 - Record of Site Condition  Table 4 - Records in EcoLog ERIS Report  Table 5 - Site Reconnaissance Conditions  DRAWINGS	3 9 11
Site Location Plan.	Drawing No. 1
Property Index Map (Block 24929)	Drawing No. 2
Survey Plan	Drawing No. 3
1877 Historical Map	Drawing No. 4
1982 Ontario Base Map	Drawing No. 5
2004 Topographic Map	Drawing No. 6
2008 Geological Map	Drawing No. 7
2011 Hydrogeological Map	Drawing No. 8
2006 Watershed Map	Drawing No. 9
Environmental Map	Drawing No. 10
Phase One Conceptual Site Plan	Drawing No. 11
APPENDICES	
MPAC Report	Appendix 'A'
Ownership History	Appendix 'B'
Freedom of Information	Appendix 'C'
EcoLog ERIS Report	Appendix 'D'
Aerial Photographs	Appendix 'E'
MOE Well Records	Appendix 'F'
Occupancy Search	Appendix 'G'
Landowner/Tenant/Occupant Questionnaire	Appendix 'H'
Site Photographs	Appendix 'I'
Table of Current and Past Uses	Appendix 'J'



1.0

#### EXECUTIVE SUMMARY

Soil Engineers Ltd. was retained by Sherborne Lodge Developments Limited, c/o Trinison Management Corporation, to carry out a Phase One Environmental Site Assessment (hereinafter referred to as "ESA") for a property located at the southeast corner of Burnhamthorpe Road West and Neygawa Boulevard, in the Town of Oakville (hereinafter referred to as the "Phase One Property").

The purpose of the study is to identify any potential environmental concern associated with the Phase One Property. The findings from our research of documents pertaining to the Phase One Property, interviews with persons knowledgeable of the Phase One Property and an environmental site reconnaissance, together with our assessment, are presented in this report.

Throughout the years, the Phase One Property was used for agricultural purposes until mid-1980s, and then it has been mainly used for green pastures, horse breeding and riding training, recreational and residential purposes for recent decades. On-site structures are noted at the Phase One Property during the site reconnaissance. Neighbouring properties consist mainly of agricultural lands in all directions with the exception of an Area of Natural Scientific Interest (ANSI) area at the south, and an institutional development at the northwest across the Neyagawa Boulevard.

Based on a review of records and site reconnaissance, the Phase One Property is adjacent to roadways. These items are generally considered as an environmental concern due to the potential presence of parameters such as Sodium Adsorption Ratio (SAR) and Electrical Conductivity (EC) commonly found in de-icing chemicals used during the winter season. Therefore, high levels of SAR and EC are anticipated in the soil at properties adjacent to a roadway. If the soil remains in situ, it is considered to meet the applicable standards through clause 48(3) of O. Reg. 153/04. Therefore, there is low environmental risk attendant to the Phase One Property.



# 2.0 **INTRODUCTION**

Soil Engineers Ltd. has carried out a Phase One Environmental Site Assessment (ESA), as defined by the Environmental Protection Act (EPA), Ontario Regulation (O. Reg.) 153/04, as amended by O. Reg. 366/05, O. Reg. 66/08, O. Reg. 511/09, O. Reg. 245/10, O. Reg. 179/11, O. Reg. 269/11 and O. Reg. 333/13, hereinafter referred to as the "O. Reg. 153/04".

#### 2.1 Phase One Property Information

The Phase One Property, as shown in the Site Location Plan, Drawing No. 1, is located at the southeast corner of Burnhamthorpe Road West and Neyagawa Boulevard, with a municipal address of 382 Burnhamthorpe Road West, in the Town of Oakville. The Property Identification Number (PIN) of the Phase One Property is 0219, as shown on the Property Index Map (Block 24929), Drawing No. 2.

A copy of the Property Survey Plan (Plan 20R-17350) showing the Phase One Property, as signed by R. DenBroeder, Ontario Land Surveyor, and deposited at the Land Titles Division of Halton (No. 20) on August 9, 2007, is presented on Drawing No. 3.

The information of the Phase One Property obtained from the Parcel Register, land transfer documents, and the Municipal Property Assessment Corporation (MPAC) report are given in the following table:

Table 1 - Property Identification Number and Property Description

Property Identification Number (PIN)	24929-0219		
Property Description from the Parcel Register	PT LTS 19 & 20, CON 1 TRAF NDS, PT1 20R17350; OAKVILLE		
Tax Assessment Number from the Deed	2401010030026100000		
Municipal Address from the Deed	382 BURNHAMTHORPE ROAD WEST, TOWN OF OAKVILLE		



The Phase One Property is roughly rectangular in shape and encompasses an approximate area of 23.67 ha (58.49 ac). The UTM coordinates of the approximate centroid of the Phase One Property are 17T 600566 m E and 4814774 m N, as obtained from Google Earth which utilizes a 1983 North American Datum.

### Municipal Property Assessment Corporation

According to the MPAC Primary Structure Basic Report, included in Appendix 'A', the property code and description of the Phase One Property are "261-Land Owned By A Non-Farmer Improved With A Non-Farm Residence With A Portion Being Farmed". There are seven (7) structures on the Phase One Property as listed in Table 2:

**Table 2** - Structures on Phase One Property

Structure No.	Structure Code & Description	Year Built	Floor Area (sq ft)	Basement Area (sq ft)	Heating Type	Air Conditioning
1	301-Single Family Detached	1985	2967	1042	EL	N
2	301-Single Family Detached	1988	9181	5860	HW	Y
3	301-Single Family Detached	1985	400	∂₩	EL	N
4	266-Prefab, Metal (Straight)	1988	11400	XHI	18	N
5	204 -Type Iv Insulated Barn	1990	2646	(A)	A. <del>T.</del>	N
6	204 -Type Iv Insulated Barn	1985	2701	<b>(#</b>	-	N
7	299-Unspecified Farm Barn	1985	1936	76	-	N



#### 2.2 Contact Information

This Phase One ESA was commissioned to address any environmental concern as part of a due diligence in support of a proposed residential development associated with the Phase One Property, in accordance with our proposal dated February 6, 2014, and approved on February 7, 2014 by Mr. Sang Kim of Trinison Management Corporation.

The information of our client and owner is provided below:

Sherborne Lodge Developments Limited c/o Trinison Management Corp. 8600 Dufferin Street Vaughan, Ontario L4K 5P5

Attention: Mr. Sang Kim



#### 3.0 **SCOPE OF INVESTIGATION**

The general objectives of a Phase One ESA, as defined by Part VII of O. Reg. 153/04 of the EPA, are as follows:

- To develop a preliminary determination of the likelihood that one or more contaminants have affected any land or water on, in or under the Phase One Property.
- To determine the need for a Phase Two ESA.
- To provide a basis for carrying out any Phase Two ESA.
- To provide adequate preliminary information about the environmental conditions in the land or water on, in or under the Phase One Property to conduct a risk assessment following the completion of a Phase Two ESA.

A Phase One ESA generally consists of the following components:

- A review of records.
- Interviews.
- Site reconnaissance.
- An evaluation of the information gathered from the review of records, interviews and site reconnaissance.
- Completion of a Phase One ESA report.
- The submission of the Phase One ESA report to the commissioner of the Phase One Property.

A residential development is being proposed for the Phase One Property. It is anticipated that the new development will be provided with municipal services meeting the urban standards.



#### 4.0 **REVIEW OF RECORDS**

#### 4.1 General

#### (i) Phase One Study Area

Except where noted, the Phase One Study Area generally consists of the Phase One Property plus properties that are located, wholly or partially, within 250 metres beyond the perimeter boundaries of the Phase One Property.

#### (ii) First Developed Use

The first developed use of the Phase One Property is defined by O. Reg. 153/04 as the earlier of either the first use in or after 1875 that resulted in the development of a building or a structure on the Phase One Property, or the first potentially contaminating use or activity on the Phase One Property.

A Historical Map drafted in 1877 was obtained on February 20, 2014, from the University of McGill's Digital Map Library. A copy of the Historical Map is presented as Drawing No. 4, showing that the Phase One Property was part of the estate owned by George Bowbeer at that time. Based on the Historical Map, no structure was located at the Phase One Property. Given the size and shape of the estate, the first developed use of the Phase One Property appears to be farmland. Neighbouring properties within the Phase One Study Area in all directions appear to be used for agricultural purposes while orchards are noted to the northwest and northeast of the Phase One Property. A roadway is also noted adjacent to the north of the Phase One Property.



#### (iii) Fire Insurance Plans

During the years researched, the Phase One Property has mainly been used for agricultural purposes. Plans and Fire Insurance Maps were last published by CGI Information Systems and Management Consultants Inc. in the mid-1970s. A representative from Soil Engineers Ltd. searched for Fire Insurance Plan (FIP) at the Toronto Reference Library on February 11, 2014, no FIP was available for the Phase One Property.

#### (iv) Chain of Title

A land title search was conducted for the Phase One Property at the Region of Halton Land Registry Office (20) on February 11, 2014.

The information from the Parcel Register and Land Title research for the Phase One Property is listed in Appendix 'B'. The earliest records show that the Phase One Property was part of estate known as Lots 19 and 20, Concession 1, North of Dundus Street, in the Town of Trafalgar, County of Halton, patented to Charles Biggar and Daniel Clark by the Crown in 1808 and 1810, respectively. Then the lot was granted to Charles Biggar and wife in 1817, and was subsequently transferred to James L. Biggar in 1845.

Throughout the years, the lots were subdivided and the ownerships of the properties changed several times between private individuals and businesses. The latest transactions for the Phase One Property occurred in 1998, when Firestone, David Morgan Firestone and Bente Firestone transferred the Phase One Property to Sherborne Lodge Developments Limited, the current registered owner.



# (v) Review of Previous Environmental Reports

Soil Engineer Ltd. is not aware that there is any previous environmental investigation attendant to the Phase One Property.

#### 4.2 Environmental Source Information

# (i) Ministry of the Environment

#### Waste Disposal Sites

Active and closed landfill sites located in excess of 1 km from the Phase One Property are considered to have no significant potential environmental impact on the Phase One Property. On February 27, 2014, Soil Engineers Ltd. reviewed the Ontario Ministry of the Environment's (MOE) "Waste Disposal Site Inventory", dated June 1991. No active or closed waste disposal site is registered at the Phase One Property. However, three (3) waste disposal site records (actually on the same property) are registered within 1 km of the Phase One Property, but none of them is within the Phase One Study Area.

#### Industrial Sites Producing or Using Coal Tar and Related Tars in Ontario

On February 27, 2014, Soil Engineers Ltd. reviewed the MOE "Inventory of Industrial Sites Producing or Using Coal Tar and Related Tars in Ontario", dated November 1988, and the "Inventory of Coal Gasification Plant Waste Sites in Ontario", dated April 1987. There was no record of any coal gasification plant, coal distillation plant, or creosote plant on or within the vicinity of the Phase One Property. Facilities of this nature are located in excess of 1 km from the Phase One Property and are considered to have no significant potential environmental impact on the Phase One Property.



#### PCB Waste Storage Sites

The MOE "Ontario Inventory of PCB Storage Sites", dated 2000, was reviewed on February 27, 2014. The Phase One Property is not registered as a PCB waste storage site, and no PCB waste storage site is located at neighbouring properties within the Phase One Study Area.

#### MOE Waste Generator

On February 27, 2014, the MOE Waste Generator Registration database files, dated 2000, 2008 and 2013, were reviewed. The Phase One Property is not registered as waste generator under Regulation 558 of the EPA, and no MOE waste generator is located at neighbouring properties within the Phase One Study Area.

#### Record of Site Condition

On February 27, 2014, the MOE public Brownfields Environmental Site Registry was reviewed for Records of Site Condition (RSC) filed for the properties within the Phase One Study Area. One (1) RSC has been filed for the Phase One Property, as in the table below. No RSC record was filed for neighbouring properties within the Phase One Study Area.

Table 3 - Record of Site Condition

Registration		Distance from Phase	
Number	Name of Submitting Owner	One Property	Filing Date
50311	Sherborne Lodge Developments Limited	On-site	April 15, 2009



#### MOE Freedom of Information

A request for documented environmental concerns and citations pertaining to the Phase One Property was forwarded to the MOE Freedom of Information (FOI) Office on February 27, 2014. A response was received dated March 27, 2014, as in Appendix 'C', the MOE indicated that no record was identified for the Phase One Property.

#### (ii) Environment Canada

#### National Pollutant Release Inventory

On February 27, 2014, the Environment Canada National Pollutant Release Inventory (NPRI) database files were reviewed. Neither the Phase One Property nor any other property within the Phase One Study Area has been registered with the NPRI database.

# National PCB Inventory

On February 27, 2014, the National PCB Inventory (NPCB) database regarding the Phase One Property was reviewed. Neither the Phase One Property nor any other property within the Phase One Study Area has been registered with the NPCB database.

#### (iii) Other Sources

#### Municipal Freedom of Information

A request for documented environmental concerns and citations pertaining to the Phase One Property was forwarded to the Business Services Office, Planning and Infrastructure Services, Town of Oakville on February 27, 2104. No response has been received at the time of writing this report. In the event that their response suggests cause for concern pertaining to the Phase One Property, it will be forwarded together with an assessment of its significance.



#### Technical Standards & Safety Authority

The use of underground storage tanks (USTs) containing petroleum products is regulated in Ontario by the Ministry of Consumer and Commercial Relations (MCCR) under various legislative instruments, including the Gasoline Handling Act and Energy Act. Above-ground storage tanks (ASTs) and USTs that contain petroleum products are required by law to be registered with the MCCR, and the Technical Standards & Safety Authority (TSSA) is responsible for keeping a record of these tanks. Customer Services of the TSSA was contacted on February 26, 2014 regarding possible registration, size and age of USTs on the Phase One Property. They informed us that no UST was registered for the Phase One Property. It should be noted that reliable TSSA records are only available from 1987 to the present.

#### EcoLog Environmental Risk Information Services Ltd.

EcoLog Environmental Risk Information Services (ERIS) Ltd. provides reports that compile information from both government and private databases of interest to the environmental field. The EcoLog ERIS Report (Order No. 20140214020) for the Phase One Property and Phase One Study Area, dated February 24, 2014, is presented in Appendix 'D'.

There are one (1) record for the Phase One Property, and nine (9) additional records for neighbouring properties within the Phase One Study Area identified in the EcoLog ERIS Report. The database and number of records found pertaining to the Phase One Property and neighbouring properties within the Phase One Study Area are listed in the table below.

**Table 4** - Records in EcoLog ERIS Report

Database	Number of Records for Phase One Property	Number of Additional Records for Phase One Study Area	
Certificates of Approval	0	1	
ERIS Historical Searches	0	4	
Record of Site Condition	1	0	
Water Well Information System	0	4	
Total	1	9	



Brief discussions of the records identified from the EcoLog ERIS Report, which may pose potential environmental impact to the Phase One Property, are presented in the following sections.

#### (a) Certificates of Approval (CA)

This provincial database contains records of approvals granted for the release of emissions to the atmosphere, discharge of contaminants to ground or surface water, to provide potable water supplies, or to store, transport or dispose of waste. One (1) CA was issued for neighbouring properties for municipal and private sewage works within the Phase One Study Area, but no record was issued for the Phase One Property.

#### (b) Record of Site Condition

Record of Site Condition is part of Ministry of the Environment's Brownfields
Environmental Site Registry. In order to file an RSC, the property must have been
properly assessed and shown to meet the soil, sediment and groundwater standards
appropriate for the proposed property use. Based on the record, there is one (1) RSC filed
for the Phase One Property, which registered the intended property use as residential.

#### (c) Water Well Information System

The Water Well Information System (WWIS) is a database containing records on the location and characteristics of water wells in Ontario in accordance with O. Reg. 903, between 1955 and 2013. Based on the EcoLog ERIS Report, no water well record is located at the Phase One Property. However, four (4) water well records are located at the properties within the Phase One Study Area. A review of the well logs in the WWIS indicates that the soil type in the area is primarily clay, gravel, boulder and bedrock. Based on the well records, the deepest well extends to a depth of approximately 16.8 mbgs, and the depth of bedrock encountered at approximately 10.4 mbgs in one water well record.



#### 4.3 Physical Setting Sources

#### (i) Aerial Photographs

Aerial photographs, dated from 1954, 1964, 1985, 1994, 1999, 2005 and 2012 showing the Phase One Property and its surrounding areas were obtained from the University of Toronto Map and Data Library, Soil Engineers Ltd. reference library, National Air Photo Library and the Oakville Interactive Map website on February 20, 2014. A review of the 1954, 1964 and 1985 aerial photographs indicate the Phase One Property was used for agricultural purposes with a wooded area occupied the southern portion of the Phase One Property. Neighbouring properties within the Phase One Study Area are mostly used for agricultural purposes in all directions, with the wooded area extends further south and southwest from the Phase One Property. A rural residential land is noted to the northeast. No structure was identified at the Phase One Property on these aerial photographs.

Buildings/structures are noted on the 1994 ad 1999 aerial photographs and a man-made pond, with a creek feeding into it from the east, is observed at the mid-southern portion of the Phase One Property on both aerial photographs. No significant change is noted to neighbouring properties within the Phase One Study Area with the exception of Neyagawa Boulevard is located at the northwest corner of the Phase One Property, and a creek at the east is connected to the man-made pond in the 1999 aerial photograph.

The 2005 and 2012 aerial photographs indicate no change at the Phase One Property and the Phase One Study Area with the exception of an institutional development is noted at the northwest within the Phase One Study Area.

The Phase One Property is adjacent to Burnhamthorpe Road West in all reviewed aerial photographs, while Neyagawa Boulevard is noted on the aerial photographs from 1999 onwards.



Copies of the aerial photographs are presented in Appendix 'E'. These aerial photographs depict the chronology of the development at the Phase One Property and the Phase One Study Area at those times.

#### (ii) Topography, Hydrology and Geology

Maps of the Phase One Property were obtained from the Halton Region Land Registry Office, Soil Engineers Ltd. reference library, the Ontario Ministry of Natural Resources (MNR), the Toporama website, the Agricultural Agri-Food Canada website, Oakville Interactive Map website, and Conservation Halton Watersheds Map on February 20, 2014. The 1982 Ontario Base Map, 2004 Topographic Map, 2008 Geological Map, 2011 Hydrogeological Map and 2006 Watershed Map are available, showing the land features at those times. Copies of these maps are presented on Drawing Nos. 5 to 9, respectively. A chronological review of the maps indicates land features at the Phase One Property are consistent with those shown on the aerial photographs.

The 1982 Ontario Base Map, as presented on Drawing No. 5, indicates that no building/structure was present at the Phase One Property. Roadways are noted to the west and adjacent to the north of the Phase One Property. A wooded area is observed at the southern portion of the Phase One Property and extends further south and southwest.

A review of the 2004 Topographic Map, as presented on Drawing No. 6, indicates that the general topography of the Phase One Study Area descends to the southeast. Based on the local topography of the area, precipitation runoff and groundwater flow is expected to flow southeasterly. Roadways are noted adjacent to the north and northwest of the Phase One Property (i.e., Burnhamthorpe Road West to the north and Neyagawa Boulevard to the northwest). Wooded area is noted at the southern portion of the Phase One Property and extends further south and southwest.



A geological map of the Phase One Property area was obtained from the Agricultural Agri-Food Canada website on February 20, 2014, as presented on Drawing No. 7. A review of the geological map indicates that the Phase One Property is predominantly underlain by Lockport/Haldimand Grey-Brown Podzolic Clay which is dominantly very fine textured soils formed on till or lacustrine sediments.

Based on information acquired through the Bedrock Cross Section Viewer (Ontario Geological Survey, 2010) on February 28, 2014, the bedrock elevation at the Phase One Property is approximately 167 metres above sea level (masl), and the drift thickness is approximately 6.0 m.

The Phase One Property is located in the larger hydrogeological region known as the Southern Ontario Lowlands, as shown on Drawing No. 8. A watershed map of the area was located at the Halton Region Conservation Authority website and Ministry of Natural Resources database on February 20, 2014, and a copy of the watershed map is presented in Drawing No. 9. The watershed map indicates the Phase One Property is situated within the Sixteen Mile Creek Watershed, and the groundwater is expected to flow southeasterly towards Lake Ontario.

# (iii) Fill Material and Topsoil

The reviewed records do not indicate any fill material being brought onto the Phase One Property.



#### (iv) Water Bodies and Areas of Natural Significance

#### Ministry of Natural Resources

On February 27, 2014, Soil Engineers Ltd. reviewed the Town of Oakville Interactive Map and the Ontario Ministry of Natural Resources Heritage Information Centre (HNIC) database, for listings of the various classes of natural areas located at the vicinity of the Phase One Property. It is determined that there is an Area of Natural and Scientific Interest (ANSI) with wetlands at the southern portion of the Phase One Property and extends further south and southwest. A small creek at east is connected to the man-made pond at the Phase One Property. However, no Environmentally Sensitive Area is identified at the Phase One Property or neighbouring properties within the Phase One Study Area. An Environmental Map is presented on Drawing No. 10.

#### Planning Authorities/Wellhead Protection Areas

The Province of Ontario passed the Clean Water Act in 2006. Hamilton/Halton Conservation Authority is the regional authority protecting sources of drinking water in the area of the Phase One Property. Based on the review of a map of the Municipal Wellhead Protection Zones (WHPZ), the Phase One Property is not located within a WHPZ. In addition, there is no WHPZ at neighbouring properties within the Phase One Study Area.

#### (v) Well Records

The MOE Help Desk at Water Well Ontario was contacted on February 27, 2014 regarding the Phase One Property and the surrounding areas within a 630 m radius from the approximate centroid of the Phase One Property (searched area). The MOE Well Records indicate that there are seven (7) water well records located within the searched area. A review of the water well records indicates that no water well record is located at the Phase One Property.



The difference between the EcoLog ERIS Report and the MOE Well Records are due to the different searching distance/radius of the two reports, i.e., the EcoLog ERIS Report defined the searching distance of 250 m from the boundaries of the Phase One property, while the MOE Well Records defined the searching radius of 630 m from the approximate centroid of the Phase One Property. However, after a careful review of both water well records, the MOE Well Records cover three (3) water well records as identified in the EcoLog ERIS Report with the exception of the abandoned well. Details regarding the water well records are provided in the MOE Well Records, Appendix 'F'.

# 4.4 Occupancy Search

An occupancy search for the Phase One Property and the Phase One Study Area was conducted on February 11, 2014 using the 1976, 1981, 1985, 1991 and 2001 city directories at the Toronto Reference Library. The Phase One Property was occupied by 4 Comm Integrated Technologies Inc. and All Care Landscape from 2001. None of neighbouring properties within the Phase One Study Area was listed in the city directories. The occupancy records are listed in Appendix 'G'.

#### 4.5 Summary of Records Review

A summary of the relevant information disclosed by our review of records, as of March 3, 2014, is given below:

- The Phase One Property was used for agricultural purposes until mid-1980s, and it then has been mainly used for green pastures, horse breeding and riding training, recreational and residential purposes for recent decades. (Sources: Aerial Photographs and Maps).
- Several environmental records such as Certificates of Approval (CA) and Water Well
  Information System (WWIS) are located at the Phase One Property and neighbouring
  properties within the Phase One Study Area (Source: EcoLog ERIS Report).



- Four (4) water well records are located within the Phase One Study Area, but none of them is located at the Phase One Property (Sources: EcoLog ERIS Report and MOE Well Records).
- A man-made pond, with a creek feeding into it from the east, is noted at the mid-southern portion of the Phase One Property (Sources: Aerial photographs and Maps).
- The Phase One Property is adjacent to roadways, i.e., Burnhamthorpe Road West to the north and Neyagawa Boulevard to the northwest (Sources: Aerial Photographs and Maps).
- There is an ANSI with wetlands at the Phase One Property and neighbouring properties to south and southwest within the Phase One Study Area. No Environmentally Sensitive Area is identified at the Phase One Property or within the Phase One Study Area (Sources: Maps and MNR).



#### 5.0 **INTERVIEWS**

#### Questionnaire Interview

On February 18, 2014, Soil Engineers Ltd. provided Mr. Sang Kim of Trinison Management Corp. Ltd. and Mr. Alexander Drung, a representative of the owner with a questionnaire. The questionnaire addresses general inquiries regarding the Phase One Property. Mr. Alexander Drung completed the questionnaire on March 3, 2014, and the copy of the completed questionnaire is included in Appendix 'H'.

#### Telephone Interview

On February 18, 2014, a receptionist of Havencrest Riding Academy, the tenant of the Phase One Property, was interviewed by telephone call regarding the aboveground storage tank on the Phase One Property. .

# 5.1 **Summary of Interviews**

The interviews have revealed the following items which warrant further consideration:

- An aboveground diesel storage tank for horse stable and two (2) propane tanks for residential houses are located on the Phase One Property.
- Two (2) septic tanks are located at the Phase One Property.

No other note-worthy environmental concern was identified from interviews.



6.0

#### SITE RECONNAISSANCE

#### 6.1 General

A visual inspection of the readily accessible areas of the subject site was conducted by Mr. Kelvin Lee, B.Eng., Mr. Nolan McGahey, B.Sc., Dip. Env. Tech, and Mr. Wilson Jiang, Ph.D. on February 12, 19 and April 14, 2014 (after snow melted completely), to determine the general environmental condition of the Phase One Study Area. The following table outlines the condition and timing of the site reconnaissance:

**Table 5** - Site Reconnaissance Conditions

Date	Weather Condition	Temperature	Duration of Visit	Precipitation Conditions
February 12, 2014	Overcast	-12° C	1.5 Hours 10:15 am-12:40 pm	No precipitation
February 19, 2014	Overcast	-18° C	1.0 Hour 3:00 pm-4:30 pm	No precipitation
April 14, 2014	Light rain	8° C	0.5 Hours 2:30 pm-3:00 pm	Precipitation

Site photographs taken during the site reconnaissance are presented in Appendix 'I'.

At the time of site inspection, structures are noted at the mid-eastern portion of the Phase One Property, which included two (2) residential houses, a multi-purpose building (consisting of an arena, an "L" shape stable, an office and a garage), a horse training court and a tennis court. The multi-purpose building is at the northern portion of the built-up compound. The first residential house is a two-storey complex building and is located at the extreme south of the built-up compound (Residence A). The second residential house is a two-storey detached house and located to the immediate southeast of the built-up compound (Residence B). The tennis court is located between the Residence A and the Residence B. During the site inspection, the built-up compound is mainly surrounded by vacant fields in all direction, while a man-made pond is noted south of the built-up compound. There is no snow on the Phase One property at the third site reconnaissance.



The ground surface is undulating, and the grade of the Phase One Property generally descends towards the southeast. There was no visible sign of any underground storage tank at the Phase One Property, but an above-ground storage tank is observed at the north of the built-up compound. In addition, there is no noticeable nuisance odour or detectable source of air emissions at the Phase One Property during the site inspection. There is no evidence to suggest that materials of environmental concern are used, stored or disposed on the Phase One Property.

Burnhanthrope Road West and Neyagawa Boulevard are adjacent to the north and northwest of the Phase One Property, respectively. Neighbouring properties consist mainly of agricultural lands in all directions with the exception of an ANSI area at the south, and an institutional development at the northwest across the Neyagawa Boulevard.

# 6.2 **Specific Observations at Phase One Property**

# (i) Building Inspection

The on-site structures, consist mainly of Residence A, Residence B and a multipurpose building, are inspected during the site reconnaissance.

# Residence A (a complex building)

The Residence A is a two-storey residential complex building, occupying the extreme southern portion of the built-up compound. According to the MPAC report, this complex building was built in 1988. The exterior of Residence A is constructed with bricks, vinyl siding, and modern stucco. The interior comprises of dry walls, hardwood, ceramic tiles, marble and carpet flooring. The basement is partly finished. This complex building is furnished with several bedrooms, living rooms, an office, a kitchen and bathrooms. An indoor swimming pool is located in the walkout basement. A horse training court is noted to the west of this complex building.



# Residence B (a detached house)

The Residence B is a two-storey detached residential house and located to the immediate southeast of the built-up compound. According to the MPAC report, this detached house was built in 1985. The exterior of Residence B is constructed with bricks, wooden panels, with an asphaltic roof. The interior comprises of dry walls, ceramic tiles, and carpet flooring. The basement is partly finished. This residential house consists of three bedrooms, a living room, a kitchen, an office and two bathrooms. A tennis court is located south of Residence B.

# Multi-purpose Building

The single-storey multi-purpose building occupies the northern portion of the built-up compound. The multi-purpose building consists mainly of an arena, an "L" shape stable, an office and a garage from west to east. All these structures are connected together. An attic is noted at the mid-northern portion of the building and on top of the "L" shape corner of the stable. Currently the attic appears to be used for storage purposes. The exterior of the multi-purpose building is constructed with bricks, vinyl siding, and modern stucco. The interior comprises of concrete bricks, and wooded panel. According to the MPAC report, this multi-purpose building was built in the late 1980s.

#### (ii) Hazardous Materials

# Asbestos-Containing Materials (ACMs)

Asbestos-containing materials (ACMs) were widely used in building construction until the mid- to late 1970s, primarily for the good insulation and fire retardant properties of asbestos. The health risks associated with asbestos occur when asbestos fibres are released from various materials into the ambient air.



Based on the age of the buildings, it is unlikely that ACMs may have been used in the construction of the built-up compound.

# Polychlorinated Biphenyls (PCBs)

PCBs commonly exist in electrical equipment such as transformers, capacitors, and in the ballasts of fluorescent and high-intensity discharge (HID) light fixtures. The use of PCBs in newly manufactured electrical equipment was discontinued in 1979.

Based on the age of the built-up compound, it is unlikely that PCBs are present in the electrical equipment present on the Phase One Property.

## <u>Urea-Formaldehyde Foam Insulation (UFFI)</u>

Urea-formaldehyde foam insulation (UFFI) was commonly used in the mid-1970s for insulation in buildings and was discontinued in 1980.

Based on the age of the built-up compound, it is unlikely that UFFI may have been used. However, no UFFI was observed at accessible locations within the compound.

# Ozone-Depleting Substances (ODSs)

ODSs are found in the form of chlorofluorocarbons (CFCs) used in air-conditioning units and refrigeration systems.

Based on our inspection, sources of ODSs are likely limited to minor quantities present in the refrigeration/freezer units and do not pose an environmental risk if the units are properly serviced and maintained. The refrigeration/freezer units appeared to be in good condition, and no leakage was noticed at the time of the site reconnaissance.



#### Lead

Lead was commonly used in plumbing pipes and solder, and in the manufacture of paint as a drying agent and for pigmentation. The use of lead had been reduced, and was phased out of use in plumbing solder during the 1980s and from pipes during the 1990s. The use of lead in the manufacture of new paint was phased out during the 1970s for interior house paint and during the late 1990s for exterior paint.

Painted surfaces were observed throughout the built-up compound. Based on the age of the compound, it is possible that lead-based materials may be used in various components of the built-up compound.

#### Mercury

Mercury is generally a component of thermometers, thermostats and fluorescent lighting tubes. Our visual inspection of the Phase One Property indicated that these items were in use. Provided that these items are left intact, they remain safe in their present form.

#### Silica

Silica is a natural material found in rocks and masonry units. Our inspection of the exterior of the residential structure indicates that these materials were used in the construction. As long as these materials remain in their solid form and do not show signs of deterioration (or dusting), they remain safe.

# (iii) Underground Storage Tanks (UST)

There is no vent or filler pipe visible to indicate the presence of any UST on the Phase One Property.



# (iv) Above-Ground Storage Tanks (AST)

One (1) diesel AST is located north of the multi-purpose building. The tank appears to be in good condition with no crack or hole. The second containment is not observed around the AST. However, the AST is on a concrete pad and in a good condition with no sign of corrosion. During the third site reconnaissance, there is no sign of fuel leakage/spillage or stained soil identified around and/or under the AST.

#### (v) Substance Containers

Our representative checked for the presence of substance containers such as oil drums, used oil containers, gasoline jerry cans, paint cans, etc. At the time of our inspection, several cleaning supply and animal supplement containers are observed within the built-up compound.

# (vi) Waste Management and Maintenance Practices

Domestic waste in the form of general mixed and recyclable refuse is disposed off the Phase One Property by the Municipal Waste Management Services.

In addition, waste generated from the stable is collected in a steel bin and is disposed off site periodically by a licensed contractor (Triwaste Service).



# (vii) Air Quality and Noise

During our inspection, there is no offensive odour or detectable source of air emissions that may impact the ambient air quality at the Phase One Property.

Ambient noise refers to the noise of traffic along Burnhamthrope Road West and Neyagawa Boulevard adjacent to the north and northwest of the Phase One Property, respectively.

# (viii) Water Wells and Septic System

Our representative did not observe any water well at the Phase One Property during the site reconnaissance. However, septic tanks are observed at the backyard of Residence B.

# (ix) Phase One Study Area Inspection

Based on our visual inspection of the publicly accessible areas, neighbouring properties consist of agricultural properties in all directions with the exception of an ANSI area at the south of the Phase One Property, and an institutional development at the northwest across the Neyagawa Boulevard.

No unexpected noise or odour level was noted emanating from these properties during our site reconnaissance.



# (x) Enhanced Property Investigation

The Phase One Property was used for agricultural purposes until mid-1980s, and it then has been mainly used for green pastures, horse breeding and training, recreational and residential purposes for recent decades. The activities undertaken at the Phase One Property do not justify an Enhanced Property Investigation. Therefore, no enhanced property investigation was conducted.

# (xi) Written Description of Investigation

The site reconnaissance includes a walk-through inspection of the Phase One Property and neighbouring properties within the Phase One Study Area on February 12, 19 and April 14, 2014. Written and photographic records regarding the condition of the Phase One Property were compiled.

There is no evidence to suggest that the activities conducted at the Phase One Property will result in any adverse environmental impact on the Phase One Property.

# 6.3 <u>Summary of Site Reconnaissance</u>

Our site reconnaissance conducted on April 14, 2014, has revealed the following items which warrant further discussion:

- One (1) diesel AST is located north of the built-up compound.
- A man-made pond is noted at the mid-southern portion of the Phase One Property.
- Designated substances may have been used for the building components at the Phase One Property.
- Septic tanks are observed at the backyard of Residence B.
- The Phase One Property is adjacent to roadways (i.e. Burnhamthrope Road West and Neyagawa Boulevard).



# 7.0 **REVIEW AND EVALUATION OF INFORMATION**

#### 7.1 Current and Past Uses

The review of records indicates that the Phase One Property was used for agricultural purposes until mid-1980s, and it then has been mainly used for green pastures, horse breeding and riding training, recreational and residential purposes for recent decades. A built-up compound is noted at the Phase One Property during the site reconnaissance. Neighbouring properties consist mainly of agricultural lands in all directions with the exception of an ANSI area at the south of the Phase One Property, and an institutional development at the northwest across the Neyagawa Boulevard.

A description of the owners and the corresponding uses of the Phase One Property and the years in which they appear to have commenced are presented in Appendix 'J'.

# 7.2 <u>Discussion of Environmental Items</u>

Based on our review of records, interviews and site reconnaissance, as of April 14, 2014, the following information pertaining to the environmental condition of the Phase One Property have been disclosed by the Phase One ESA:

The Phase One Property was used for agricultural purposes until mid-1980s, and it then
has been mainly used for green pastures, horse breeding and riding training, recreational
and residential purposes for recent decades. (Sources: Aerial Photographs, Maps and
Interviews).



- Several environmental records such as Certificates of Approval (CA) and Water Well Information System (WWIS) are located at the Phase One Property and neighbouring properties within the Phase One Study Area (Source: EcoLog ERIS Report).
- An aboveground diesel storage tank for horse stable is located on the Phase One Property (Sources: Interviews and Site Reconnaissance).
- Two (2) septic tanks are located at the Phase One Property (Sources: Interview and Site Reconnaissance).
- Designated substances may have been used for the building components at the Phase One Property (Source: Site Reconnaissance).
- Four (4) water well records are located within the Phase One Study Area but none of them is located at the Phase One Property (Sources: EcoLog ERIS Report and MOE Well Records).
- A man-made pond, with a creek feeding into it from the east, is noted at the mid-southern portion of the Phase One Property (Sources: Aerial photographs and Maps).
- The Phase One Property is adjacent to roadways, i.e., Burnhamthorpe Road West to the north and Neyagawa Boulevard to the northwest (Sources: Aerial Photographs, Maps and Site Reconnaissance).
- There is an ANSI with wetlands at the Phase One Property and neighbouring properties to south and southwest within the Phase One Study Area. No Environmentally Sensitive Area is identified at the Phase One Property or within the Phase One Study Area (Sources: Maps and MNR).

# (i) Potentially Contaminating Activity Classification

We have evaluated the risk associated with each of the specific items in the above list to determine whether the activity should be classified as a Potentially Contaminating Activity (PCA) or if there is a low potential for the activity to impact on the environmental condition of the Phase One Property. The assessments are presented below:



#### Green Pastures and Former Agricultural Land

The Phase One Property was used for agricultural purposes until mid-1980s, and it then has been mainly used for green pastures, horse breeding and training, recreational and residential purposes for recent decades. As the agricultural activities had ceased for several decades, pesticides that might have been used in association with these agricultural activities would have been dissipated. Therefore, the historical usage of pesticides is not considered a PCA in this report.

#### **Environmental Source Record**

Several environmental records such as Certificates of Approval (CA) and Water Well Information System (WWIS) are located at the Phase One Property and neighbouring properties within the Phase One Study Area.

After carefully review of the records from ERIS Database Report and Maps, it is determined that none of the environmental records can pose any environmental concern on the Phase One Property. As such, they are not considered as PCAs for the purpose of this report.

#### Aboveground Storage Tank

Based on our site reconnaissance, an AST is located on the Phase One Property, which was used for storage of diesel for horse stable. Generally, AST is noted due to the potential contamination that can occur in case of a leakage or a spillage of the substance. It should be noted that the AST is on a concrete pad and in a good condition with no sign of corrosion. During the third site reconnaissance, there is no sign of fuel leakage/ spillage or stained soil identified around and/or under the AST. Therefore, this is not considered as a PCA in this report.



#### (ii) Other Environmental Items

#### Adjacent Roadways

Based on a review of records and site reconnaissance, the Phase One Property is adjacent to roadways. These items are generally considered as an environmental concern due to the potential presence of parameters such as Sodium Adsorption Ratio (SAR) and Electrical Conductivity (EC) commonly found in de-icing chemicals used during the winter season. Therefore, unusually high levels of SAR and EC are anticipated in the soil at properties adjacent to a roadway. If the soil remains in situ, it is considered to meet the applicable standards through clause 48(3) of O. Reg. 153/04. Therefore, it will not constitute as a PCA. However, should the material be displaced, it will no longer qualify for this exemption and must be managed accordingly.

# Water Body, ANSI and Environmentally Sensitive Area

Based on the review of records, an ANSI with wetlands is located within the southern portion of the Phase One Property, and extends further south and southwest within the Phase One Study Area. In addition, a small creek at east is connected to the man-made pond at the Phase One Property. ANSI and water body are noted due to possible development restrictions imposed on the neighbouring lands along the ANSI and water body. However, these are not considered as PCAs for the purpose of this report.

Based on the Town of Oakville Interactive Map and the Ministry of Natural Resource Natural Feature Map for listings of the various classes of natural areas located within the vicinity of the Phase One Property, there is no Environmentally Sensitive Area at the Phase One Property or neighbouring properties within the Phase One Study Area.



### Septic System

Septic system found and not in use at the Phase One Property must be properly decommissioned. A copy of the work orders should be retained for future reference. This is not considered as a PCA.

### **Designated Substances**

It should be noted that suspected hazardous materials may be contained within the on-site built-up compound. Since this compound is not part of the development plan, the designated substances will normally be dealt with by the builders or constructors, prior to any demolition of the structures, through the Occupational Health and Safety Act.

# 7.3 Areas of Potential Environmental Concern

No PCA has been classified and, therefore, no area of potential environmental concern (APEC) is identified at the Phase One Property at this time.

# 7.4 Phase One Conceptual Site Plan

A Phase One Conceptual Site Plan, illustrating the location of the Phase One Property, the Phase One Study Area, the assumed groundwater flow direction, and neighbouring property uses, is presented on Drawing No. 11.



## 8.0 **CONCLUSION**

Soil Engineers Ltd. was retained by Sherborne Lodge Developments Limited, c/o Trinison Management Corporation, to carry out a Phase One Environmental Site Assessment (ESA) for a property located at the southeast corner of Burnhamthorpe Road West and Neygawa Boulevard, in the Town of Oakville, as part of a due diligence in support of a proposed residential development.

Throughout the years, the Phase One Property was used for agricultural purposes until mid-1980s, and it then has been mainly used for green pastures, horse breeding and riding training, recreational and residential purposes for recent decades. A built-up compound is noted at the Phase One Property during the site reconnaissance. Neighbouring properties consist mainly of agricultural lands in all directions with the exception of an ANSI area at the south, and an institutional development at the northwest across the Neyagawa Boulevard.

# 8.1 Phase Two ESA Recommendation

Since there is no PCA identified at the Phase One Property and Phase One Study Area, no further environmental investigation is recommended at this time.

# 8.2 **RSC Requirements**

Given the type of development proposed for the Phase One Property, an RSC may not be required to be filed in accordance with O. Reg. 153/04. However, local and regional governments may require an RSC as part of the development approval process.

Please note that if there is an intention to file an RSC in accordance with O. Reg. 153/04, the most current activity conducted in the Phase One ESA must be within 18 months of the date of filing.



## 8.3 Body of Water, Environmentally Sensitive Area, ANSI

I. S. CHIU

It should be noted that no environmentally sensitive area has been identified within the Phase One Property. However, an ANSI with wetlands is located within the southern portion of the Phase One Property, and extends further south and southwest within the Phase One Study Area. A man-made pond, with a creek feeding into it from the east, is also noted at the mid-southern portion of the Phase One Property. ANSI and water body are noted due to possible development restrictions imposed on the neighbouring lands at the vicinity of these features.

### 8.4 <u>Legal Requirements</u>

If an RSC has been submitted and filed for the Phase One Property, the property owner must retain a copy of this report for at least 7 years in accordance with O. Reg. 153/04, Section 18.

SOIL ENGINEERS LTD.

Wilson Jiang, Ph.D.

Ian Chiu, P.Eng., QPE

WJ/IC



#### 9.0 **REFERENCES**

#### Information in the Public Domain

Environment Canada. National PCB Inventory (1994)

Environment Canada. National Pollutant Release Inventory (1993-2011).

Environmental Protection Act (EPA). Part VII of Ontario Regulation 153/04. The Ontario Ministry of the Environment (MOE) (Amended 2009).

MOE. Brownfields Environmental Site Registry (2013)

MOE. Inventory of Coal Gasification Plant Waste Sites in Ontario (April 1987).

MOE. Inventory of Industrial Sites Producing or Using Coal Tar and Related Tars in Ontario (November 1988)

MOE. Ontario Inventory of PCB Storage Sites (2000)

MOE. Waste Disposal Site Inventory (June 1991).

MOE. Waste Generator Registration Database Files (2000, 2008, 2013)

Ontario Ministry of Natural Resources (MNR). MNR Natural Heritage Information Centre (NHIC) (2013).

Service Ontario, Land Registry Office 20. Historical Land Titles Search (1808 - 2014).

Service Ontario, Land Registry Office 20. Land Transfers

Service Ontario, Land Registry Office 20. Parcel Registry for Property Identifier Number 24929. Land Titles Act (2008).

Hamilton and Halton Conservation Authority (2014)

Water Well Help Desk, Environmental Monitoring and Reporting Branch, Ministry of Environment. The MOE Well Records (2014).



#### **Information from Commercial Databases**

EcoLog ERIS Report, Order Number 20140214020, detailing over 50 public and private databases (2014)

#### References of Plans and Drawings

Agricultural Agri-Food Canada Website, 2008 Soil Research Institute

Town of Oakville Inactive Mapping Website (2014)

Department of Energy, Mines and Resources, Her Majesty The Queen in Right of Canada

Her Majesty the Queen in Right of Canada. Ontario Base Maps (1982)

Hydrogeoloical Map obtained from Ministry of Natural Resource. Her Majesty the Queen in Right of Canada (2011)

McGill University Digital Map Library, 1877 Illustrated Historical Atlas of Township of Trafalgar.

Ministry of Natural Resources Canada, Her Majesty the Queen in Right of Canada 2011

Property Index Map (Block 24929), 2014 Ministry of Government Services.

Soil Engineers Ltd. reference library. 1982 Her Majesty the Queen in Right of Canada.

The Atlas of Canada-Toporama, 2013 Natural Resources Canada.

Halton Watershed Maps. Obtained from the Hamilton and Halton Conservation Authority Website (2014)

University of Toronto Map and Data Library

National Air Photograph Library





Fitle Site Location Plan

Proposed Residential Development 382 Burnhamthorpe Rd W Town of Oakville

1410-E133 Reference No.

February 20, 2014


Scale


1:8000

Drawing No.

Approximate Location of Phase One Property

Source: Explore Oakville @ Town of Oakville Interactive Map 2013

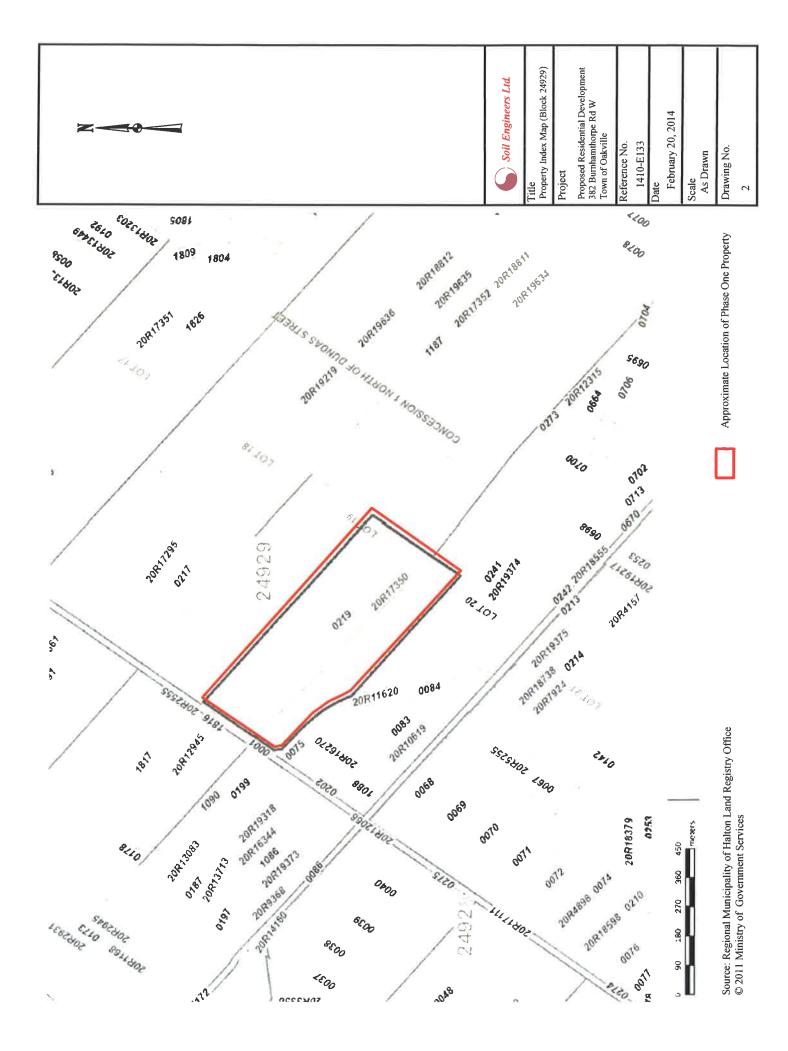

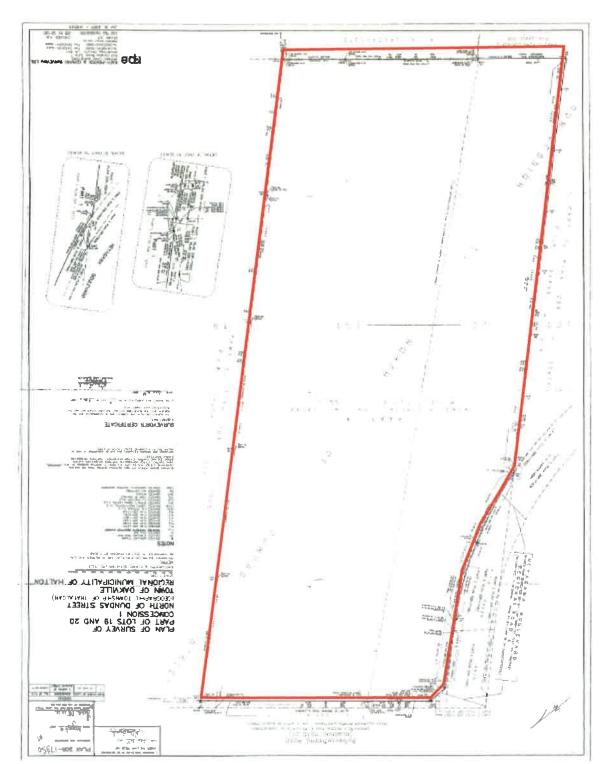

Approximate Location of Phase One Property

Rob! S. Benson




Drawing No.

Scale NTS


Source: McGill University Digital Mapping Library © 1880 The Illustrated Historical Atlas of Ontario County, Miles & Co.

. yong ;up

Approximate Location of Phase One Property

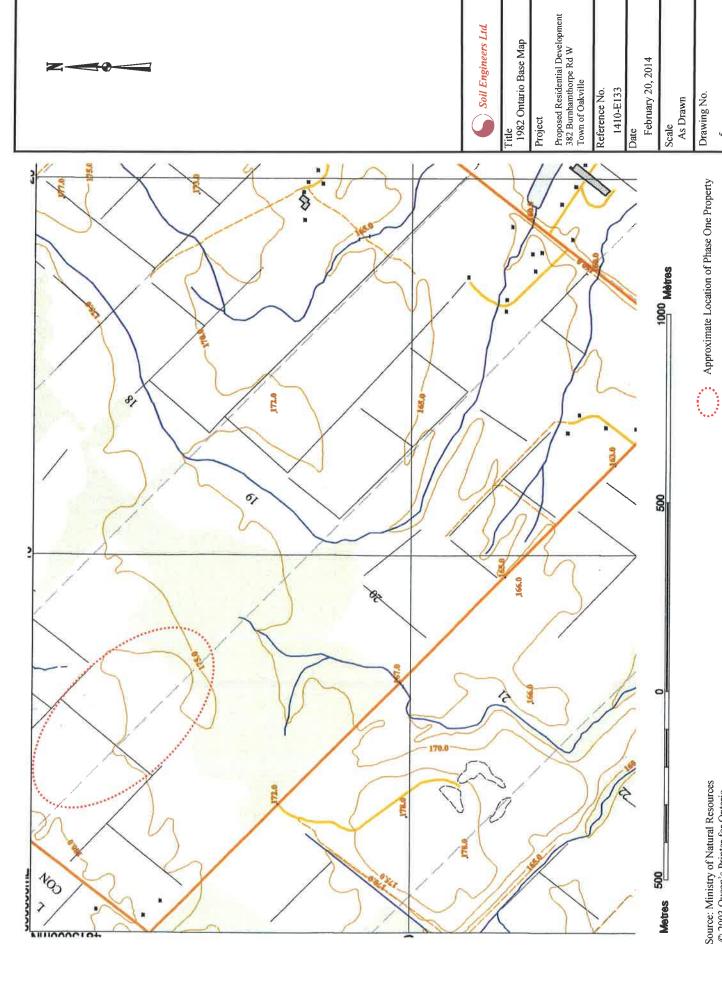

Source: Ministry of Natural Resources © 2003 Queen's Printer for Ontario

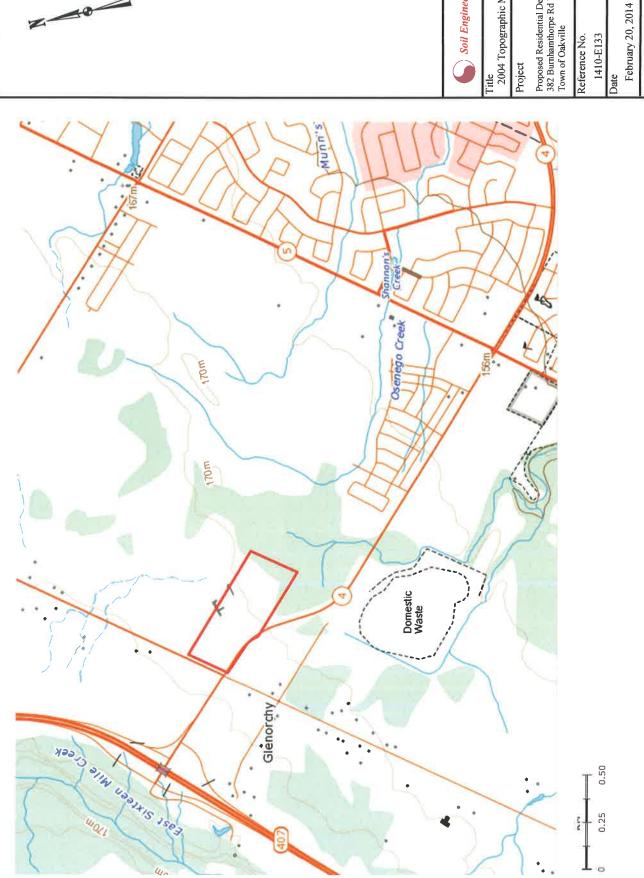

Z-0

Soil Engineers Ltd.

Title 2004 Topographic Map

Proposed Residential Development 382 Burnhamthorpe Rd W Town of Oakville


Reference No.

Scale As Drawn

Approximate Location of Phase One Property

Drawing No.

Source: Toporama Website © 2013 The Atlas of Canada

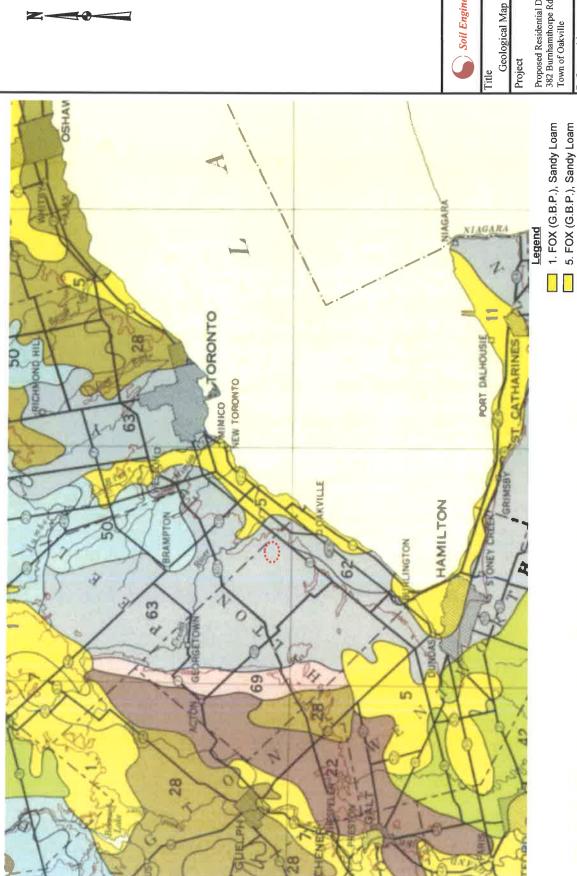

Soil Engineers Ltd.

Proposed Residential Development 382 Burnhamthorpe Rd W Town of Oakville

Reference No.

28. Guelph (G.B.P.), Loam 40. London (G.B.P.), Loam

40 Miles

8

R.

Q

Moles 20

1410-E133

As Drawn Scale

63. Haldimand (G.B.P.), Clay

62. Lockport (G.B.P.), Clay


February 20, 2014

50. Perth (G.B.P.), Clay Loam

Drawing No.

Approximate Location of Phase One Property

Source: Agricultural Agri-Food Canada Website © 2008 Soil Research Institute

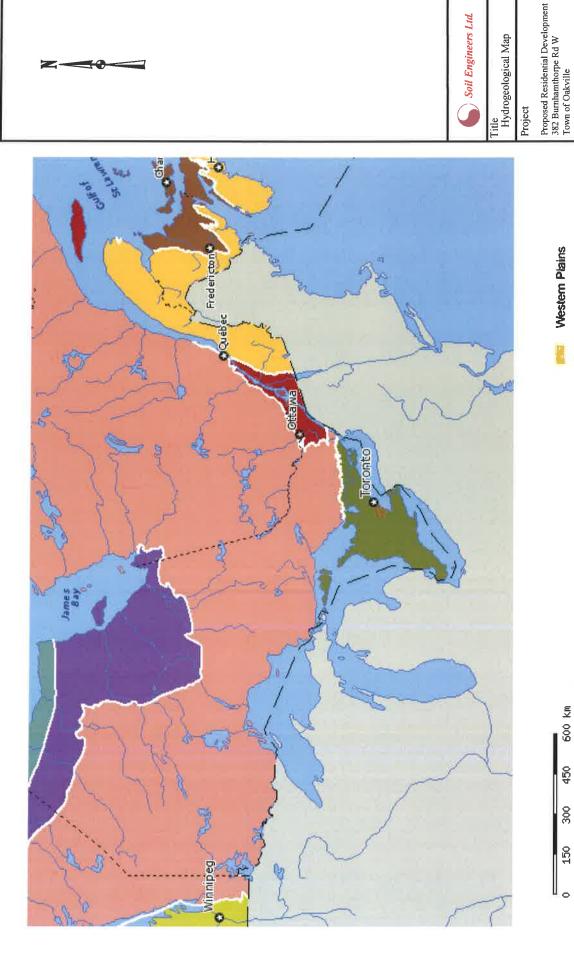

Canadian Shield Western Plains

Hudson Bay Lowlands

Southern Ontario

Permafrost

Drawing No. As Drawn

St. Lawrence Lowlands

February 20, 2014

Scale

1410-E133 Reference No.

Appalachians

Maritime Basin

Source: Natural Resource Canada © Her Majesty the Queen in Right of Canada 2011


Approximate Location of Phase One Property


600 km


5

300

150

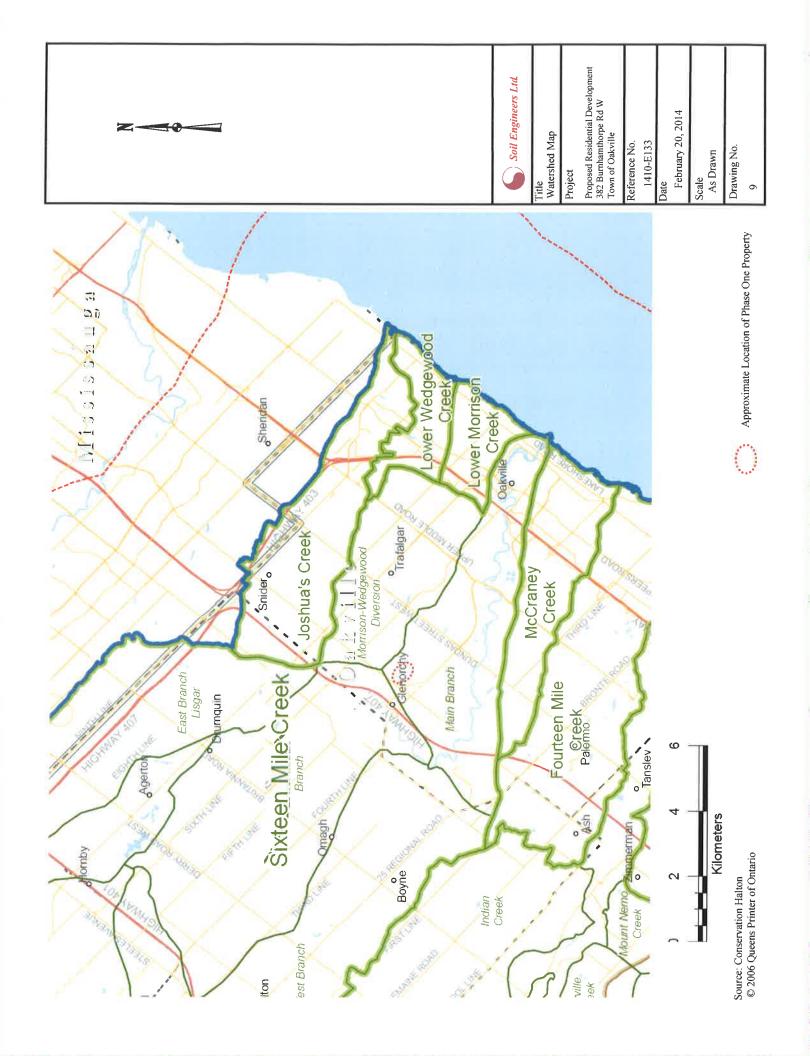

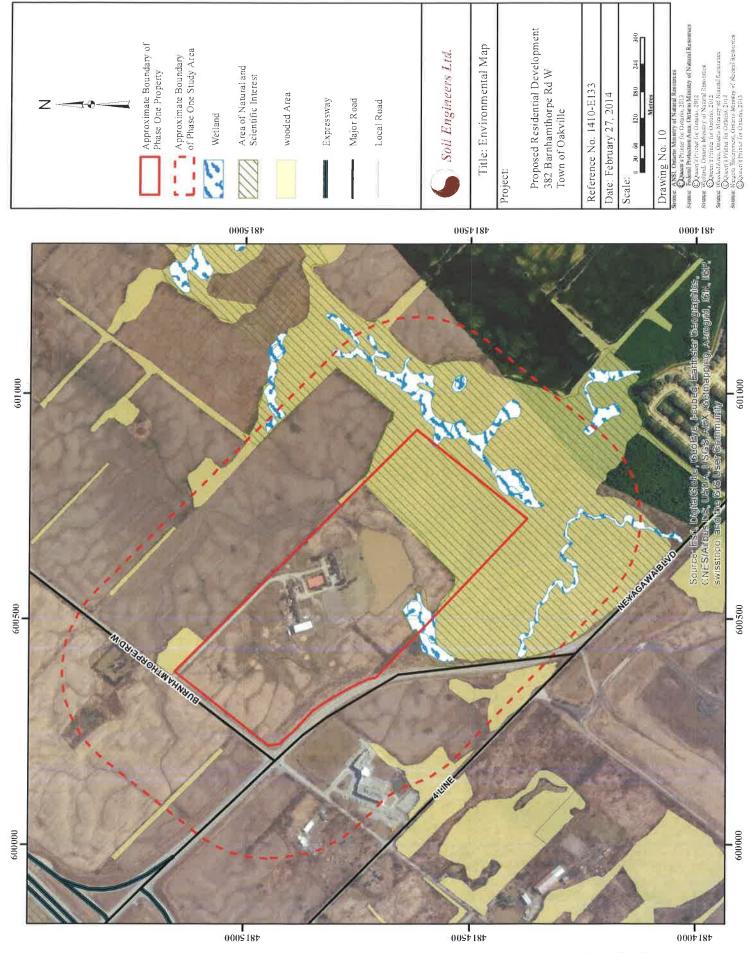

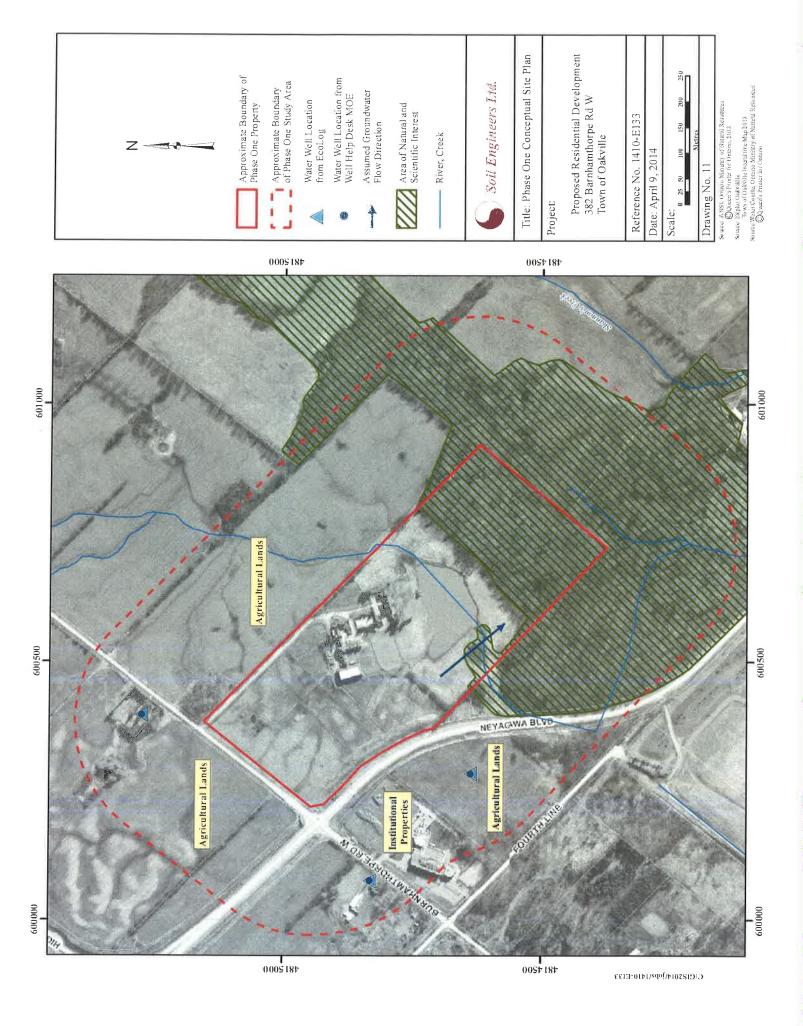



100 NUGGET AVENUE, TORONTO, ONTARIO M1S 3A7 • TEL: (416) 754-8515 • FAX: (416) 754-8516

BARRIE		OSHAWA	NEWMARKET	GRAVENHURST	PETERBOROUGH	HAMILTON
TEL: (705) 721-7863		TEL: (905) 440-2040	TEL: (905) 853-0647	TEL: (705) 684-4242	TEL: (905) 440-2040	TEL: (905) 777-7956
FAX: (705) 721-7864	FAX: (905) 542-2769	FAX: (905) 725-1315	FAX: (416) 754-8516	FAX: (705) 684-8522	FAX: (905) 725-1315	FAX: (905) 542-2769

# APPENDIX 'A'

**MPAC REPORT** 

**REFERENCE NO. 1410-E133** 



# **Primary Structure Report**

Generated on 2/14/2014

**Property Address** 382 BURNHAMTHORPE RD W

**Roll Number** 2401010030026100000

**Legal Description** TRAFALGAR CON 1 NDS PT LOTS

19 AND 20 RP 20R17350 PART 1

Property Code & Description 261 - Land Owned By A Non-Farmer Improved With A Non-Farm Residence With A

Portion Being Farmed

Structure Code & Description 301 - Single Family Detached

Year Built 1985

Total Floor Area (Above Grade) 2967

Basement finished Area

Basement total Area 1042

Heating Type EL

Air Conditioning N

Structure Code & Description 301 - Single Family Detached

Year Built 1988

Total Floor Area (Above Grade) 9181

Basement finished Area 2490

Basement total Area 5860

Heating Type HW

Air Conditioning

Structure Code & Description 301 - Single Family Detached

Year Built 1985

Total Floor Area (Above Grade) 400

Basement finished Area

Basement total Area

Heating Type

Air Conditioning	N
Structure Code & Description	266 - Prefab. Metal (Straight)
Year Built	1988
Total Floor Area (Above Grade)	11400
Basement finished Area	0
Basement total Area	0
Heating Type	-
Air Conditioning	N
Structure Code & Description	204 - Type Iv Insulated Barn
Year Built	1990
Total Floor Area (Above Grade)	2646
Basement finished Area	0
Basement total Area	0
Heating Type	-
Air Conditioning	N
Structure Code & Description	204 - Type Iv Insulated Barn
Year Built	1985
Total Floor Area (Above Grade)	2701
Basement finished Area	0
Basement total Area	0
Heating Type	-
Air Conditioning	N
Structure Code & Description	299 - Unspecified Farm Bldg
Year Built	1985
Total Floor Area (Above Grade)	1936
Basement finished Area	0
Basement total Area	0

Copyright © All rights reserved Municipal Property Assessment Corporation. Not to be reproduced by any means or distributed in any manner, in whole or in part, without prior written permission.

Heating Type

Air Conditioning N

Frontage

Depth

Site Area 58.49 A

Last Valid Sale Date 1998/08

Last Valid Sale Amount \$ 2,622,458



# **Single Property Map**

Generated on 2/14/2014

Property Address
Single Property Map

#### 382 BURNHAMTHORPE RD W



Disclaimer: contents provided on an "as is" and "as available" basis. MPAC and its suppliers make no warranties or representations regarding contents (including accuracy of measurements and currency of contents). Not a plan of survey.



100 NUGGET AVENUE, TORONTO, ONTARIO M1S 3A7 • TEL: (416) 754-8515 • FAX: (416) 754-8516

BARRIE	MISSISSAUGA	OSHAWA	NEWMARKET	GRAVENHURST	PETERBOROUGH	HAMILTON
TEL: (705) 721-7863	TEL: (905) 542-7605	TEL: (905) 440-2040	TEL: (905) 853-0647	TEL: (705) 684-4242	TEL: (905) 440-2040	TEL: (905) 777-7956
FAX: (705) 721-7864	FAX: (905) 542-2769	FAX: (905) 725-1315	FAX: (416) 754-8516	FAX: (705) 684-8522	FAX: (905) 725-1315	FAX: (905) 542-2769

# **APPENDIX 'B'**

**OWNERSHIP HISTORY** 

**REFERENCE NO. 1410-E133** 



PARCEL YEGISTER (ABBREVIATED) FOR PROPERTY IDENTIFIER

OFFICE #20

REGISTRY

PREPARED FOR KELVIN DEE ON 2014/02/11 AT 13:24:13 PAGE 1 OF 1

OFFICE #20

\* CERTIFIED IN ACCORDANCE WITH THE LAND ITILES ACT \* SUBJECT TO RESERVATIONS IN CROWN GRANT \*

PT LTS 19 & 20, CON 1 TRAF NDS, PT 1 20R17350; OAKVILLE PROPERTY DESCRIPTION: FOR THE PURPOSE OF THE CUALIFIER THE DATE OF REGISTRALION OF AESOLUTE ITLE IS AUGUST 9, 2007. PROPERTY REMARKS:

ESTATE/OCALIFIER: FEE SIMPLE ABSOLUTE PLUS

RECENTLY: RE-ENTRY FROM 24929-0074

PIN CREATION DATE: 2007/08/09

SHEREORNE LODA	SHEREGRY LODGE DEVELOPMENTS LIMITED	CAPACITY SENICED BENO	डसहसङ		
REG. NOY.	DATE	INSTRUMENT TYPE	PARTIES FROM	PARTIES TO	CERT/ CERU
** PRINTOU	INCLUDES AL	** PRINTOUT INCLUDES ALL DOCUMENT TYPES AND DELETED INSTRUMENTS SINCE:	MENTS SINCE: 2007/08/69 **		
**SUBJECT	to sussection	**SUBJECT TO SUMSECTION 44(1) OF THE LAND TITLES ACT, EXCEPT PARACRAPHS 3 AND 14 AND	PT PARAGRAPHS 3 AND 14 AND *		
2	FROVINCIAL	FROVENCIAL SUCCESSION DUTIES AND EXCEPT PARAGRAPH II AND ESCHEATS OR FORFEITURE **	PH 11 AND ESCHEATS OR FORFEITURE **		
* *	TO THE CREME	TO THE CROWN UP TO THE DATE OF REDISTRALIDM WITH AN ABSOLUTE TITLE	H AN ABSOLUTE TITLE		
408278	1983/05/03	AGREMENT		THE CORPORATION OF THE TOWN OF DAKVILLE	U
H751099	1958/08/20	TRANSFER	\$2,622,458 FIRESSTONS, DAVID MORGAN FIRESSTONS, DENTE	SHERBORNE LODGE DEVELOPMENTS LIMITED	U
20R17350	2001/03/03	PLAN REFERENCE			U
HRS92388	2007/09/09	APE ABSOLUTS TITLE	SHERBORNE LODGE DEVELOPMENTS LIMITED	SHERBORNE LODGE DEVELOPMENTS LIMITED	(( <b>U</b> )
AR658103	2008/04/24	NOTICE	THE CORPORATION OF THE TOWN OF GANVIELE		(0)
HR689764	2008/08/15	NOTICE	\$1 NORTH ORNTELE COMMETTY BUILDERS INC.		Ľ2
HR719272	2009/21/25	NOTICE	NORTH OAKUTLLE COMMUNITY BUILDERS INC.		Ü
20R19373	2012/10/10	PLAN RRERENCE			ę.

NOTE: ADJOINING PROPERTIES SHOULD BE INVESTIGATED TO ASCENTAIN DESCRIPTIVE INCONSISTENCIES, IF ANY, WITE DESCRIPTION REPRESENTED FOR THIS PROPERTY.
NOTE: ENSURE THAT YOUR FRINTOUT STATES THE TOTAL NUMBER OF PAGES AND THAT YOU HAVE PICKED THEM ALL UF.



REGISTRY

PARCEL REGISTER (ABBREVIAIE), FOR PROFERY IDENTIFIES

CN 2014/02/11 AT 13:28:04 PREPARED FOR RELVIN LEE

PAGE 1 OF 3

OFFICE #20

- 24929-0074 [LT]

- CERTIFIED IN ACCORDANCE WITH THE LAND TITLES AGT \* SUBJECT TO RESERVATIONS IN CAGMN GRANT \* OFFICE #20

CORRECTION: INSTRUMENT NYMBER 20R2752 WAS DMITTED FROM THIS PROPERTY IN ERACR AND WAS ADDED AND CERTIFIED ON 1999/09/14 BY LISA COTE MCKAIN; PT LTS 15 & 20, CON 1 TRAPALGAR, NORTH OF DUNLAS STREET , PART 1 , 20E2752 , EXCEPT PARTS 1-5, PL 20R11482 ; OAKVILLE/TRAPALGAR ESTATE/QUALLFIER. FEE SIMPLE LE CONVERSION QUALIFIED PROPERTY REMARKS:

PROPERTY DESCRIPTION

RECENTLY: FIRST CONVERSION FRCM BOOK

PIN CREATION DATE: 1996/03/25

CAPACITY SHARE BENO OWNERS! NAMES SHERBORNE LODGE DEVSLOSMENTS LIMITED

REG. NUM.	DATE	INSTRUMENT TYPE	AMOUNT PARTIES FROM	PARIIES TO	CERT/ CHXD
**EFFECTIVE	E 2000/01/29	THE NOTATION OF THE	**SPECTIVE 2000/07/29 THE NOTATION OF THE "BECCX INFLEMENTATION DATE" OF 1996/03/25 ON THIS PIN**		
***** REPLA	ACED WITH THE	**MAS REPLACED WITH THE "PIN CREATION DATE" OF 1996/03/25**	05 1996/03/25**		
** PRINTOUT	T INCLUDES AL	IL DOCUMENT TYPES AND	** PRINTOUT INCLUDES ALL DOCUMENT TYPES AND DELETED INSTRUMENTS SINCE: 1996/63/22 **		
**SUBJECT,		ON FIRST REGISTRATION UNDER THE LAND TITLES ACT.	AND TITLES ACT, 70;		
A +	SUBSECTION 4	TII GNET EHI 30 (I) ##	SUBSECTION 44(1) OF THE LAND TITLES ACT, EXCEPT PARAGRAPH 11, PARAGRAPH 14, PROVINCIAL SUCCESSION DUTIES *		
h t	AND ESCHBAT	AND ESCHBATS OR FORFEITURE TO THE CROMM.	; CROMM.		
# %	TRE RICHTS (	OF ANY PERSON WHO WOLL	OF ANY PERSON WHO WOLLD, BUT FOR THE LAND ITILES ACT, BE ENTITLED TO THE LAND OR ANY PART OF		
π +	IT THROUGH .	LENGIH OF ADVERSE POS	IT THROUGH LENGTH OF ADVERSE POSSESSION, PRESCRIPTION, MISDESCRIPTION OR BOUNDARIES SEITLED BY		
1	COMVENTION				
St.	ANY LEASE TO	WHICH THE SUBSECTION	ANY LEASE TO WHICH THE SUBSECTION 70/2) OF THE REGISTRY ACT APPLIES.		
**DATE OF	CONVERSION TO	CONVERSION TO LAND TITLES: 1996/03/25 **	** 52/		
NOTE: THIS	PROPERTY MAS	S RETIRED ON 2007/08/C	NOTE: THIS PROPERTY WAS RETIRED ON 2007/08/09. THIS PROPERTY IS NOW RE-ENTERED INTO THE FOLLOWING PROPERTY: 24929-0219		
20R2752	1976/08/12	PLAN REFERENCE			U
575874	1963/05/03	AGREMENT		THE CORPORATION OF THE TOWN OF DARVILLS	õ
23665	1989/03/03	CHARGE	*** GATELEC YLATER OF ***	CANADIAN INPERIAL BANK OF COMMERCE	
746326	1990/06/21	TRANSFES.	*** Calerd Kierek Observer	FIRESTONE, DAVID MORGAN FIRESTONE, BENTE	
20R11482	1994/07/04	PLAN RETERENCE			U

NOTS: ADJOINING PROFERTIES SHOULD BE INVESTIGATED TO ASCRIPTIVE INCONSISTENCIES, IF ANY. WITH DESCRIPTION REPRESENTED FOR THIS PROPERTY. NOTS: ENGURE THAT YOUR FRINTOUT STATES THE TOTAL WINESE THE TOTAL WINDOW.



PARCEL REGISTER (ABBREVIATED) FOR PROPERTY IDENTIFIES

PREPARED FOR KELVIN DEE ON 2014/02/11 AT 13:28:04 PAGE 2 OF 3

OFFICE #20

\* CERTIFIED IN ACCORDANCE WITH THE LAND TITLES ACF \* SUBJECT TO RESERVATIONS IN CROWN GRANT \* REGISTRY OFFICE #20

REG. NUM.	DATE	INSTRUMENT TYPE AMOUNT	TND	PARTIES FROM	PARTIES TO	CERT/ CEKD
825493	1394/07/14	DISCH PART CHARGE		*** COMPLETELY DELETED ***		
137	REMARKS: 711655					
H648998	1996/10/17	APE COURT ORDER	- 4	*** COMPLETELY DELETED *** SUPREME COURT OF ONTAREO		
1869281	1997/03/19	APL (GENERAL)	, 14	*** COMPLETELY DESETED *** FIRSTONE, DAVID MORGAN		
	KENNAAS LELEI H648398	H648998				
H682679	1957/05/16	CERT PENDING LIT	4	*** COMPLETELY DELETED *** KONJEVIC, ZORAN		
H6889C8	72/10/1551	DISCH OF CHARGE		*** COMPLETELY DELETED ***		
KE	REMARKS: RE: 719565	10 10 10		CENADIAN IMPERIAL BANK OF CORMERCE		
E712140	1997/11/28	CAU AGR PUR & SALE		*** COMFLETELY DELETED *** FIRESTONE, BENTE FIRESTONE, D. MORGAN	HORVAT PROPERTIES LIMITED	
H725666	1998/03/02	APL COURT ORDER		177		
超	HENDERS: H682679	91		FIRESTONE, BENTE		
H726112	1998/03/05	APE (GENERAL)		1-4		
EG Ec	FEMARKS: H712146	- 50		FIRESTONE, BENJE		
Z0R12712	1996/03/20	PLAN REFERENCE				ů.
H751099	1998/06/20	TRANSFER \$2	\$2,622,458	FIRESTONE, DEVID MORGEN FIRESTONE, DEVIE	SHERBGRNE LODGE DEVELOPMENTS LIMITED	2 <b>00</b> 6
HX566858	2007/05/14	NO APL ABSOLTTE		SHERBORNS LODGE DEVELOPMENTS LIMITED	SHERBORNE LODGE DEVELORYENTS LIMITED	
20R17350	2007/08/09	PLAN REFERENCE				ÇJ

NOTE: ADJOINING PROPERTIES SHOUDD BE INVESTIGATED TO ASCERTAIN DESCRIPTIVE INCONSISTENCIES, IF ANY, WITH DESCRIPTION REPRESENTED FOR THIS PROPERTY, NOTE: ENSURE THAT YOUR STAIT YOUR STAITS THE TOTAL NUMBER OF PAGES AND ITALY YOU HAVE PICKED THEM ALL UP.



PARCEL REGISTER (ABBREVIATED) FOR PROPERTY IDENTIFIER

REGISTRY OFFICE #20

PREPARED FOR KELVIN LEE ON 2014/02/11 AT 13:28:04 PAGE 3 07 3

OFFICE #20 24929-0074 (LE) \* CERTIPIED IN ACCORDANCE WITH THILES ACT \* SUBJECT TO RESERVATIONS IN CROWN GRANT \*

REG. NUM.	DATE	INSTRUMENT TYPE	AMOUNT	PARILES FROM	PARTIES TO	CERT/ CERCD
HR592388	2037/08/09	APL ABSOLUTE TITLE		SHERBORNE LODGE DEVELORMENTS LIMITED	SHERBORNE LODGE DEVELOPMENTS LIMITED	ů.

NOTE: ADJOINING PROPERTIES SHOULD BE INVESTIGATED TO ASCERTAIN DESCRIPTIVE INCONSISTENCIES, IF ANY, WITH DESCRIPTION REPRESENTED FOR THIS PROPERTY. NOTE: ENSURE THAT YOUR PRICKED THEM ALL UF.

would by what -110 mg 120 aug 18.45 \$ 3.44 way or stare.

58.67

That file Airs. Not New did to

Elys Donler

11/1/100 - 11/1/100 -	ED IN PRIL	4 1 1 2 1 2 1 1 4		2,	0. W.
10.50 (10	Du RRU	1 2 1 3 1 1		310 37 1 1 1 1 1 1 1 1 1 1 1 1 1 1 1 1 1 1	0. 4050 W. 4050
100 mm m	Day No.	1 2 3		3	0. <u>1</u> 159
The same of the sa	Da Reu	1 1 4 1 1 1 1 1 1 1 1 1 1 1 1 1 1 1 1 1		3,77/10	W. 401576
	Spin Ru.				
	Du Ru.				
	Du Ru.				
	Dau Ru.				
	Dan ma		The second of th		
	Date Billion	y children	Service Manual Manual	1	
	The state	of the state of	-	. 11. 11.	4
	700.00	7 1 2 1 2 1	1	111/10	•
			Knie X amine	No. 24 12	101/3/1
26'0 ii Put	76	111	are by marine .	35	The same
20   0   6   6   6   6   6   6   6   6	(:	**************************************		1000	- 20c 818'a
		to X Memoring Man	by the line	W. 100	181 00 780
		المصفور مسمون	,		
		The state of the s	18.35 TO		To Property
		1		DIC	9.
	Lancola - Nasmory	The same of the		3	200
				1	A
	Thenk with 1874	* × 4			reson Chiny
Les conque in man les es e		A. S.		3	- (may)
Les conque versante les constitutes la constitute de la c	101				
Les compressiones les se de la company de la	denies denies			-	
The family of the state of the	Level 1874 1984 1994		The state of the s	-	The second second second
4		- Commercial Commercia	Che said from Promue	8.FE . 18.E.	C.C
There divine divine		1	the mix mone		The second of th
	a sometiment of the sound of th	muse demining	Dearness (		

	-	1.1	7 1				- ;	1	1 1			11/66		X 35	
	REMARKS	14.60%	Section per	3.样.		The second secon	in the second		Color 19.	12 C - 12	×	2) 6 - 4 - 5 - 5 - 5 - 5 - 5 - 5 - 5 - 5 - 5	2000		66.70
£1.3	CONSIDERATION	2.00	V			0 0 0 0 0 0 0 0 0 0 0 0 0 0 0 0 0 0 0	7		1		14.45		1 67		
DUNDAS SIREET	GRANTER	Have Francis ding	Process Bouries Person				would divising a	\$ - 1.5 · · · · · · · · · · · · · · · · · · ·	March of Sources	23/2/25		2/0/16/20	Course of Burney	Contraction of the court	3. total
	GRANTOR	Aus & maine frames	Lags H. Hay	the found by lower	to deposit of	Lo 1758-12	to specuis for the con	to want by xon	L'inter face				The Commerce	oue House good	
	BEG-STRATION	monde	- September	23624,1194	un state	surges	Grans	16persy	The state of	<del>-</del> 2			100 1111 12		, i
	Destriction	-dems	mobile	4 300	11. Selema	Solitans	12 Keelers	#XIII MEX	22 true	<del></del>		\	The comes	2	,
	A CONTRACTOR	1		Ayr.	1953-12 1953-12	1/10-36	453-15	By	111.2		1		12.1.6	Y	1.
	23,246	-24225	rfots	635	1436	485	499	250	7007				33//3-	7/578	y

The state of the s	CONCE SAISON ( ) D. D.	CONSTRUENCE	- Males A	Charles and and a second		2 cylions	Kewitting 19000	my story	3/657.	2 9/4/46 pm		30	3/2/8/2		, i.	4. 4. 4. 4. 5. 4. 5. 5. 5. 5. 5. 5. 5. 5. 5. 5. 5. 5. 5.	4. m 3.25.17	2011/12 m		27.19.46 f. 24 k. 18.19.18 18.45.34.97.16.200.5.6.0	1. 1.W. 246	restuilting in	4.633.		* Comment	to My lim dender 8 33503	to come to the	Tolling.		J.		1 5 m C	
Control Maries of their themse downed & Marie of the second of the secon	9	REMARKS	9.00	4			Part tat 19. with a	Sen 12 4 1350	mest.	A 1001 25312 A		1.	1. DISTO 15655		( " 1 / 0 / 1 / 1 / 1 / 1 / 1 / 1 / 1 / 1 /		127 Cath 18420	Juny 20502		12/19/19	cont lengals	Part 16/19 40 cm	Part Pollo	FT most. 50 36.	マーナングンサンション	of social and	100 and 200 320 4/2 2.4 2.50	+ + 11/3 471.70 F		41.12084 × 1658	~	35	
Land I Marie of Their of Land Common		GRANTER	allet H. Je Caton	Hellen o line Sun Collins	Long G Maring a 12	Moure to jai	. ster		9	id to dimension	1	i i	Marked on joint assessen		Celon o		Est. of William Hulent Jehan	Muret the	12 1 1 1 1 1 1 1 1 1 1 1 1 1 1 1 1 1 1	Den Calen & Man	The start		11 g m	Marie	N. N. N.	16/20 DISTI (6000)	1,,,,,	then test head a during to			1	140	
26.6.6. 1000 1000 1000 1000 1000 1000 100	Jufugu.	GRANTOR	nadian 1	brief Morrise a Variable	14 P. Marie Mais 11-2.		ell & Marrier day P.		ave.			S. Herr. C.	Herres, has loft		Marie hos		'C.T.	200	5 mil	a findal	20,00	3		7	The same of the	200	1	W. C. C.	4. 6. 16. OF	C.1. 7. 0 6 2.	at Morning	Morivee, his wife	
The state of the s	42.60	INSTRUMENT INSTRUMENT ACCIETATION	M. V. Constillation		- 20 Mich. 1926 2 Whay 1956 Ju	<i>b</i>	7 231/16/ 1906 28/124/1905 SLO	13/11	13 15 15 15 15 15 15 15 15 15 15 15 15 15	into in the stanging	12thelinather	on the hamilton	100	1 2 C 2 // C C C			65/120199 Bhu1959 14	-			N	3			1	0	the sail	1			$\sigma_{j}$	(U)	

we colored CONTINENTION J. 552.1 126617 and 196545 31/100 1 to ens 1,86 the wanten died 21437 more Wanted "M" And Moly is in 1239 " evill warmeling SHELT NO Max 50 950. 3/18/22 PLAN NO. Al Lat 19 - with yeaption -LOT NO. 44 morallis 565, 60 xmill A Le 19 4 another REMARKS cu 12890 02. かんんいことし 1 horx 63813 Standay Junegymetie ! Leave mitting the trans though historic personal capacity mutit to prove to Sales and & prince Goneld S. Bornice & Lone P. muld to Marice Thunky First pyroshi 1 Elocated Es Fing in and Phinodone THE STREET STREET Queken Boldings Methodanie Same dura 1. Morres GRANTEE Charac 1. Mornie Gother 4 3 the word should proper harmen matil of Minerian 1 3 una alled 1965 5 The 1966 Beald St. Mories of Line stravel T. ills and . Il wrestly puty 127 Garden : Sitting, Howard 16. et street mound Amend Handle and his wind Haman, Har Tiet white GRANTOR Jan 100 18 Jan 1966 Bather Spermen lue ico edow of 3 stolered its much からかんすん Phome " generales Gucken 25th 1961 11 4. my 161 PEGISTRATION 196 27 2 Azigazation to OAKITLE - TRATELEGIS 133411 OCT. 18, 1951 | JULY, 13, 1952 Mr. 9. 127 2 may 1965 INSTRUMENT 137/92/20 Sand 343H 31:15 28.367 01 つくらうい 51113 5753 9389 (Ot 10) PLAN NO. 4

7.2rc Same? 27 des com 138859 over no 10 d The same of the sa do un access FEBU. Last lot of - how Malen SFEB 12 20 en 266653 , 102.9600 pt 25019. I ansilin Lot ( com. 2811 1 35 ans PLAN NO. LOT NO. A Lot 19 another Lot Of Let 19+ another Led. Hiter 110 another Lot J48881 4.8/1/5 -4:5364 w divide 439855 REMARKS Acres 446655 Prose 22 368 1,20.00 Odyma Burelefment described to Inchibition out Lobba Francismento 1261 Sun america detraction in ments amonto leaved marie matches GRANTES Discharged by a. 7. 260% has Pay Land Reg. St. Limited. Pathin Imuted 19 M. Maler Level Comme of and fruit. of services. is colored you rainin Level month exerce Merrie Mindelaine imited and America 10 19th of a dotra investment Le maried Throward. Lobra Insustruents Genton H. King & unfe somy por Conald it monde GRANTON Cues. 0 15 des 1765 33 Car 1965 15 Westies 25 Gerines 10/1 mar 1/0/ Con. 1. N. D. S. scipe hooned Barren. 13610014 \$ 11. -. 1969 15 \$ 34876 Cin mined B. R. 3575 METRUMENT 22001 Las 77836 Juit Dent Ch 13 1 75.3037 1 338038 584823 C 9992 PAREST NO. -PLAN NO 101 M t

againer 1. agen mente 4 3205 7 2+5 200 3 Landon At. 27 (9 West from A. A. C. 19 West from A. SHEET NO. #4 128 19 Coming Noting berns. Blunders St. Hung Born 183.

Thence Hilly from Lot Long 150,

Thence Hilly 350, Styl 150,

de 250, New, 150, to F. O.C. PLAN NO. Priety some some 271326 TOSOHARGED BY 262481715ST. DEP. LAND REC. Em) 501 NO 1000年1000年100日日 75-1 Let 19, we we lee tak were include with REWARKS Jact 77, 2 87-LY 19 73.1.7.1g ナンナナン The of the Limited Franco and mornies Directali Die 1 21.554 GRANTER Jenicant Fraces Moude Leasa 8 Hailer D. Halter) Donald Atombert Two egynoles yand mounies Athero Leaned Hearington Semited חים ניינום תורב חיום או תחי Luci och GRANTOR ei-Chinai and Stephan Then Lupen wife thenty Å いっている Samo d 3 ₹ 10 Transtante Sugarion Acing \* W. m. 27 per 1973 portion 1973 20 Just 113 General march J. 10. J. A ...... ħ 4.50 222 1 57 122187 2318 PLAN NO. 376 312 19

MAN NO. Con. 1 NAS Ch.S. Je: Rendent Developme P. Lot 19 40 the land des as 14 322142. 0.13; cc./ 2 20 m 258659 - 6, 180 at 1 P. 376312 . Con 2 ch , Cy CONFIDERATIO Com tre 500 1 3 m / 6 4220 - 0,034 die The Supper with the thing rated Control of the second of the s 111-61, 10. Co. Co. 1 1/43 6 372 4 80 SHEET NO He Cognetion of the Beam 1.4 1419 yex another let lesign 1 7 NO. LAGOR ALD TRUE FOR REK 42 277 2 ... Dr. - 204 463 \* distrib \* pot colonic ter 14750m W. 21 1/ as = 3 Discharged by # 6462 Wast Dep. Land Reg Sed es 143 on 201 - 2752 ただったが ration testing REMARKS ........ 11-1 265.143 Emonitine Allien Smith admin. of the Estates as in Limited & Vine Afraga, Maia Tarera 2 200 m I capoution of the how work A. Morries. Watter him works GRANTEE the woodetien dutant Dayne Verelogonet with sine of me Lectores Hickory, cook of their wast. 1. Lante 1 1.5 GRANTOR a star demoki soutest 1 1975 DATE OF CATE O cor. 227 ly Plans Lent 2. Out + 124, 1415 35m, 197 1,1 3, 5 4an 11 May 2.01.20 May 1936 ジロブ - Orel 4375 Many 1 Lung 12 Agree 1976 40% ٠ الله الله 2 Control が北京 SHEET NO. NUMBER

The cay with the the Methering the Charles and and my of other if 43 th ing the consupering the part of the wife Hopers. これからかったいかん worden in had him dek LOT NO. 4 25.2147. Ku. May 5. 10 21 1 10 52 02 ) SHEET NO. PLAN NO. 17 4 11 19 Mary 16 16 2 (N 0.219 disign, a. くないのととい 13. A. C. S. 12 W. Kind Spilly 5 REMARKS 12 1 16 433 C The state of the state of the state of the state of シゲ is my situat ingration way new a very made and the state of t The form of the second of the AT Car how the said St. a. a. Take GRANTEE Humited 7.0 tuntling wingan The Astraction Carelly Y. 10 mg 2000 000 a actal behinsky Lit. Tollit Track Smill million a day works with the コンスで、コー GRANTOR Likely of Child 33333 S والمنوا المرودلة الدلائدال 80.N date or / 1777 1 N 45 1 1/2 50 Just ... + Linel Bring 330 Exputering .. ... 12-25-11.84 てより Her light A P1 19 PLAN NO.

5/3

104 8334

SONTIDERATIO

The state of the s	S. MORENERS 111  LAND AND REVARES  Of Lot 19 devinated 200- pt 2 ca 35K- 20 99 2 1 pt  another Lot	The things to the second	at lat with a region as 437.	10000000000000000000000000000000000000	of the the deaptra	the effection, according provided in the 514565.
Marie Common Com	Consequences  Consequences  Consequences	7 76/	Estate of Chamber B350 coon		Land hyson	3,800.
Juna 1978 Juna 1	19 GRANTOR GRANTOR J. Developments		art. Tegent neverte + Viel	Jana Jana	ted " the ted water of the test of the tes	to Unesche.  2 theorem to And Hall
	2. 137 12		13 min 1978	6 1 1	Alexandra Alexan	20 Dec 1972

					i
					Ì
	(	3	h		į
		,			
					•
	J		_		
	i	,	٠	١	
	٩	۱	•	ĺ	
	•			•	

SON 1 NOS

PLAN

		d.nit	-			3 Tol. 2		1			100	
	LAND AND REMARKS	64694 m	ss in 449942	1n #469942		TCH proviscons		n 54.7903	5//	in 427973		J.
	LAN	46. Set us un	Patrasii unich speeph	Part lot as in #469942		en 2011-27 JR.	: 1 : 5	99,805.43 Pt. lot as in 54,7903		Pars les as in	F	-as <del>/10-271426</del>
1	CONSTRUCTOR	29,483:	2,408,2	9	6	1.	(III	89,805.43	1 200 1 5	29,030.17	69	-900-054
The state of the s	GRANTER	Welter Dinewale ;	Truster Sugarchule,	Walter & Melinka Dinevski and Victor Prousky, Trustee	Salted		of Wettomet Revenue (Texate	BINEVSKI, Walter TURCZYNSKI, Stanley PROUSKY, Victor	PROUSKY, Victor, Trustee Edgar Howden & Sons Limited RIZZUTO, Carlo	SELICH, Harry	TES FORTHER LAND ALL BY	FRASCA, Glovanni
The state of the s	GPANTOR	Solyan Howelens - Sons Lemeted, Pleutelf	ande Rizzett	Carlo R.zzuto	The state of the s			The Corporation of the Town BINEWSKI, Walter of Oakville PROUSKY, Victor		UNCOUNCE, Statistic		Potsok, Vincent
	PEGISTNATION DATE	285. 525.20	L.1980,	30 Apl. 1980 (	1501	0.4		07 10 81	5	\$ F :	25	05 05 80 EV
	DATE OF INSTRUMENT	S. 7661730	21 Jehra 28 J.	33 Apl. 1933 30	, v.	TOTAL STANCE OF THE SECONDARY	<u> </u>					Mare 10 50 67 Red Red For Box
	ANDRONE Shi	Cales, Festion	F.J.	# 15 # 0 # 11 # 11 # 11 # 12 # 12		West 6	9 117 9 118 14 118	Trea_urer "s Declaration		7 L T S T T T T T T T T T T T T T T T T T	(1)	HOSE 65
515975	MANUSTRA TION	518715	814815	60 00 00 00 00 00 00 00 00 00		J.	1	1,505,315	-	-1		606348

LOT 19

No. of Street, or other Persons and Street, o	INSTRUMENT	INSTRUCTOR	REGISTRATION DATE	GRANTOR	GRANTEE	CONSIDERATION	LAND AND REMARKS
6971.49	Son Sien di	Scharged by	day/monthyea	. 1			
, crock		2	3 ;	4	8	11,219.27	Pt & OL des. as Pt 1 on 208
	100	0.0 656 549 0.0 656 549		095	Admor Sompany Limited		Res Con Lion No. 607419 P.
1							
609830	Order		15 11 64	Town Of Oakwille - In the	metter of By-I'eu 107023		18 18 18 18 18 18 18 18 18 18 18 18 18 1
			:		*****		2.78
				to prov	to provide standards for the		With exception
516315	Grant		29 03 35	Gdynia Developments Eno	nance and occupancy of proper Eno Investments Limited	erty	Part des as part 2 on 2012-2752
1				Limited			
			9 65 6		The Sorporation of The	511,185.2	Part as in 322147
1					Town of Cakville		*)
į.		7	S. C.		The Comporation of The		Part as is 322147
6					Cown of Oakville		
	71000 E		**	THE PROPERTY CANADA VA	Scarema Plumbing & Mentage	\$10,215	Dece 100 or 1 see so sop 10 for song
of sources	1 - 60	*****			-1:18:		
4 1 1 1 E F	Je2051		17 12	45			Part With exception
		(44					Re: #425409
- 40.00.00 - 40.00.00	- rate of		17 12 #	45 PROUSKY, Victor	647121 Ontario Limited	\$360,000.	Part With exception
	70 OF						Under Power of Sale in Mortgage
-02126	Trop,		17-12-6	85 647121 ONLANIS Limited	Property Communication Communication	3150 000	#1,40,09
				_	on Lieised.	A	6 59236 Asst. Den. Land Nov 34
1.026	المائد ا		19 12 8	5 6:7121 Ontario Limited	Enuavest Pinsnoial	390,000	Part With exception
					Sommices Inc Mch		1 1 1 1 1 1 1 1 1 1 1 1 1 1 1 1 1 1 1
To The	Hore		31 6	5 647121 Onesrio ingited	Saton Say Truet Carpent	360,000	Part with excention
25333	2005	printegalary	0	3 - 1 - 1 - 1 - 1 - 1 - 1 - 1 - 1 - 1 -		discharged h	discharged by # 6 6/2 59. Asst. Dep. Land Reg. 39.
				Control or managed	reduced the reduce	Discharged by	Discharged by # 66/298 Asst. Out. Land Reg
202	Sax Arrears		07 21 36	Town of Dakville	DINAN'SKI, Walter		Part as in 626256
San San	James Atlan Cere				Î		
Vacated 8y = 710851	158017 =				40		Te: Con tion #631566 (N.Q.)
635337	Stant	0.0	03 (12 86	Gdvnia Develonmente Limits	*		The second secon
}			!		ENO LAVESTMENTS LIM: LEC		Pt lot des as pt 2 on 20R-2752
650680	ť		26 09 86	FRASCA, Vincent	KALIRAI, Avtar S.	\$148,000.	As in 271425 With exception (376312)
				FkASCA, Maria I.		_	

19

**************************************	INSTRUMENT	DATE	CHANICK	GRANTEE	ETC.	LAND AND REMANKE
		26 00 36	Kaliffel, June 5	EDACCA, Cioucont	COR 500	Apr in 271626 With Excent a 4110343
Estated FT. Was	- And Day bred log (	4637				
SSIZE Non	,	1 2 2 3	FIRESTONE, Bould N	Canadian Ispecial Bank of	500,003	- 275 6 01 dos as Parr 1 on 208-2752-
4	MAST. DEP. LE	DREG. DO	The second secon	Commerce	0	
capast clackers		¥2 12 u6	Town of Uakville	THE REAL PROPERTY OF	7	#505800 Property Standards
559237 Grant		30 01 87	647121 Ontario Limited	Dynasis Inc.	\$350,000.	P <u>t</u> (632969)
100 - 1 - 1 - 1 - 1 - 1 - 1 - 1 - 1 - 1	10 - 10 - 10 - 10 - 10 - 10 - 10 - 10 -	8 55 S	Dynasis Inc.	Duca Coumanity Credit Union S	- 000 to	-8:(632369)-
**************************************		-	Ourself Too			
201 - 1 36h 039 1 32mm	Feet 25 125	ð		Esten Trust Company R.A.S.P.	100,000	(506556)
-		6	0000	Acmor company cimited (1114)	truckie)	Discharging con bier 669413
-	715.34			-ringstone, pacid M.		Vacation Gent of Action
•				SHAMBERLAIM, Demolition		*:
**	770.4			PAYLOR, Carol C.U.II. ag-		74.0
				Chamberlain Benefitton (Bel	(Hatendante)	
		11.06.43	Ben Tresstments Ideal		317,000	Pt deg - 35 pt 7 yn 208-2752
645,779	.54	W.		mond		TO Pue
		>		HARKOVICH, Andre		
nas. Nort		29 01 87	DV. S. SKY	LVANTA	000 5265	100000000000000000000000000000000000000
					arged by #6	Discharged by #65 9 96 KOAset, Day, Land Reg. Of
E777196 York	21 (55)	29 09 87	DYKASIS INC.	EATON TRUST	STS, 000.	DISCHARMON PY TO 3518 ASST, DEP. LAYD REG.
37011 1925		180	FIRESTONE, Devid Mongon	CAMPOJAN SHOESTAL BANK GE	5270,000	Part A Of des. as pach J. on 203-2752
DISCHARGED BY AM TO 38 ASTT, DEP. LAND SEC.	Sasti per 1989.	FEG. 17		CONTRACT		
2000		\$ 27	DXHM519-135.	DISCHARGE CHARGE DISCHARGE IN 1135	1235/	ASST. DET, LAND REG. JOHN
97233 Actrement		22 (12 88	PIRESTONE, David Morgan	CANADIAN INPERIAL NAUK OF		Amending Mortgage 651,771
***	4.6			COMMERCE		
STAN CL ANDERSON		1 00 ca 30	TIRESTONE, Davin Morgan	CIDC AURTGAGE LUNFUKATION	31,450,050	. P.s. a v. des. as pt. 1 on 20k-2752
Tooling to the second	ě,			1	-	(43000)
ESTACO FOR	****	30 65 83	ZKO INVESTAENTS LIMITED	200000000000000000000000000000000000000	\$295,389.	Part des as Part 2 on 2018-2752 & OL
		7		WILDEL, Raymond		The state of the s
	· ·			MARKOVICH, Indre		William to the first the control of the section of
,	1		Section 19 to 19 t	The second representation of the second seco		
	-				(	\ \ \ \ \ \ \ \ \ \ \ \ \ \ \ \ \ \ \

BEGISTRATION NUMBER	SWEAT	Date OF	REGISTRATION	GRANTOR	GRANTEE	CONTIDERATION	LAND AND REMARKS
sed.	Const. Lien by 699641		18 07 88	ITAL STORE FIXTURES LTD.		\$36,120	Part (559237)
1	desalt - ya desal	HEAD ASST DE	DEP. LAND REG. #	The state of the s	מדעועונים: זוועי	000 (040)	יים ני אונה מגרפטנוטה (ממכפספי)
699641	Release		5 08 28	ITAL STORE FIXTURES LTD.	DYNASIS INC.	\$36,120	Const Lien 696974
Tiens.	Court Grade		69 10 12	200			Dis of Comst Lien # 631506
	1		Year/Month/Day	ñ = 0 = 1 = 1	0.00		Vacate Gert of Action + 634482
1	30000000000000000000000000000000000000		91 20 69	DEALKTEST INC.	THE TUROHTO DOMINION BANK		F. 159865
713665	Charge		89 03 03	FIRESTONE, David Morgan	CANADIAN IMPERIAL BANK OF	\$1,450,000	Pt & OL des as Pt 1 on 20R-2752
					COMMERCE		- 1
10433	de st	20	Se co co	Directo time.	משמחבב וחובסיחבאים בים.	.000	(656760) 7,152
		}	VIEW CAN	The state of the s	The second of the second of		
1:9:24	Lindres		6 50 68	SIMTONS, ENIG LIEWEILYN	SIMMONS, Indias Haughton		rare with E
			14.6	Estate			2nd'ly: Part (32113) .
				WAGHORN, Rusemary			
				SIMMONS, Gregory Thomas			
030262 - 24	Charme		89 10 13	Met 1941 Autor Singh	CANADA TRUSTGO MERTGAGE COMPANY	90-960-65	Nart with exp (653680)
		5%51.5% * 1.3 V.3	COHMILE OF 631385 ASST. DEF. LAIL IN S.	1			
744985	Transfer		CE 50 06	SIMMORS, Thomas Haughton	RIVER VALLEY PLAZA CORPORATION	\$344,962.	Firstly: P. With Exp
							Secondly: Pt
744778	Cnorge		90 05 30	RIVER VALLEY PLAZA CORPORATION SIMMUNS, Thomas Haughton	SIMMUNS, Thomas Haughton	\$600.000.	(719124) Firstly: Pt With Exp
							Secondly: Pt
			*** 4:5	->			(7/9124)
7.3635.7	Charge	**	90 05 30	RIVER VALLEY PLAZA CORPORATION	897276 ONTARIO LIMITEĽ	\$200,000.	Firstly: P? With Exp
							Secondly: Pt
							(719124)
74623E	Ass-gnament -		61 90 96	THE TOPENTO BOMINION BANK	SCALMYES! 1NC.		se: Charge 899487 A
746237	Charge		61 90 06	DYNASIS INC.	FEDERAL BUSINESS DEVELOPMENT	\$750,000.	Pt With Exp (532969)
					5ANK *		61
145235	2511.15		96 96 56	DYMAGIS INC.	SEXTRACST THE.	\$125,000.	Part utu 280. (552'59)
7	DICTION ED B	TO THE TANKED BY . 153433 ASS	T REP. LAND NEED			ş	Maria Santa Sa
746326	Transfer		90 06 21	FIRESTONE, David Mongan	FIRESTONE, David Norgan		Part Ol des as Part 1 on 20R-2752
					FIRESTONE, Bente JT.		7
749720	0يرتفر		90 05 21	FIRESTONE, David Morgan	FIRESTONE, Anna Jewel		. Part. OL. des As Part 1 on 208-2752
			- 14	, i			

STREET, A	NETRUMENT	Daily artist	DATE	GRANTOR	GRANTZE COMBI	ביכ	LAND AND MEMARKS	
	Patent	23 Aug. 1810	1	Grown	Daniel Clark		All. 200 acres	
N OII	B. & Sale	& Sale 24 Jany 1317	15 Mch 1817	Daniel Clark	Charles H.		3 8	1
332 P	B. # Sale	B. A Sale 6 Feby 1844	30 Sept 1845	Charles Biggar & wife.	Test of water		,	
e 664	B. & Sale	& Sale 7 Jany 1854	12 Jan 1859.		118891		Ft. 10t 20	on R
580.3	Yorksage	. Jan. 1854	1 0	James L. Diggar & wile	William Kaitting		Pt. lot 20	On N3
78.0		3C Nov 1858	2 Dec. 1858	Charles Rivers	חלמוכט זיי מוקדמו	6	T.	S TO
				TERRITO CATTER	Emily biggar, Midow		lot 20. except 35 acres	165 ac.
ـــــــــــــــــــــــــــــــــــــ	رن در در	ال الله الله الله الله الله الله الله ا		i				17
	מ מו	4 dar: 1997		Charles Biggar & wife	James Brodigan		Pt. Lot 20 10 ac.	on N₹
i i	200	Act Sand	6 Jany 1853	4	E=£1y Biggar indem \$200		Pt 10: 20/445'd 44559	* 第
	36	1901 (380 )	co Dec. 1901	vames L. D. gat	William Kaitting	Ī	Pt. 10t 20	on Na
	Mort.	54 56 S		4 :4 :4 :4 :4 :4 :4 :4 :4 :4 :4 :4 :4 :4				
	Cortesse	23 Dec 2001	10 Jany 1862	William Keitting & wile	John Taylor	-3	1 36 20 - 41 atel 136 17.	1
332 0	Will	19 May 1860	28 Jany 1862	Charles Biggar	to be sold at Emily Biggar's		Front part. 166 ac.	
11	10 15558				death.			
	Yout	2 June 1864	14 June 1864	John Taylor	Samel Saith		Pt. 10t 20	*
329至	3. E Sale 1	11 Dec. 1867	5 Feby 1868	William Kaitting & wife	William S. Bowbeer	"	Pt. 1ot 20	1 1 2
136 3	Dis of 6	6 Jany 1862	18 Meh 1862	Samuel Smith	William Karting	1	1	tv T
	Mort							2
711 H	B. & Sale 6	6 June 1371	3 Aug 1871	James Brodigan & wife	John Rorke	1	Pt 16t 20 10 20	-
712 #	ozegaze	6 June 1871	3 kug. 1871.	4		9.0	1 to 70 10 10 10 10 1	{
— н 69/		25 Oct 1871	30 005, 1871	George Allen Bounes & w. f.s.				れた
317 H	B. & Sale 2	Sale 2 Oct. 1871	1371	13	George Allen Howhen		6	ΣĨ
7 97.7	Ms. of 7			William Brergon Kellw			Ft. 10t 70	
					1000000		4 fg/ c.iou co 301 -5	
32338	Vortgage 1	491-1881-	6 Apt. 1501	John Rorke	Mary 5. Carterell Sp. novin		1	
3177	-	10 May 1377	27 Neh 1885		Service of the service of		138	\$ F
	Mert.					-	to tot 20 10 ac. Nort	712H
13113	J	13 Mch 1385	27 Mch 1885	Mary R. Cartmell Sminster			1	1
	1					14	rt. Lot 20 10 ac	1
1 5534	fils. of	4 Get. 1285	12 Oct 1885	Ently Clime, wife of	<i>p</i>	-	4	
\	York.			Hiram Cline (Spreetly		/	Some mes	
	eiai			Emil- Bigger, Widow)	James Brodigan	D.	Pt. lot 20 10 ac. Mort	Mort. 101 D
5954	7 Sale 23	2 Sale 23 Mch 1885 1	12 Oct. 1885	John Rorke	Anne Halliday. Widow \$500.	+	20 10 ac.	
Note of		-						
4.0	The state of the s		Control of the Contro	Company of Company	See All Sections of the Section of t		THE PERSON NAMED IN COLUMN TWO IS NOT THE PERSON NAMED IN COLUMN TWO IS NAM	1

AM. D. S.

CONCESSION

20

LOT

(Trafalgar)

1 N. D. S.

William A. Bowteer Sissbeth Ann Bowteer 100 acres 100 ac	MCSTTATION INSTRUMENT	MENT OATE OF UNSTRUMEDIT	PEGISTRATION DATE	GRANTOR	GHANTEE	CONTIDUATION
Toeed & Jany 1899 28 Jany 1899 William A. Bonchen, & Wile Standerh Ann Bowcer.  1 * Sale   1 Wch 1895, 9 Wch 1900 Mary Pettit, Widor. Ann Wchiben Act of Dancan Man Wollsben Act of Dancan Molibra. Ann Bowcer. Widow.  3. * Sale   1 Api 1905 \$ Api 1905 \$ Nisabeth A. Bowcer. William Douger of John Bigger wife of Robert D. Bigger wife of Robert D. Widow.  22 Instrument 12 Jane, 1912 23 Aug 1915 Flora Mailida Chiebolm. William Alexander Chisholm Govisses mader last Will & Sestement Govisses mader last Will & Sestement Govisses and Contact Mailida Chiebolm. William Alexander Chisholm Shower Kerr Chisholm, deceased.  22 9. * * * Sale   1 June 1915   29 Aug 1915 William Alexander Chisholm Shower Mary Chisholm, Govisses Mailida Chiebolm, Govisses and Contact Mailida Alexander Chisholm Shower Mary Milliam Alexander Chisholm Mary Milliam Alexander Chisholm Mary Milliam Alexander Chisholm Mary Milliam Milliam Alexander Chisholm Mary Milliam M	******		28 Fame 1800	132 11 1 4	I	
Toed 26 Jany 1899 23 Jany 1899 William A. Bosteer, A wife Eliasteth Ann Bovbeer. 21.500.  The Sale 1 Men 1895. 9 Men 1900. Many Pettifi. Midor. 21canbeth Street. Midow. Ann Mediabon wife of Duncan Modified Many Bigger wife of Chine Stages. Midow. 22 January 1922 23 Aug 1915 Staabeth A. Bowbeer. Milliam Douler St. 6000. 22 January Milliam Douler Chisholm. William Alocander Chisholm. Milliam Alocander Chisholm. William Alocander Chisholm. Milliam Alocander Chisholm. Merbert. Philor. Chisholm. Trustee. Trustee. Trustee. Trustee. William Alocander Chisholm. Merbert. Philor. Chisholm. Milliam Alocander Chisholm. Mil			20 vally 10979	WILLIAM A.	Slizabeth Ann Bowbeer	Pts. lots 19 & 20 & other land
P State 1 Mch 1873. 9 Mch 1790. Mary Pettit, Widor. Sitsabeth Ann Bowbeer, And Mchom. Mary Bigger wife of Dancan Mchibon. Mary Bigger wife of Bohart D. Bigger wife of Robert D. Bigger wife of Mary Bigger wife o		* <u></u> -		The second secon		1,00 acres
# Sale   Mcr 1875. 9 Mch 1900 Mary Pettif. Widor. Sitsabeth Sireet. Widor. An McGibbon affe of Danca McGibbon affe of Danca McGibbon affe of Danca McGibbon. Mary Bigger Arts of Cohn Bigger Arts of China Bigger Arts of C	-			William A. Bowbeer & wife		All estate, right, title & interest
3. # Sale 1 Mch 1875. 9 Mch 1900. Mary Pettith. Widor.  Ann McGlibon Adle of Duncan Many Engages and McGlibon Adle of Loncan McGlibon Adle of Loncan McGlibon Adle of Sale of Dincan McGlibon Adle of Sale of McGlibon Adle of Sale of McGlibon Adle of McGlibon Adle of Sale of McGlibon Adle of McGlibon Adle of Sale of McGlibon Adle				the factor of the second of th		
1 # Sale   Not   1875.   9 Not   1900.   Mary Rettift, Widor, Ann McGibbon wife of Dincon Modifian Mary Bigger wife of Dincon Modifian Mary Bigger wife of Baber D.   17   17   17   17   17   17   17   1	-		=	And the second s		land, 100 acres
Ann McGibbon safe of Duncan  3. # Sale   1 Apl 1305   5 Apl 1905   Elizabeth A. Bowbeer.   Milliam Dowler Dowler    5. # Sale   1 Apl 1305   5 Apl 1905   Elizabeth A. Bowbeer.   Milliam Dowler    6. **Committee of Milliam Alexander Chisholm    7. **Committee of Milliam Alexander Chisholm    7. **Committee of Milliam Alexander Chisholm    8. **Committee of Milliam			1	Mary Pettit, Widor	Elizabeth Street, Widow.	All her present or future estate.
9. F Sale 1 Api 1905 5 Api 1905 Slicabeth A. Bowheer.  9. F Sale 1 Api 1905 5 Api 1905 Slicabeth A. Bowheer.  9. Esger wife of Robert D.  9. Esger wife of Robert D.  9. Esger wife of Robert D.  9. Api 1905 5 Api 1905 Slicabeth A. Bowheer.  9. Flora Matilda Chisholm.  9. Milliam Douler  9. A Sale I; June 1915 23 Aug 1915 William Alexander Chisholm dages H. Fuller and Sit. Coo.  19. P Sale I; June 1915 33 Aug 1915 William Alexander Chisholm dages H. Fuller  19. Puller and Sit. Coo.  19. Puller and Sit. Coo.			2		Ann McG-blon wife of Duncan	right, title and interest in those
3. ± Sale 1 Apl 1305 5 Apl 1905 Elizabeth A. Bowbeer. Milliam Dowler 54.000.  22 Instrument 12 June, 1212 23 Aug 1915 Flora Mailide Chieboln. William Alexander Chisholm devisee under last Will & Testament Chisholm, deceased, and 1915 7 Aug 1915 William Alexander Chisholm deceased, and 1915 7 Aug 1915 William Alexander Chisholm deceased, and 1915 7 Aug 1915 Trustee Trustee Chisholm, deceased, and the chisholm, deceased, deceased, deceased, deceased, deceased, deceased, deceased, deceased, deceased, dec	1			The second second second second second	McGibbon, Mary Bigger wife	Pts of lots 19 & 20 referred to in
3. F Sale 1 Apt 1905 5 Apt 1905 Elisabeth A. Bowbeer, William Dowler St. 000). Per lots 17 & 20 100 Midow.  22 Instrument 12 June, 1912 23 Aug 1915 Flory Mailida Chisholm, William Alexander Chisholm Recander Chisholm Address and other land devisee under last Will a fastcament Gersee under last Will a fastcament Receased,  23 9. A Sale 17 June 1913 23 Aug 1915 Thustee Herbert, Fuller and \$6,000, Pt. of lot 20 Trustee Receased.	est Fe					O N
3. F. Sale   Api 1905   S. Api 1905   Bizabeth A. Bowheer.   William Dowler   Si. Ono. Pte lots 19 & 20   190   William Alexander Chisholm   William Alexander Chisholm   Front part and other lamped   Geriase under last Will & Pettament   Robert Rerr Chisholm deceased,   Herbert Fuller and S\$\$,000, Pt. of lot 20.   Trustee   Trustee   Herbert Fuller   Herbert Fuller   Herbert State   S\$\$,000, Pt. of lot 20.   Trustee   Trustee   Herbert State   William Alexander Chisholm S\$\$,000, Pt. of lot 20.   Trustee   Trustee   William Alexander Chisholm S\$\$\$,000, Pt. of lot 20.   Trustee   William Alexander Chisholm S\$		7	1	201 X 10 CAS COMPANY OF \$150	Bigger wife of Robert D.	
3. * Sale   Api 1305   Sapi 1905   Sizabeth A. Bowbeer. William Dowler   St. 000. Pte lots 19 & 20   100   Middow. Middow. William Alexander Chisholm   Front part and other land of Prustee   Gerise ander last Will & Testament   Robert Kerr Chisholm deceased, deceased, william Alexander Chisholm James H. Puller and St. 000, Pt. of lot 30   Trustee   Trustee   Herbert, Fuller   Ministration   Mi	¥			1	Bigger.	
Midow. 1912 33 Aug 1915 Flora Matilda Chisholm. William Alexander Chisholm Front part and other lar of frustee ander last Will & Testament Robert Kerr Chisholm, deceased.  9. * Sale 15 June 1915 23 Aug 1915 William Alexander Chisholm James H. Fuller	ពាំ		5 Apl 1905	,	n Dowler	Pts lots 19 & 20 100
of Trustee  Of Trustee  Adox, Executrix \$\frac{\pi}{2}\$ sole  Adox, Executrix \$\frac{\pi}{2}\$ sole  Adox Executive  Adox Executive  Adox Executrix \$\frac{\pi}{2}\$ sole  Adox Executrix \$\frac{\pi}{2}\$ sole  Adox Executive  Adox Executive  Adox Executive  Adox Executrix \$\frac{\pi}{2}\$ sole  Adox Executrix \$\frac{\pi}{2}\$ sole  Adox Executive  Ado				Widow.		
devisee under last Will & Testament  Gevisee under last Will & Testament  Robert Kerr Chisholm, deceased,  Trustee  Trustee  Herbert, Fuller  Herbert, Fuller  Herbert, Fuller	SIO CZ Instru	ment 18 June, 1912	1915	Flora Matilda Chisholm.	William Alexander Chisholm	Front part and other land.
Gevisee under last Will & Testament Robert Kerr Chisholm, deceased,  9. 2 Sale 15 June 1915 23 Aug 1915 William Alexander Chisholm James H. Fuller and \$5.000, Pt. of lot Trustee Rethert Fuller	of Th	stee	3.	idow, Executrix & sole		165 acree
9. 2 Sale 15 June 1915 23 Aug 1915 William Alexander Chisholm Janes H. Fuller and \$45,000. Pt. of lot frustee Trustee Herbert Fuller.				last Will & Testament		
9. 2 Sale 15 June 1915 23 Aug 1915 William Alexander Chisholm James H. Puller and S6,000, Pt. of lot Trustee Herbert, Fuller				isholm, deceased,		
Herbert, Fuller	m			William Alexander Chisholm		Dt 00 10t
	1	,				
	/					The second of the second secon
	/-					
		/	+			
	-3-50					
	t		/	50.00	Control of	A STATE OF THE REAL PROPERTY OF THE PERSON O
			/			
					The second secon	The state of the s
				/		
		4 '44		/		
					/	The second secon
	****			n: R		
						The same of the sa
						/
	•					the state of the s
	1				the same that the same that the same to the same that the	The particular is a second of the second of
Company of the contract of the				and the same of th		The same of the sa
						The second secon

CONCESSION

See to the state of the state o	19052 "	NASP BUREAT	TANK OF	BATE OF SUCCEMBATION	GRANTON			
A material of the state of the	- 6754	A	36 days	3	, i	THEND	COMMUNICATION	REMARKS >
RED IN FILL CREATE AND		6	- [	4	The same	T.	4	100c. 100. L.E. 45
See of the second secon					in the design, wine,			
See Dis Fruit Comment of the Comment	7656		Sylano	and day	ye millings.	A TOTAL CONTRACTOR OF THE PROPERTY OF THE PROP	1	
The same where the same was the same with the same was the same w	A Sec.	A			1	The Man of		-
A who we will be a second of the second of t	- Jones	Kack	Á	Berney		BISDACTIC		**************************************
Se some alone of the second of	100	DED IN F.			Olo	S. Carlotte		- Ct. 4.C.
A man warm to the first of the	2000	- Marie	Cours	Sychon	The Later	tame" park.	2 miles	
Government of the second of th					and of women of large.			frank in the second
Age when the plan the graph of the plan	*****	1	rotoms		Hour Son Learn & Park	0 4		
Get Smarre who, man Ma- 18 2 in face of the smarre of the					" dely, goliano	Britis Luis	1	. rec. less.
Let Smins absent Paring by the following the paring of the		200	138	Change III	Re- Sharing Go	- when jie time		7777
Sur Smarrs reducers, Parament for freeze, of the sur sur freeze, the s		***	- cucrofp	out-date	grant of the	allinia Town	1	
Of MILL STATES STATES AND THE STATES		7	Arres		Series districts	no of many frame	100	
Com to yours of yours to go as to go as	7.0	Kerry				- July Care	30	rice paris
Exten 69 yrs 20 yrs Regin	T PCORE	THE BUT	L ICELLAND	D_0	Security .			
gar na		1	Gynes 2	-		7-6-1	20 00	DATE.
_		Agree na	7	Per IIs	20 - 1950			

	PAG
NOBTH OF	THEFET
_	1
	CONCESSION
27	
Q C	>
5	3
TOWNSHIP OF TRAFAILERS	TOWNS OF THE PROPERTY

4			-				
250	N ST	"Almo	25 Change	To expense and expense	7	3 A	
- 1	Sy Kel	יופיינשו זוי	23 62 4.00	to come a ly Line 195			
135-15	A K	«X-chair	Kacheny Gydasy	To permete for the extension	te thirty or a cont		
4 / 1 / 1 / 1 / 1 / 1 / 1 / 1 / 1 / 1 /	Se X	Anyone	1 Galase		- 15.		A constraint and the constraint
Jense La	7	5 miles	of an	A mile	Three Bule & Bule	1	Per 65.30.
++		-	34	cue, my of when	Bulen to wigh, -		-
23. Jisec	1	Survey	Fryns 1 May 120	acus Kine Dane	ann Grain Grafferi	N	
23512" 56		Sacration	-	and the second contract of the second contrac	May	2/11/12	Jan.
NOT RECOMOD IN PURL	붎		V		uale.	10-200	
2316	2.22	Strate .	in fr	A	Goloca II. Gorandia		The state of
31.2	*	dines	mingu	account from Interior	are relieure Burne	A.	2 fees 6
Jane 1	1	and,	Suche	and relieves Freeny the	no certification. Princeton. 8	1	1
1	. -		d	the the the of them of	General Son Francis, La		يعد بعدا
1.24st X	8	The state of	Suite	Greenini Louis	de la prince con contraction of the contraction of		30/4/7/
-	-		2	Same to June , de sail	Course do 1	*	

CONCESSION

		1.6					1 4	न	9	5 .		ï	.] ,	11:	1 3	· 1	. 7					_
REMARKS	Ce Leva win	Se lie se l	Laupzine		Samuel Control	Chesa de	The same	concer, and	Cate time Note 666	1000		مروده و	1		100' 40 100	A 6000 Au	100	Low Carlo	100	24- H-C1 OW		
MOILMANDENCO	1. Ca . Ca	27.9579		1		110.652	23.52.24	3000	-	7	A. Care				Sec. 150	1		Ì				
GRANTEE	and active in Property	Grande of President Line			Buton de ten	the Royal But with	Lancas	seining gen general	The factor of the same		LIMP.	7 . 7		DIST /// 332	¥.	A STATE OF THE STA	7 6	DISID LILES &		Carried Carried	* Charles of	7
NOT THE REAL PROPERTY.	Burgan In Keek		ip , Liene & Turn	Reserved to the second		Your Bours	whose the handle					66	1000			wining gangament	200	- Single State of the state of	Ų		1 - 1 - 0 - 1 - 1	
BEGINTATION.	TE 16 Sharte Straters	Same	7	3409.		"Kayess	d	35 Cherrie				100000000000000000000000000000000000000	1			35 35 GENTE		4	Z	-266000		
Mar voncer	ST. Same Chick	-walen		attento 3	-	100000	-	Sens.	40.00	-				-		- Secres	-	-		Sugar	,	
-	X	4	į.	Y .		Speck		The second				NOT RECORDED UN FULL				more indeen	E IN FIRST			7.0		-
22240	******	65/73		"TICE ALLE		Total.	4	23644		7		DOT RECO		-!		2091	THE DESCRIPTION OF THE PARTY.			_		! -:!

REMARKS	91.21 33.57 1.50 1.50 1.50 1.50 1.50 1.50 1.50 1.50	(10) (10) (10) (10) (10) (10) (10) (10)	Aletten.	( 80 5	
Why Janah R.	and will the man	1/2/2019		1	
Cat. of What Neils	Part Material	Shirt of the	Ly for		
Tr. aller Jacopas	A Salat Can	The same	the state of the s		
recommon James	The Me Collect	Wy Wo Park Will	they the deller of	SELECTS TO THE STATE OF THE STA	
Control of State of	10 123 Central 20 10 10 10 10 10 10 10 10 10 10 10 10 10	The Mo	1058 Ly Pen Stangitos 1 English	ATMISSANTICE TO THE TRANSPORT INC. THE TRANSPORT INC. THE TRANSPORT THE	

FEMANKS	tastil let	aller at	216 Les ett but	5 6 1906 110 56 827 31 5 8 22 134 14 1222 56 14 14 300 14 12 19 10 14	Carried and the Control of the Contr	816 201 CON 47	de des 266 655	13886 A. deces	3/4/30	another lot	tis d = 138854
CONSIDERATION	15%	12/2	1 5	6 W/4 W	162.96	1245	000 11 902		123000		Lon State
GRANTEE	ed lest	Aut Hothow Ille	dobre Survellments		terra Part it Model Surve	States manied Homan	State Investigate Low Tol. 78 11 11 11 11 11		Cather Cofustion	Holango Similar and	Yot Hally Construct
GRANTOR	Me English my mainen	Horbort & Juthe	Hofume Marie Machelieri		tobrachustments	dolta Innestmento	Calignas Developments	Quity for the of the	they is a lightent		distant plants and the state of
MC65714700	かんない	mohan	dhe		What they	S. Coffee	Significant of		Margis Op Jours		
11 H	Shapar 11	Carlingue Congression	a inwester		a hierage	a Ghillers	G in		Chullag.	i	1
1	the way	1	chant		The state of	Grant 3 Chiles ve	But State of		Holeson !	£ 710	<del>                                      </del>
9577	507	Layoff Lay	266633 Grant 3 murges	>	State of the state	78487	1		Din Bully Charge	**	<u>7</u>

	-
-	

<b>GENTLE</b>	4021	1000
REAL TO	THE PLAN	1000
1	-	13759
-		- 10
	-	2

	T. Total	error de
J	11/1/2017	1125
-		3
	-	

		7		Ţ	j	100	)	1	10	J	7

ŕ		
O.		
PAGE	M. 14 20 . 40 . 40 . 40 . 40 . 40 . 40 . 40	
	2	
NORTH OF DUNDAS STREET	mustact for Smooth for	
-	Est-au Sumber Consulted to Manuel to Consulted to Manuel to Consulted to Manuel to Consulted to Manuel Consulted to Consul	
CONCESSION	Developmente Developmente Developmente Emitedo e Gula Environ es estato Environ estato Estato estato Est	
O N	Series of Series	
LOT	29 Chieses Recentarios 29 Chapters 1 Thayless 1 Chapters 1 Chapter	
TORNSHIP OF TRAFALGAR	269572 Wetgagealffergory 70 269572 Wetgagealffergory 70 269572 Wetgagealffergory 70 70 269572 Wetgagealffergory 70 269572 Wetgagealffergory 70 200335 72 200 200 200 200 200 200 200 200 200	
301		

• •

CONCESSION

			1,30	· *		5110	1
REMARKS .	distas	Rent To 12	The section of the se	Post as Con fr	2117 NE 308 854	State State	123 20 20 annie) 24 m. 83 0 45 25 0 48 90 42
CONSIDERATION	4300	1306	James J.	24.2			10
GRANTEE	141969 - tehastes Pras	marries of Hard Lisburk	A lack of ma terries	Freduich A. Hendream and Parth & Hendream		14. But Lelliams	Elmon my Teller done this way, from the work
GRAHTOR	1999 9611/18 To weign that on the 194 1141/19 - lebastes Areas Little & Aletonic Ellert, so givent tenante, more	Seller Insutto to Kinter	thread lonken thethere	1911/16 February Hilliam Fuller		Leatutory Beelmotion to But Lettions	and Buth of Henderson 314
PIGGSTRATION.	902039	1900 90	Harm.	ह.दूर्फा		18 3 bim	18 £ 1 mm
MATERIAL	Hirob	130 180	right	Kgarsmy.		-£8/ F	
14.5TBUMENT	at of 12	On the second	Line de la	trails.	11 1 0 1 12 1 1 1 1 1 1 1 1 1 1 1 1 1 1 1 1 1	P. 4.3	Add I
251325	282231 Las of 128 9 06	3000	# 35	33/025		33.00.6	99,027

372.105 Junt 300 from 26 Better Developments 272.18 & Ontanis Jets. 26 E. 39 19 19 10 19 19 19 19 19 19 19 19 19 19 19 19 19	Parage a	Casthunabi	DATE OF LAST TRANSCRIP	DATE OF PEGETERATION	GRANTOR	GRANTER	COMPIDENTION	REMARKS
Thotaga 23 (21 1735 (21 1735 278 1 4 4 Contains the form that the form the form the form that the form the form the form that the form the fo	7102	Liant	samples.	26 (30) 1979	Be-an Developments Limited and Keeking	1	340	14
Though 23 Wash 1973 278 (4,4 de Sansaturato 100 Berrelo francia 100 Control of 10	,		1		Developmento Limited		500	" " But 481"
Thirty of the 1875 fell of fine of the continue of the fine of the file of the				,	and thefor Anivestments	*	-	AC 2,043'612"
Thousage 23 Ce 1 1737 & 278 ( 4 4 . Ontania State Ber- Ow Benefichemma 28 12 2 1 1 1 1 1 1 1 1 1 1 1 1 1 1 1 1			-		Limited under style		*	33 × 1 25
Thousage 23 Chins 2781 44 Ontanie of the Bor- De Berelopmente 188 120 Chief School States of Contanies of the Bor- De Berelopmente 188 120 Chief School States of Chief Chief School States of Chief C		- 10	(4)	*	of B. G. S. Investments		18 Jak	1211/12 208
Though as the Marie State of the Second State of the Second Secon			Ti i	7			700	G. 2111 15 10 10
The topologes 3 2 1 1 1 2 4 Cotton of 4th Born Da Bene Carponnate 188 1 20, 1 1 1 1 1 1 1 1 1 1 1 1 1 1 1 1 1 1 1			*	-			NWGG	7" 8 WW 7/5'L"
Mortgog 23 B1 1732 & 178 1 4 4. Ontario of the Born Barrelogment of grants of and Keater 1989 22 2 2 2 2 2 2 2 2 2 2 2 2 2 2 2 2 2	7	100	1000		The second secon		NE ASO	KN 150: 14
The Holl of the Contract of the second second header of the States of St	-ior	4	230-1973	Laters	2781 44 Ontanis Ltd.	Ber On Assessant		0.787
This grant of the forth of the same of the				1	200	Limited and Kenter	1	13 Let 20 Jam.
The fifth of the formal bankon for and hay herestment of the fifth of the formal forma				1		Exvelopmento Limited		14 10 10 10 10 10 S
The first 3 for 177 5 th 177 The Carles of Standard Lies of Control of the Standard Control of the Sta			9	1	1	Chip		and coverant
Minger 1 though 5 the 187 the Content of the state of the	34.2.2.3	1	116	010	- / 6	temited		The same annual of
Mingry 14th 1171 57th 117 Ple Bend of More Lotting House of Many Parties of Ma		200	Luca D.	The street	poster !	the that the fact was	2// (444	Pet 120 Come
Minger 1 to 111 5 to 111 Memoria lander Madera 11 to 11 to 11 for the light of the state of the					mingrate Jana Language			The state of the s
Mingry 14th 117 37 blots Manual Genden Madera Cold to A Marty Low the St. J. J. S.	-						11.00	mark delight
B. M. 37 Hours 5 hiller The Earl & by Mine diete franch de hours & Sandana Stranton & Sandana Stranton & Sandana Stranton & Sandana Stranton & Marie & Marie & Sandana Stranton & Marie & Sandana &	3623	- Ladina	Will Hit	Jahm	Enley	200 Pr. 11 P 71	100	
1. 1. 1. 1. 1. 1. 1. 1. 1. 1. 1. 1. 1. 1	-	0			Dry .	Jest 44 3493	9	
D 417 1978	315537	100	71 0 HR	18/19	The Stand of the Stand Stand	themand han him		26.00
1 (1) (1) (1) (1) (1) (1) (1) (1) (1) (1	\	1	. 1			autora funta		Served to many
10年十十二十二十二十二十二十二十二十二十二十二十二十二十二十二十二十二十二十二十	13/11/2	P. 1.		F. inn	The Park of More Lottie	theund they have		A SKY KI
1 1 1 1 1 1 1 1 1 1 1 1 1 1 1 1 1 1 1	13	1.1	, ,		1	Burbara Sonbaro		
- Continue of the second of th	-	100	100	The P	the Kayet but of blance	Guzad Broken and Calein		Jur 30393
	-	-	-			Broken		/

NORTH OF DUNDAS STREET

CONCESSION

	ž.	16.5		1 as
TEMARKS	The state of the safe of the s	12/12/200000000000000000000000000000000		# 276.05 with an formated as 1877-5020 Close and 200 Close of 1877-5020 Close and 200 April 28887.
CHARLDGRATION	23.5. 25.0.2.2.2.2.2.2.2.2.2.2.2.2.2.2.2.2.2.2	20.08%	6220	47-5
GRANTEE	d House : + Theline		) B	He Sustant Kints, C.O. E. Grown Com. (47-5000 Com. (47-5,000 Com.
GRANTOR	398167 Ehrent 13Ang KW Bother Kin Transporied C. Handragen. Konord.  19 And L. Handragen. Roll House  19 18 18 18 18 18 18 18 18 18 18 18 18 18	1975 Donald Howas & Teleno House as just the way of the sold of th	1978 Bullyment Kintol Keller 287024 Ontain Riving 1978 Bullyment Kintol ged Light Son	18 gales 9 gales a. Albrander, 0. L. S.
DATE OF STREET OF	Hagain Land	1975 1975 1976	1928 1928 1938	100
Date Of Land Co.	ENT 13 Am RW S	3 42 4 1 1975 ( ) 1975	लेंद्र ले	126
MAN BURNELINT	Enund O. 20	R1880.	Gras.	ly Phin
***	B Files	429883	42887 Deed 25 24 24	A. 19 64.000

PAGE 13	1 年 1 年 1 年 1 年 1 年 1 年 1 年 1 年 1 年 1 年	
133	27. 6. 6. 6. 6. 6. 6. 6. 6. 6. 6. 6. 6. 6.	
NORTH OF DUY DAS STREET	Converse dans dans dans dans dans dans dans dans	
CONCESSION		
D & G	12 Lang 2 27 2 2 2 2 2 2 2 2 2 2 2 2 2 2 2 2 2	
TOWNSHIP OF TRATALGAR	12 24 20 20 20 20 20 20 20 20 20 20 20 20 20	
(MO2	###	

	એ	٨	7		. 1	
REMARKS >	300	A COSTON PRO	2)-dat 80 m	diving to	Children 3830	04. U. 80 deays as Pados, 748 on 200-3899.
TOLINED GREEN	\$2.4 6.44	100		Part trail	1000 THE TOTAL OF	33 3
GRANTEE	Substitut Evelypment.	eithra, Invitanta Lumited	Alderia Gerlagments Stanted	Alegaria Benelopamento 1 Fulmitas	The state of	at Setion and Communications Thous Col In the matter of the Minister of sontherications of Alpenson and Rev. King's Highway 5
GRANTOR	Maring Hardel	April Maril Madelume Haler, mariad umman	Kumitel Kamaman	Justice Mercano	Ambon Landon Barbara Ambon Junation Constant	Ministry of hacissus of hacissus of an application of the separation of the texporate of the texporate of
SATE OF SECURITARION	20/100	to Cara	Poling (M. b.)	40 Churs	404	18 gan
DATE OF INSTRUMENTS !	Out of the	3 dug.		18 Clust	15 Papel	13gen.
mest achieves	P. Just	A Court is de	N and	114375 18 Cho 507576 1978	HAMISS MAN 15 BE	374-18.
****	HEEREG IN MAN	# E6 23 Et	435593 N. Chiu	12857	440453 Mat	148905 (26 4 13gan 1 (140000 1) 1977

CONCESSION

رر	

	•
--	---

اسر	T.

po	

<b>D</b> "	

1	•	

-	0	1000

-	•	100

7	•	1785

-	•	600

<u>ب</u> بو	4	789	
PAGE	1. (2916)  1. (2	A Sold lies	The R
£-7	COURTINATION VISION VIS	The Holosophia Sanda San	P C C C C C C C C C C C C C C C C C C C
NORTH OF DUNDAS STREET		And Market Land Land Land Land Land Land Land Land	3
yand.	Minem P The Sales	37.C. 22.C.	The state of the s
CONCESSION	The state of the s	12 C. 13 Sanda 17 17 17 17 17 17 17 17 17 17 17 17 17	
<u>پ</u>	28.22 & Ques	La Constituted to the state of	A A SECTION OF THE SE
20 Ed.		The State of the S	
AFALGAR	Alle With To Share 1978	1979 3 3 1979 5 2 1970 5 1970 5 2 1970 5 2 1970	676
TORNSHIF OF TRAFALGAR	318 Hely 226	54 357 3.11 548 750 O. m. 2 11.34 "2 2 1.10	SHOWLY CHECKES
F	## ## ## ## ## ## ## ## ## ## ## ## ##	R 1 3 2 3 3 3 3 3 3 3 3 3 3 3 3 3 3 3 3 3	tires
• (			• • •

TOWNSHIP OF TRAFALGAR

20

LOT

CONCESSION

-	a manufacture of the second se		Market Street Control of the Control
520224 Final 5 Mcn. 1940 10 Ap	1. 1990 287024 Ontario Limited	Marsco Developments	Foreclosing on mtge. #259572
Order		Limited, Ro-ar Developments	Y.
Of Scretosure	B-0-1/60	Limited, Kesher Developments	te:
et et		Limited and Shefa Investments	
•		Limited c.o.b. as B.K.S.	
		Investments	***
	Plaintiff	Defendants	***************************************
×	Marsco Developments	Bo-ar Developments Limited,	
	Limited	Kesher Develonments Limited	
n retā	TVIAL	and Shefa Investments Limited	
£ -	12	c.c.b. as 3.K.S. Investments	челу
	-	and 297024 Ontario Limited	
6	Plaintiff by Counterclaim	Defendant by Counterclaim	
History Copp. 1945 1945 19 Apr.	- 1940 - 237924 Onterio Maisod	Narece Bevelosments	Vacating #134006 & \$1.51051.
רבי בֿמבֿבּי ביינבּ		Limited, 30-ar Developmenta.	
		Marited Keker Developments	
		Thistod and Thefe Investments-	
		timited crocks as bakes.	
		Investments	
	- Ilinita	Defendando	-NIE
	Marsto Develouments	Borat Develonments Limited.	72.02
	ministed	Mesher Developments Limited	1000
		and Shefe Investments bimited	22.21
		c.o.b. as B.K.5. Investments	
		and 297024 Unberts Limited-	
	j		6
ì	STATES OF THE PARTY OF THE PART	Linited—	
10 0 0 0 0 0 0 0 0 0 0 0 0 0 0 0 0 0 0	1981 Serie M. Firestone	Her Majesty The Queen In \$2:90	96 Pt. lot vic. designativa as Perb l
	TOWNS OF THE RESERVE	40	
MCSOFLAED		National Revenue (Taxation)	
AUG 14 1380		200	

1000

Pod

Deed Company					
70 20 20 20 20 20 20 20 20 20 20 20 20 20					Character and the second secon
20 00 00 00 00 00 00 00 00 00 00 00 00 0	· ·		-	The state of the s	
x 08	- 100	15 12 33	BOTHAM, Howard	DUREEY, Wary E.	52. & c Pt. Somm. US limit rd, all. bet.
1977; 1008	<del>रा:=!s==</del>		BONEAM, Barbara		d 21, 732,51* "g
90 60 10 10 10 10 10 10 10 10 10 10 10 10 10		4.4	-		S corner; Therce 75 150' 78 150'
3 60 1111					S'4 150" SE 150" to 70, of c.
Bon Lier					
Bon Liter					20,000
Son Liter	ing thanked tradedade	27 05 33	DURKEY, Marry E.	HPRDENC, Herman P.	さんなるのか こうちょう ちゅうはん 一人
	10 × 0 × 0 × 0	28 09 84	FIRESTONE, David M.	Admor Company Ledge-	4,219,27 Pt & Oh des as Pt 1 on 201, 2752 Of
	- Ander	ġ.,		-	Res Son Lien No. 697419
41478 West		12 04 85	WALKER, Mary E.	Maniaton Teachers' Credit	\$58,500. Pt. Comm. NE Lim. Rd. All. bet.
			We wanted the way	The Missing Control Control And Den Control Co	1042 20 3 21 782,611
			The control of the co		4 1550* 5% 156438 156
£21250 Grant		27 06 85	HALKER, Mary E.	STEMETER, Georg	568085
SZIZII - Morc		27 06 85	STRATEMSIER, Georg	- Address	540,000. as 18 568085 [56] 100 100 100 100 100 100 100 100 100 10
Userarge, by 7 9351		5	נופוער	Sentes Alvahias & Brating	Contract of the state of the st
- 344C	in the second	26 01 86	360	Granden Prombine L. actual	20.000
Jaca' ec cy (1965)				lajntiff)	
		4k b: m	P. H. T. J. D. P. L.	Commerce Distriction Control C	DISCHARGED PT -69253/ASST. DEP. LAND REG.
		15 15 25		AGREE CORPERS CARLOCACTERED	TITE! Discharator Con Line (Con)
				4	Variation Cert. of Action contract
				10.2	
		90		E	(Observance)
	54		ייתכסינאים הניזב ווסוקטי	COMMERCE OF THE COMMERCE OF TH	DISCHARGED FINE 60 75.38 ASST. DEP. LAND RED.
3: 233 K. ve ment		22 02 88	TIRESTONE, bayld Morgan	CHANDIAN INDRESS. BURE 07	Amending Nortgage 651.77
68£727 Not 4a-		31 03 88	MARSCO DEVELOPMENTS LIMITED	COMMERCE DAVIS-MINARU: 10ME CGRP, \$	\$5,539,840, Part des. as parts 1, 2, 3, 4, 5, 6, ?,
77 138 Cu					

8

1 NO.3. Trafalgar

THE TOTAL STATE OF LATE OF LAT	ACC-101000	は 日本の日本の日本の日本の日本の日本の日本の日本の日本の日本の日本の日本の日本の日		になるという	GRANTE	513	
12   58   68   14   14   14   14   14   14   14   1	1	İ		The state of the s	-		The second secon
12   56   66   66   66   66   66   66   6	PACKET AND PACKET	73460855	1 4	FRESTONE, David Margan	CISC WOLLDER CORPORATION		58887
Section 1972  Section 1973  Se		×	;E	HORGINGO TRUST CORPANY	2012101		ļ
STATE OF THE STATE			2		- CORROBATION	2	
THE THE THE THE THE TABLE TO THE		ki ki		MARSCO DEVELOPMENTS LIMITED	DAVIS-MIMARDI HUME CORP.	35,539,840	Pt. des. as pis.
			,		A COLUMN TO THE RESIDENCE ADMITTED	100.00	exception
CANOTING	6	Tuckill Asse Beg.		STRATEMENTS, GOARD	VAN BEEK, Henry	\$1.78,1400	
1   1   1   1   1   1   1   1   1   1					VAM BEEK, Helene Marthe J	£.	
Eburge   19, 450,000   Pt 8.5, des as Pt 1 on 208-2752	A SILEANOSIO	52 W H231 27		BREK, TOTTY	ROTAL TRUST CORNORATION OF		AIT (798.7)
### STATESTONE, David Hongan    CINADIAN INFERIAL BANK OF \$1,550,000, Pt & 50L des as Pt 1 on 208-2752			,	360			ten - e31566-
Charge 39 03 03 FIRESTONE, David Horgan Crindlin HWFRIAL BANK OF \$1,450,000.  Caweere 50 55 27 FIRESTONE, David Horgan FIRESTO	***			•			# 03448?
CONVENCE  CONVEN		25.	yr/mon/day 89	FIRESTONE, David Morgan	CENADIAN IMPERIAL BANK OF	\$1,450,030	Pt & St des as
THESTONE, David Housen FIRESTONE, David Housen FIRESTONE, Bente JT FIRESTONE, David Housen FIRESTONE, Bente JT FIRESTONE, David Housen FIRESTONE, Bente JT FIRESTONE, David Housen FIRESTONE, Anna Sewell FIRESTONE, David Housen FIRESTONE, House General Single-Communication of the Part Land Reg JC WARTHER, Hoteled House Communication of the Table Single-Communication of the Table Single-Communication of the Communication of the			110 1		CLAMMERCE		
FIRESTONE, Bante 3T  FIRESTONE, David librgan  FIRESTONE, Bante 3T  FIRESTONE, David librgan  FIRESTONE, Bante 3T  FIRESTONE, Bante 3T  FIRESTONE, David librgan  FIRESTONE, David librgan  FIRESTONE, Bante 3T  FIRESTONE, David libran  FIRESTONE, Bante 3T  FIRESTONE, David libran  FIRESTONE, Bante 3T  FIRESTONE, David libran  FIRESTONE, Bante 3T			125	FIRESTONE, Bavid Hongen	FIRESTONE, David Norgan		Oi des as Part 1 on
THESTONE, Anna Genel  THESTONE, David librgan  THESTONE, Anna Genel  THESTONE, ANNA GENE							
Certifies	- 1		8	FIRESTONE, David Horgan	FIRESTONE, Anna Jewel	_	vies as
Certifies and Titles a	*** **********************************	17 17 17	20 00	VAN DEEK, Kenny	Lander Life instruct commit	-	1.767.1
Certif iste of 12 72 72 72 72 72 72 72 72 72 72 72 72 72	温温		記録	WASH JEEK, 1.21 SHE TAN COR	TOWNS TOWNS THE PARTY OF THE PA	\$200.0x0.	(CSRC3) -2-
Certifiare  Certifiare  Of 1st 9cc  Land Titles  Act  Control of 1st 9cc  Control of 1st 9c		15/50% test limit		VALUESA, LETERE PER CHARTE			N expenses to the second secon
Certif tare of 1st Very Carl Table of 1st Ver	9		=		JAJIS-MINARSI HOME CORP.		Application Land Incles Application no.
Certifiate of 1st 9ec Land Titles Application No. 1 Now Parsel 20-2, the control of 1st 9ec Land Titles Application No. 1 Now Parsel 20-2, the control of 1st 6ec Land Titles Canada Taust Conduction of 1st 6ec Land Taust Conduction			1.**· F1				Part des as PART 1
Certif 37 Application No. 1 Application No. 1 Application No. 1 Now Parsel 20-2, Land Its less Act. 1 Now Parsel 20-2, Now Parsel 20-2, Application No. 1 Now Parsel 20-2, Act. 20-2, No.			B. J. T.				attacher print
25 .2 35 Wil SEEK rising	11	(1) (2) (2) (2) (3) (4) (4) (4) (4) (4) (4) (4) (4) (4) (4	ñ		DAYIS-MINARDI HOME CORP.	-,-	Application No. 06295-20-348 Now Parsel 20-2, Section T-12
25 .2 35 Wil BEEK HAMP	104	, , , , , , , , , , , , , , , , , , ,			J. A.S		
32 . 22 . 34 . Wil DEEK	1		-	,,,,,,,,,,,,,,,,,,,,,,,,,,,,,,,,,,,,,,,			
SC 22 30 CALL DEEK NEWS	i i i i i i i i i i i i i i i i i i i	· 444.					
	75556 che		92 12 34	Will desir rismay	CARORATION OF	- 124.1600.	Part 29827)

## Transfer/Deed of Land

Form 1 - Land Registration Referm Act

		Form 1 — Land Registration Referm Act	~ (5°
		(1) Registry Land Tilles [	X (2) Page 1 of 2 pages
	7510	9 9 (3) Property Block	Property Additional:
		24929 -	0074 (LT) Saw Schedule
		(4) Consideration TWO MILLION,	SIX HUNDRED & TWENTY-TWO THOUSAND
· ~		* • • A.A.C. A. U. (1) == -2	62/100 Dollars \$ 2,622,458.62
1000	PALTON, AUG	(5) Description This is a: Property Division [	Property Consolidation
2	198 AUG 20 PM 3	Part of Lots 19 and 20,	Concession 1 Trafalgar,
5	New Property Identifiers	MOLCH OF DRIEGTS DEFECE,	designated as Part I on except Parts 1, 2, 3, 4 and
FOR	Addition	E7 34 4 4 4 1 1 1 1 1 1 1 1 1 1 1 1 1 1 1	wn of Oakville, Regional
3	Executions	Municipatity of Nation:	
	Addition Addition	nal .	
(ii	Sen Schedu	C3	
10	Document New Easement	Additional (7) Inte	resVEstato Transferred Simple
	Contains Plan/Sketch Descri	olion Parties Other	
	The state of the s	the land to the transferee and certifies that the trans	
		spouse and I, David Morgan Fire ordinarily occuped by me and my	spouse, who is not separated
	from me, as our family resid	enge. Signwords	Date of Signature Y M O
	FIRESTONE, Bente	よん おんし	CSTONG 1998. 08. 20
	FIRESTONE, David Morgan	J.m. Fire	Tona 1998 08 20
10.5	The second secon		
9	$x_{i,n}, x_{i,n}, x$		
>75	) Spouse(s) of Yransferor(s) I hereby consent t	o lbis Iransaction	Date of Signature
,,	Name(5)	Signa!ure(s)	Y M D
×			
(3)	)) Transferor(s) Address c/o 4950 Yong for Service North York	e Street, 20th Floor t, Ontario M2N 6K1	
(1	1) Transferee(s)		Date of Birth
	SHERBORNE LODGE DEVELOPMENTS	LIMITED	
	in economic transaction transaction to the contraction of the contract		
	Transfer Contract Con		
***	N Tennels and a Address		
	(i) Transferee(s) Address for Service		
	(13) Transferor(s) The transferor veriles that to the	e best of the transferer's knowledge and belief, this tran Oate of Signature	ster does not contravene section 50 of the Planning Act.  Date of Signature
	Signature & Livestone	2 1998 08 20 Signature 3 M.	Firestone 1998 08 20
اب	Solicitor for Transferor(s) I have explained the determine that this transfer does not contravene to	effect of section 50 of the Planning Act to the transferral section and based on the information supplied by	or and I have made inquiries of the transferor to the transferor, to the best of my knowledge and
200	ballo the Vanciar risps not contravano that soci	on Lain an Chiava spicifor in accord standing.	Dale of Signature
140	Name and Paul Merrick Brat Address of 4950 Yonge Street, 20 Sometor North York, Ontario	MZN 6K1 Signatura A	11998 1 08 2
VCI -	(14) Solicitor for Transfereo(s) I have in	vestigated the title to this land and to abulting land wi	here relevant and I am satisfied that the title records to the best of my knowledge and belief this transfer
2	(14) Solicitor for Transferee(s) I have in reveal no contravention as sel out in does not confravene section 50 of the P	anning Act. Lact independently of the solicitor for the tran	sleror(s) and I am an Onlano solicitor in good standing.
١.	Name and		Date of Signature
	Address of Solicitor		'   "   "
	39	Signaturo	
(15	Assassment Roll Number Cty. Mun. of Property 24 01	Map Sub Par. 010 030 02610	Registration Fee 50,00
(11	5) Municipal Address of Property	(17) Document Prepared by:	Registration Fee SO. OO
	382 Burnhamthorpe Road Oakville, Ontario	Messrs. Bratty and Partners Barristers and Solicitors	15 Land Transfer Tex 48924. 16
	L6J 4Z2	4950 Yonge Street, 20th Floor	OFFICE
		North York, Ontario M2N 6KL	Total 48974.16
		File No. 169404/P.Merrick/tu	[위 Total 4/20년4 //~



## GEOTECHNICAL • ENVIRONMENTAL • HYDROGEOLOGICAL • BUILDING SCIENCE

100 NUGGET AVENUE, TORONTO, ONTARIO M1S 3A7 • TEL: (416) 754-8515 • FAX: (416) 754-8516

 BARRIE
 MISSISSAUGA
 OSHAWA
 NEWMARKET
 GRAVENHURST
 PETERBOROUGH
 HAMILTON

 TEL: (705) 721-7863
 TEL: (905) 542-7605
 TEL: (905) 440-2040
 TEL: (905) 853-0647
 TEL: (705) 684-4242
 TEL: (905) 440-2040
 TEL: (905) 777-7956

 FAX: (705) 721-7864
 FAX: (905) 542-2769
 FAX: (905) 725-1315
 FAX: (416) 754-8516
 FAX: (705) 684-8522
 FAX: (905) 725-1315
 FAX: (905) 542-2769

## APPENDIX 'C'

FREEDOM OF INFORMATION

REFERENCE NO. 1410-E133

## Ministry of the Environment

Freedom of Information and Protection of Privacy Office

12<sup>th</sup> Floor 40 St. Clair Avenue West Toronto ON M4V 1M2 Tel: (416) 314-4075 Fax: (416) 314-4285 Ministère de l'Environnement

Bureau de l'accès à l'information et de la protection de la vie privée

12<sup>e</sup> étage 40, avenue St. Clair ouest Toronto ON M4V 1M2 Tél. : (416) 314-4075 Téléc. : (416) 314-4285



March 27, 2014

Jenny Park Soil Engineers Ltd 100 Nugget Ave Toronto, ON M1S 3A7

Dear Jenny Park:

RE: Freedom of Information and Protection of Privacy Act Request
Our File # A-2014-01518, Your Reference 1402-S025E

This letter is in response to your request made pursuant to the *Freedom of Information and Protection of Privacy Act* relating to 382 Burnhamthorpe Road West, Oakville.

After a thorough search through the files of the Ministry's Halton Peel District Office, Investigations and Enforcement Branch, Environmental Monitoring and Reporting Branch, Sector Compliance Branch and Safe Drinking Water Branch, no records were located responsive to your request. To provide you with this response and in accordance with Section 57 of the *Freedom of Information and Protection of Privacy Act*, the fee owed is \$30.00 for 1 hour of search time @ \$30.00 per hour. We have applied the \$30.00 for this request from your initial payment. This file is now closed.

You may request a review of my decision by contacting the Information and Privacy Commissioner/Ontario, 2 Bloor Street East, Suite 1400, Toronto, ON M4W 1A8 (800-387-0073 or 416-326-3333). Please note that there is a \$25.00 fee and you only have 30 days from receipt of this letter to request a review.

If you have any questions regarding this matter, please contact Liz Mico at (416) 212-0559 or liz.mico@ontario.ca.

Yours truly,

feldi Ritscher Ol Manager



100 NUGGET AVENUE, TORONTO, ONTARIO M1S 3A7 · TEL: (416) 754-8515 · FAX: (416) 754-8516

 BARRIE
 MISSISSAUGA
 OSHAWA
 NEWMARKET
 GRAVENHURST
 PETERBOROUGH
 HAMILTON

 TEL: (705) 721-7863
 TEL: (905) 542-7605
 TEL: (905) 440-2040
 TEL: (905) 853-0647
 TEL: (705) 684-4242
 TEL: (905) 440-2040
 TEL: (905) 777-7956

 FAX: (705) 721-7864
 FAX: (905) 542-2769
 FAX: (905) 725-1315
 FAX: (416) 754-8516
 FAX: (705) 684-8522
 FAX: (905) 725-1315
 FAX: (905) 542-2769


## APPENDIX 'D'

**ECOLOG ERIS REPORT** 

REFERENCE NO. 1410-E133



# DATABASE REPORT

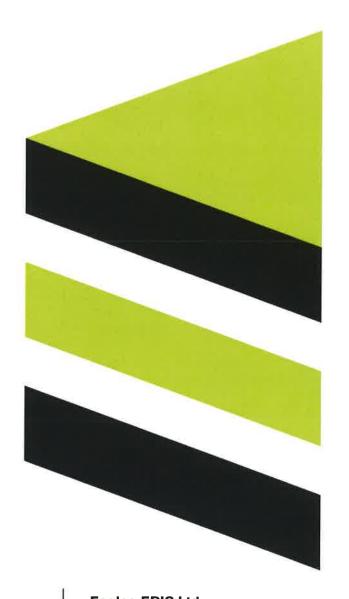

**Project Property:** 

1410-E113

1 Neyagawa Blvd

Oakville ON L6M4L6

Custom-Build Your Own Report

Order #:

Report Type:

20140214020

Requested by:

Soil Engineers Ltd.

Date:

February 24, 2014

**Ecolog ERIS Ltd.** 

Environmental Risk Information

Service Ltd. (ERIS)

A division of Glacier Media Inc.

P: 1.866.517.5204

E: info@erisinfo.com

www.erisinfo.com

## Table of Contents

Table of Contents	1
Executive Summary	2
Executive Summary: Report Summary	
Executive Summary: Site Report Summary - Project Property	5
Executive Summary: Site Report Summary - Surrounding Properties	6
Executive Summary: Summary By Data Source	7
Map	9
Aerial	10
Detail Report	11
Unplottable Summary	15
Unplottable Report	16
Appendix: Database Descriptions	19
Definitions	28

#### Notice: IMPORTANT LIMITATIONS and YOUR LIABILITY

Reliance on information in Report: This report DOES NOT replace a full Phase I Environmental Site Assessment but is solely intended to be used as a database review on environmental records.

License for use of information in Report: No page of this report can be used without this cover page, this notice and the project property identifier. The information in Report(s) may not be modified or re-sold.

Your Liability for misuse: Using this Service and/or its reports in a manner contrary to this Notice or your agreement will be in breach of copyright and contract and ERIS may obtain damages for such mis-use, including damages caused to third parties, and gives ERIS the right to terminate your account, rescind your license to any previous reports and to bar you from future use of the Service.

No warranty of Accuracy or Liability for ERIS: The information contained in this report has been produced by EcoLog Environmental Risk Information Services Ltd ("ERIS") using various sources of information, including information provided by Federal and Provincial government departments. The report applies only to the address and up to the date specified on the cover of this report, and any alterations or deviation from this description will require a new report. This report and the data contained herein does not purport to be and does not constitute a guarantee of the accuracy of the information contained herein and does not constitute a legal opinion nor medical advice. Although ERIS has endeavored to present you with information that is accurate, EcoLog ERIS disclaims, any and all liability for any errors, omissions, or inaccuracies in such information and data, whether attributable to inadvertence, negligence or otherwise, and for any consequences arising therefrom. Liability on the part of EcoLog ERIS is limited to the monetary value paid for this report.

**Trademark and Copyright:** You may not use the ERIS trademarks or attribute any work to ERIS other than as outlined above. This Service and Report(s) are protected by copyright owned by EcoLog ERIS Ltd. Copyright in data used in the Service or Report(s) (the "Data") is owned by EcoLog ERIS or its licensors. The Service, Report(s) and Data may not be copied or reproduced in whole or in any substantial part without prior written consent of EcoLog ERIS.

Order #: 20140214020

## **Executive Summary**

**Property Information:** 

Project Property: 1410-E133

1 Neyagawa Blvd Oakville ON L6M4L6

**Order Information:** 

Order No.:20140214020Date Requested:25/02/2014Requested by:Soil Engineers Ltd.

Report Type: Custom-Build Your Own Report

**Additional Products:** 

Order #: 20140214020

# Executive Summary: Report Summary

Database	Name	Searched	Project Property	Boundary to 0.25km	Total
<u>AAGR</u>	Abandoned Aggregate Inventory	Y	0	0	0
<u>AGR</u>	Aggregate Inventory	Y	0	0	0
AMIS	Abandoned Mine Information System	Y	0	0	0
ANDR	Anderson's Waste Disposal Sites	Y	0	0	0
AUWR	Automobile Wrecking & Supplies	Y	0	0	0
BORE	Borehole	Y	0	0	0
<u>C</u> A	Certificates of Approval	Y	0	1	1
<u>CFOT</u>	Commercial Fuel Oil Tanks	Y	0	0	0
<u>CHEM</u>	Chemical Register	Y	0	0	0
COAL	Inventory of Coal Gasification Plants and Coal Tar Sites	Y	0	0	0
CONV	Compliance and Convictions	Y	0	0	0
<u>CPU</u>	Certificates of Property Use	Y	0	0	0
DRL	Drill Hole Database	Y	0	0	0
<u>EASR</u>	Environmental Activity and Sector Registry	Y	0	0	0
<u>EBR</u>	Environmental Registry	Y	0	0	0
<u>ECA</u>	Environmental Compliance Approval	Y	0	0	0
<u>EEM</u>	Environmental Effects Monitoring	Υ	0	0	0
<u>EHS</u>	ERIS Historical Searches	Y	0	4	4
<u>EIIS</u>	Environmental Issues Inventory System	Y	0	0	0
<u>EXP</u>	List of TSSA Expired Facilities	Y	0	0	0
<u>FCON</u>	Federal Convictions	Y	0	0	0
<u>FCS</u>	Contaminated Sites on Federal Land	Y	0	0	0
<u>FOFT</u>	Fisheries & Oceans Fuel Tanks	Y	0	0	0
<u>FST</u>	Fuel Storage Tank	Y	0	0	0
<u>FSTH</u>	Fuel Storage Tank - Historic	Y	0	0	0
<u>GEN</u>	Ontario Regulation 347 Waste Generators Summary	Y	0	0	0
<u>HINC</u>	TSSA Historic Incidents	Y	0	0	0
IAFT	Indian & Northern Affairs Fuel Tanks	Y	0	0	0
INC	TSSA Incidents	Y	0	0	0
<u>LIMO</u>	Landfill Inventory Management Ontario	Y	0	0	0
MINE	Canadian Mine Locations	Y	0	0	0
MNR	Mineral Occurrences	Y	0	0	0
<u>NATE</u>	National Analysis of Trends in Emergencies System (NATES)	Υ	0	0	0
<u>NCPL</u>	Non-Compliance Reports	Y	0	0	0
<u>NDFT</u>	National Defence & Canadian Forces Fuel Tanks	Y	0	0	0
<u>NDSP</u>	National Defence & Canadian Forces Spills	Y	0	0	0
<u>NDWD</u>	National Defence & Canadian Forces Waste Disposal Sites	Y	0	0	0

Database	Name	Searched	Project Property	Boundary to 0.25km	Total
NEES	National Environmental Emergencies System (NEES)	Y	0	0	0
<u>NPÇB</u>	National PCB Inventory	Υ	0	0	0
<u>NPRI</u>	National Pollutant Release Inventory	Y	0	0	0
<u>ogw</u>	Oil and Gas Wells	Υ	0	0	0
<u>oogw</u>	Ontario Oil and Gas Wells	Υ	0	0	0
<u>OPCB</u>	Inventory of PCB Storage Sites	Υ	0	0	0
ORD	Orders	Υ	0	0	0
<u>PAP</u>	Canadian Pulp and Paper	Υ	0	0	0
<u>PCFT</u>	Parks Canada Fuel Storage Tanks	Υ	0	0	0
<u>PES</u>	Pesticide Register	Υ	0	0	0
<u>PINC</u>	TSSA Pipeline Incidents	Υ	0	0	0
<u>PRT</u>	Private and Retail Fuel Storage Tanks	Υ	0	0	0
<u>PTTW</u>	Permit to Take Water	Υ	0	0	0
<u>REC</u>	Ontario Regulation 347 Waste Receivers Summary	Υ	0	0	0
<u>RSC</u>	Record of Site Condition	Υ	0	1	1
<u>RST</u>	Retail Fuel Storage Tanks	Υ	0	0	0
<u>SCT</u>	Scott's Manufacturing Directory	Υ	0	0	0
<u>SPL</u>	Ontario Spills	Υ	0	0	0
<u>\$RD\$</u>	Wastewater Discharger Registration Database	Υ	0	0	0
TANK	Anderson's Storage Tanks	Y	0	0	0
<u>TCFT</u>	Transport Canada Fuel Storage Tanks	Y	0	0	0
VAR	TSSA Variances for Abandonment of Underground	Y	0	0	0
<u>WDS</u>	Storage Tanks Waste Disposal Sites - MOE CA Inventory	Y	0	0	0
<u>WDSH</u>	Waste Disposal Sites - MOE 1991 Historical Approval	Y	0	0	0
<u>wwis</u>	Inventory Water Well Information System	Υ	0	4	4
		Total:	0	10	10

Order #: 20140214020

# Executive Summary: Site Report Summary – Project Property

 Map
 DB
 Company/Site Name
 Address
 Page

 Key
 Number

No records found in the selected databases for the project property.

# Executive Summary: Site Report Summary – Surrounding Properties

Map Key	DB	Company/Site Name	Address	Page Number
1	WWIS		ON.	11
2	RSC	Sherborne Lodge Developments Limited	ON 382 BURNHAMTHORPE RD W, OAKVILLE, ON, L6M 4K3 ON L6M 4K3	11
<u>3</u>	EHS		374 Burnhamthorpe Road West Oakville ON	11
<u>4</u>	EHS		NE & NW corners of Burnhamthorpe Rd W &Neyagawa Blvd Oakville ON	12
<u>5</u>	CA	King's Christian Collegiate	Oct We ON	12
<u>6</u>	wwis		Oakville ON lot 20 con 2 ON	12
7	WWIS		lot 19 con 2 OAKVILLE ON	13
<u>8</u>	EHS		353 Burnhamthorpe Rd W Oakville ON	13
9	WWIS		lot 19 con 2 ON	13
<u>10</u>	EHS		337-353 Burnhamthorpe Rd W	14

## Executive Summary: Summary By Data Source

### **CA** - Certificates of Approval

A search of the CA database, dated 1985-Oct 30, 2011\* has found that there are 1 CA site(s) within approximately 0.25 Kilometers of the project property.

<u>Site</u>	<u>Address</u>	<u>Map Key</u>
King's Christian Collegiate		5
-	Oakville ON	

#### **EHS** - ERIS Historical Searches

A search of the EHS database, dated 1999-Mar 2013 has found that there are 4 EHS site(s) within approximately 0.25 Kilometers of the project property.

Site	Address	<u>Map Key</u>
	374 Burnhamthorpe Road West Oakville ON	3
	NE & NW corners of Burnhamthorpe Rd W &Neyagawa Blvd	4
	Oakville ON 353 Burnhamthorpe Rd W Oakville ON	8
	337-353 Burnhamthorpe Rd W Oakville ON	10

#### **RSC** - Record of Site Condition

A search of the RSC database, dated 1997-Sept 2001, Oct 2004-Jan 2014 has found that there are 1 RSC site(s) within approximately 0.25 Kilometers of the project property.

<u>Site</u>	Address	<u>Map Key</u>
Sherborne Lodge Developments Limited	382 BURNHAMTHORPE RD W, OAKVILLE, ON, L6M 4K3	2
	ON L6M 4K3	


### **WWIS** - Water Well Information System

A search of the WWIS database, dated 1955-May 2013 has found that there are 4 WWIS site(s) within approximately 0.25 Kilometers of the project property.

Order #: 20140214020

<u>Site</u>	<u>Address</u>	<u>Map Key</u>
		1
	ON	

Site	Address lot 20 con 2 ON	Map Key 6
	lot 19 con 2 OAKVILLE ON	7
	lot 19 con 2 ON	9

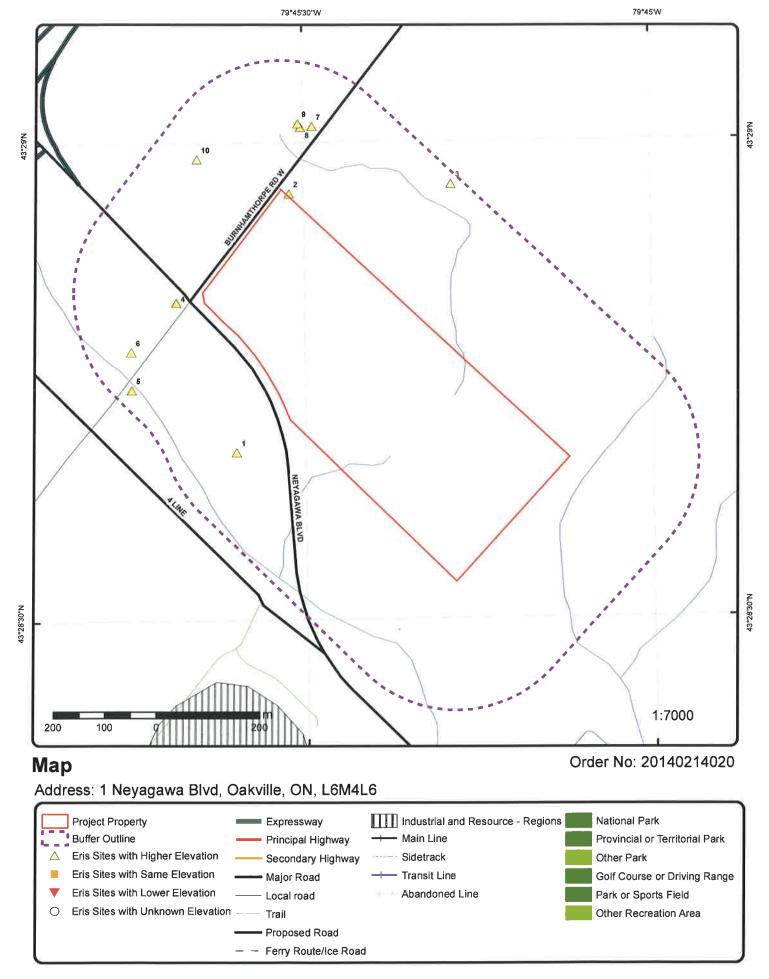

Source: © 2012 DMTI Spatial Inc.

### Aerial

### Detail Report

Мар Ке	ey Num Reco	ber of ords	Elevation m	Site		DB
1	1 of 1		173.4	ON		<u>wwis</u>
Sec. Wa Pump Ra Flow Ra Specific Construc Elevation	Nad83: Water Use: ate: ate: Capacity: ction Methon (m): Bedrock:		1		Lot: Concession Name: Municipality: Northing Nad83: Utm Reliability: Construction Date: Well Depth: Static Water Level: Clear/Cloudy: Final Well Status: Flowing (y/n): Elevation Reliability: Overburden/Bedrock: Casing Material:	OAKVILLE TOWN 4814637 margin of error: 10 - 30 m 09-NOV-07  Abandoned-Other
2	1 of 1		179.6		e Lodge Developments Limi NHAMTHORPE RD W, OAKV 4K3	
	knowledg.:		15-Apr-09			
Soil Type	tion Date:		27-Jan-09			
Registra: Stratified Criteria: Consulta	tion #: i (Y/N):		50311			
District C			OAKVILLE			
	l Prop Use: Property Us		Residential Agriculture/Oth	Δr		
Certificat	te Prop Use	#:	No CPU	OI .		
Legal De	le Standard escription:				NDS, PT 1 20R17350; OAK\	/ILLE
	entification ‡ gal prop. (y/		24929 - 0219 (I Yes	_T)		
JTM Co	ordinates:		NAD83 17-600		converted from Latitude & Lon	gitude)
	& Longitude / Estimate:		43.47916670N 0 to 1 meters	79.75666670W	l	
Measure	ment Methoused Sect 16	od:	Global Position No	ing System		
3	1 of 1		175.8	374 Burni Oakville O	hamthorpe Road West DN	<u>EHS</u>

erisinfo.com | EcoLog ERIS Ltd.
1410-E133 1 Neyagawa Blvd Oakville ON L6M4L6

Order #: 20140214020

Мар Кеу	Numbe Record		Site			DB
Report Dat Report Typ Search Ra Addit. Info	oe: dius (km).	23-AUG-12 RSC Premium I .3	Package (Rural)			
4	1 of 1	179.1	NE & NW corr Blvd Oakville ON	ners of Burnhamthorpe	Rd W &Neyagawa	<u>EHS</u>
Order No.: Report Dat Report Typ Search Ra Addit. Info	te: pe: dius (km):	20051207002 12/15/2005 Complete Repo 0.35 Fire Insur. Maps		Unplotted Water Wells		
5	1 of 1	176.6	King's Christi	an Collegiate		CA
			Oakville ON			
Certificate Application Issue Date Approval T Status: Application Client Nam Client Adty Client Client Post Project Des Contamina Emission C	Year: : :ype: Type: ee: ress: al Code: scription: nts:	3433-63KR24 2004 8/23/2004 Municipal and F Revoked and/or	Private Sewage Wor Replaced	rks		
6	1 of 1	178.2	lot 20 con 2 ON			<u>wwis</u>
Well ID: Concession County: Easting Nat Zone: Primary Wa Sec. Water Pump Rate: Flow Rate: Specific Ca Constructio Elevation (r Depth to Be Water Type	d83: ater Use: Use: : pacity: n Method: n): edrock:	2802214 02 HALTON 600075.6 17 Domestic Cable Tool 180.93 34 FRESH		Lot: Concession Name: Municipality: Northing Nad83: Utm Reliability: Construction Date: Well Depth: Static Water Level: Clear/Cloudy: Final Well Status: Flowing (y/n): Elevation Reliability: Overburden/Bedrock: Casing Material:	020 DS N OAKVILLE TOWN 4814831 unknown UTM 22-OCT-56 55 ft 15 ft CLEAR Water Supply N Bedrock OPEN HOLE,STEEL	25
Details -					0.1.5	
Thickness Material ( +		34 ft	ă.	Original Depth: Material:	34 ft CLAY	
Thickness	s:	21 ft		Original Depth:	55 ft	

Мар Кеу	Numbe Record		Elevation m	Site			DB
Material (	Colour:				Material:	SHALE	
7	1 of 1	18	31.2	lot 19 con 2 OAKVILLE ON			wwis
Well ID: Concession County: Easting Nac Zone: Primary Wa Sec. Water Pump Rate: Specific Ca Construction Elevation (n Depth to Be Water Type Details Thickness	d83: uter Use: Use: pacity: n Method: n): drock: :	7135928 02 HALTON Not Used Boring			Lot: Concession Name: Municipality: Northing Nad83: Utm Reliability: Construction Date: Well Depth: Static Water Level: Clear/Cloudy: Final Well Status: Flowing (y/n): Elevation Reliability: Overburden/Bedrock: Casing Material:  Original Depth:	OAKVILLE TOWN unknown UTM 19-NOV-09 Abandoned-Other	
Material C	1 of 1	18	11.2	353 Burnhamth	Material: orpe Rd W		<u>EHS</u>
Order No.: Report Date Report Type Search Rad Addit. Info C	e: lius (km):	2/19	30208014 /2008 c Report	Oakville ON			
9	1 of 1	18	11.3	lot 19 con 2 ON			<u>wwis</u>
Well ID: Concession County: Easting Nac Zone: Primary Wat Sec. Water Pump Rate: Flow Rate: Specific Cap Constructior Elevation (m Depth to Bet Water Type: Details	ter Use: Use: Dacity: 1 Method: 1): drock:	7135912 02 HALTON 600397 17 Not Used Digging 182.96			Lot: Concession Name: Municipality: Northing Nad83: Utm Reliability: Construction Date: Well Depth: Static Water Level: Clear/Cloudy: Final Well Status: Flowing (y/n): Elevation Reliability: Overburden/Bedrock: Casing Material:	019 DS N OAKVILLE TOWN 4815275 margin of error: 10 - 30 19-NOV-09 8.37 m 1.06 m Abandoned-Other	m
Thickness Material C +	:	5.2 m			Original Depth: Material:	5.2 m BOULDERS	
Thickness Material C		2.65 m			Original Depth: Material:	7.85 m	

	m			
.3 m		Original Depth:	8.15 m	
r:		Material:	GRAVEL	
.22 m		Original Depth:	8.37 m	
r:		Material:		
f 1	181.8	337-353 Burnhamthorpe Rd W Oakville ON		EHS
(m)·	20120430037 5/9/2012 Custom Report			
	.22 m	.22 m .22 m .21 m .22 m .21 m .21 m .22 m .22 m .23 m .24 m .25 m .25 m .25 m .25 m .25 m .25 m .26 m .27 m .27 m .28 m .28 m .29 m .29 m .20 m	.22 m Original Depth:	.22 m

### Unplottable Summary

DB	Company Name/Site Name	Address	City	Zip
CA	R.M. OF HALTON	NEYAGAWA BLVD. SAN. FORCEMAIN	OAKVILLE TOWN ON	
<u>CA</u>		Part of Lot 13, Con 2 North of Burnhamthorpe Rd East and West of Trafalgar Rd	Oakville ON	
ECA	The Regional Municipality of Halton	Neyagawa Boulevard	Oakville ON	
GEN	HALTON, REGIONAL MUNICIPALITY OF	CLOSED OAKVILLE LANDFILL SITE	OAKVILLE ON	
GEN	BOT CONSTRUCTION LIMITED	BURNHAMTHORPE ROAD WEST	OAKVILLE ON	
SPL	The Corporation of the Town of Oakville	Neyagawa Blvd, North of Dundas St.	Oakville ON	
<u>SPL</u>	UNION GAS LTD.	BURNHAMTHORPE RD WEST AT MAIN GAS TRANSMISSION LINE FROM MILTON.	OAKVILLE TOWN ON	

#### Unplottable Report

Site: R.M. OF HALTON

NEYAGAWA BLVD. SAN. FORCEMAIN OAKVILLE TOWN ON

Database: CA

Certificate #:

3-1750-95-966

Application Year:

95 1/12/96

Issue Date: Approval Type:

Municipal sewage

Status:

Received in 1995, Issued in 1996

Application Type: Client Name: Client Address: Client City:

Client Postal Code: Project Description: Contaminants: Emission Control:

<u>Site:</u>
Part of Lot 13, Con 2 North of Burnhamthorpe Rd East and West of Trafalgar Rd Oakville ON

Database:

CA

Certificate #:

3785-54UPXS

Application Year:

01

Issue Date:

12/13/01

Approval Type:

Municipal & Private water

Status:

Approved

Application Type:

New Certificate of Approval

Client Name:

The Corporation of the Regional Municipality of Halton

Client Address:

1151 Bronte Road

Client City: Client Postal Code: Oakville L6M 3L1

Project Description:

This application is for an above ground water storage tank having a high water level of 236 m

and available storage volume of approximately 4,550 m3 (Alternative 1), or 6,830 m 3

(Alternative 2).

Contaminants:

Emission Control:

<u>Site:</u> The Regional Municipality of Halton Neyagawa Boulevard Oakville ON Database: <u>ECA</u>

CofA Number:

8460-8S8JN4 3/12/2012

Date: Status:

Approved

Project Type:

Municipal and Private Sewage

Site: HALTON, REGIONAL MUNICIPALITY OF

CLOSED OAKVILLE LANDFILL SITE OAKVILLE ON

Database: GEN

SIC Code:

SIC Description:

Generator #:

ON0277100

erisinfo.com| EcoLog ERIS Ltd.

1410-E133 1 Neyagawa Blvd Oakville ON L6M4L6

Order #: 20140214020

Approval Yrs:

02,03,04,05,06

--- Details ---

Waste Code:

Waste Description:

STEEL MAKING RESIDUES

Waste Code:

144

Waste Description:

**INORGANIC TANNERY WASTES** 

Waste Code: Waste Description:

LANDFILL LEACHATES

**BOT CONSTRUCTION LIMITED** Site:

BURNHAMTHORPE ROAD WEST OAKVILLE ON

Database: **GEN** 

SIC Code:

3192

SIC Description:

CONSTRTUCTION EQUIP.

Generator #: Approval Yrs:

ON0652239 99,00,01,02,03,04

--- Details ---

Waste Code:

252

Waste Description:

WASTE OILS & LUBRICANTS

Site: The Corporation of the Town of Oakville

Neyagawa Blvd, North of Dundas St. Oakville ON

Database: SPL

Ref No.:

Incident Dt:

1086-5QSSD5 8/26/2003

MOE Reported Dt:

8/26/2003

Contaminant Name:

LEACHATE, TRASH CAN, COMPACTOR, ETC

Contaminant Quantity:

Incident Summary:

Incident Cause:

Spill of approx. 2- 15 m 3 leachate: Unknown

Incident Reason:

Nature of Impact:

Receiving Medium:

Land

Environmental Impact:

Possible

Site: UNION GAS LTD.

> BURNHAMTHORPE RD WEST AT MAIN GAS **TOWN ON**

Database:

<u>SPL</u>

TRANSMISSION LINE FROM MILTON. OAKVILLE

UNION GAS-ONGOING NATURALGAS LEAK TO ATM FROM MAINLINE, BACKHOE

Ref No.:

159843

Incident Dt: MOE Reported Dt: 9/7/1998 9/7/1998

Contaminant Name:

Contaminant Quantity:

Incident Summary:

DAMAGE, FD.

Incident Cause:

PIPE/HOSE LEAK

Incident Reason: Nature of Impact: **ERROR** Air Pollution

Receiving Medium:

AIR

Environmental Impact:

**POSSIBLE** 

### Appendix: Database Descriptions

Ecolog Environmental Risk Information Services Ltd can search the following databases. The extent of Historical information varies with each database and current information is determined by what is publicly available to Ecolog ERIS at the time of update. **Note:** Databases denoted with " \* " indicates that the database will no longer be updated. See the individual database description for more information.

#### Abandoned Aggregate Inventory:

Sept 2002\*

Provincial

**AAGR** 

The MAAP Program maintains a database of all abandoned pits and quarries. Please note that the database is only referenced by lot and concession and city/town location. The database provides information regarding the location, type, size, land use, status and general comments.\*

#### Aggregate Inventory:

Up to Aug 2012

Provincial

AGR

The Ontario Ministry of Natural Resources maintains a database of all active pits and quarries. The database provides information regarding the registered owner/operator, location name, operation type, approval type, and maximum annual tonnage.

#### **Abandoned Mine Information System:**

1800-Feb 2013

Provincial

**AMIS** 

The Abandoned Mines Information System contains data on known abandoned and inactive mines located on both Crown and privately held lands. The information was provided by the Ministry of Northern Development and Mines (MNDM), with the following disclaimer: "the database provided has been compiled from various sources, and the Ministry of Northern Development and Mines makes no representation and takes no responsibility that such information is accurate, current or complete". Reported information includes official mine name, status, background information, mine start/end date, primary commodity, mine features, hazards and remediation.

#### Anderson's Waste Disposal Sites:

1860s-Present

Private

ANDR

The information provided in this database was collected by examining various historical documents which aimed to characterize the likely position of former waste disposal sites from 1860 to present. The research initiative behind the creation of this database was to identify those sites that are missing from the Ontario MOE Waste Disposal Site Inventory, as well as to provide revisions and corrections to the positions and descriptions of sites currently listed in the MOE inventory. In addition to historic waste disposal facilities, the database also identifies certain auto wreckers and scrap yards that have been extrapolated from documentary sources. Please note that the data is not warranted to be complete, exhaustive or authoritive. The information was collected for research purposes only.

#### Automobile Wrecking & Supplies:

2001-Jun 2010

Private

Order #: 20140214020

**AUWR** 

This database provides an inventory of all known locations that are involved in the scrap metal, automobile wrecking/recycling, and automobile parts & supplies industry. Information is provided on the company name, location and business type.

**Borehole:** 1875-Aug 2011 Provincial BORE

A borehole is the generalized term for any narrow shaft drilled in the ground, either vertically or horizontally. The information here includes geotechnical investigations or environmental site assessments, mineral exploration, or as a pilot hole for installing piers or underground utilities. Information is from many sources such as the Ministry of Transportation (MTO) boreholes from engineering reports and projects from the 1950 to 1990's in Southern Ontario. Boreholes from the Ontario Geological Survey (OGS) including The Urban Geology Analysis Information System (UGAIS) and the York Peel Durham Toronto (YPDT) database of the Conservation Authority Moraine Coalition. This database will include fields such as location, stratigraphy, depth, elevation, year drilled, etc. For all water well data or oil and gas well data for Ontario please refer to WWIS and OOGW.

#### **Certificates of Approval:**

1985-Oct 30, 2011\*

Provincial

CA

This database contains the following types of approvals: Air & Noise, Industrial Sewage, Municipal & Private Sewage, Waste Management Systems and Renewable Energy Approvals. The MOE in Ontario states that any facility that releases emissions to the atmosphere, discharges contaminants to ground or surface water, provides potable water supplies, or stores, transports or disposes of waste, must have a Certificate of Approval before it can operate lawfully. Fields include approval number, business name, address, approval date, approval type and status. This database will no longer be updated, as CofA's have been replaced by either Environmental Activity and Sector Registry (EASR) or Environmental Compliance Approval (ECA). Please refer to those individual databases for any information after Oct.31, 2011.

#### Commercial Fuel Oil Tanks:

1948-Apr 2013

Provincial

CFOT

Since May 2002, Ontario developed a new act where it became mandatory for fuel oil tanks to be registered with Technical Standards & Safety Authority (TSSA). This data would include all commercial underground fuel oil tanks in Ontario with fields such as location, registration number, tank material, age of tank and tank size.

#### **Chemical Register:**

1992, 1999-Jun 2010

Private

CHEM

This database includes information from both a one time study conducted in 1992 and private source and is a listing of facilities that manufacture or distribute chemicals. The production of these chemical substances may involve one or more chemical reactions and/or chemical separation processes (i.e. fractionation, solvent extraction, crystallization, etc.).

#### Inventory of Coal Gasification Plants and Coal Tar Sites:

Apr 1987 and Nov 1988\*

Provincial

**COAL** 

This inventory includes both the "Inventory of Coal Gasification Plant Waste Sites in Ontario-April 1987" and the Inventory of Industrial Sites Producing or Using Coal Tar and Related Tars in Ontario-November 1988) collected by the MOE. It identifies industrial sites that produced and continue to produce or use coal tar and other related tars. Detailed information is available and includes: facility type, size, land use, information on adjoining properties, soil condition, site operators/occupants, site description, potential environmental impacts and historic maps available. This was a one-time

inventory.\*

#### **Compliance and Convictions:**

1989-2013

Provincial

CONV

This database summarizes the fines and convictions handed down by the Ontario courts beginning in 1989. Companies and individuals named here have been found guilty of environmental offenses in Ontario courts of law.

#### **Certificates of Property Use:**

1994-2013

Provincial

PDII

This is a subset taken from Ontario's Environmental Registry (EBR) database. It will include all CPU's on the registry such as (EPA s. 168.6) - Certificate of Property Use.

#### Drill Hole Database:

1886-Jun 2013

Provincial

DRL

The Ontario Drill Hole Database contains information on more than 113,000 percussion, overburden, sonic and diamond drill holes from assessment files on record with the department of Mines and Minerals. Please note that limited data is available for southern Ontario, as it was the last area to be completed. The database was created when surveys submitted to the Ministry were converted in the Assessment File Research Image Database (AFRI) project. However, the degree of accuracy (coordinates) as to the exact location of drill holes is dependent upon the source document submitted to the MNDM. Levels of accuracy used to locate holes are: centering on the mining claim; a sketch of the mining claim; a 1:50,000 map; a detailed company map; or from submitted a "Report of Work".

#### **Environmental Activity and Sector Registry:**

Oct 31 2011-Dec 2013

Provincial

**EASR** 

On October 31, 2011, a smarter, faster environmental approvals system came into effect in Ontario. The EASR allows businesses to register certain activities with the ministry, rather than apply for an approval. The registry is available for common systems and processes, to which preset rules of operation can be applied. The EASR is currently available for: heating systems, standby power systems and automotive refinishing. Businesses whose activities aren't subject to the EASR may apply for an ECA (Environmental Compliance Approval), Please see our ECA database.

#### **Environmental Registry:**

1994-2013

Provincial

EBR

The Environmental Registry lists proposals, decisions and exceptions regarding policies, Acts, instruments, or regulations that could significantly affect the environment. Through the Registry, thirteen provincial ministries notify the public of upcoming proposals and invite their comments. For example, if a local business is requesting a permit, ticense, or certificate of approval to release substances into the air or water; these are notified on the registry. Data includes: Approval for discharge into the natural environment other than water (i.e. Air) - EPA s. 9, Approval for sewage works - OWRA s. 53(1), and EPA s. 27 - Approval for a waste disposal site. For information regarding Permit to Take Water (PTTW), Certificate of Property Use (CPU) and (ORD) Orders please refer to those individual databases.

#### **Environmental Compliance Approval:**

Oct 31, 2011-Jan 2014

Provincia

ECA

On October 31, 2011, a smarter, faster environmental approvals system came into effect in Ontario. In the past, a business had to apply for multiple approvals (known as certificates of approval) for individual processes and pieces of equipment. Today, a business either registers itself, or applies for a single approval, depending on the types of activities it conducts. Businesses whose activities aren't subject to the EASR may apply for an ECA. A single ECA addresses all of a business's emissions, discharges and wastes. Separate approvals for air, noise and waste are no longer required. This database will also include Renewable Energy Approvals. For CofA's prior to Nov 1st, 2011, please refer to the CA database. For all Waste Disposal Sites please refer to the WDS database.

#### **Environmental Effects Monitoring:**

1992-2007\*

Federal

<u>EEM</u>

The Environmental Effects Monitoring program assesses the effects of effluent from industrial or other sources on fish, fish habitat and human usage of fisheries resources. Since 1992, pulp and paper mills have been required to conduct EEM studies under the Pulp and Paper Effluent Regulations. This database provides information on the mill name, geographical location and sub-lethal toxicity data.

#### ERIS Historical Searches:

1999-Mar 2013

Private

EHS

EcoLog ERIS has compiled a database of all environmental risk reports completed since March 1999. Available fields for this database include: site location, date of report, type of report, and search radius. As per all other databases, the ERIS database can be referenced on both the map and "Statistical Profile" page.

#### Environmental Issues Inventory System:

1992-2001\*

Federal

EIIS

The Environmental Issues Inventory System was developed through the implementation of the Environmental Issues and Remediation Plan. This plan was established to determine the location and severity of contaminated sites on inhabited First Nation reserves, and where necessary, to remediate those that posed a risk to health and safety; and to prevent future environmental problems. The EIIS provides information on the reserve under investigation, inventory number, name of site, environmental issue, site action (Remediation, Site Assessment), and date investigation completed.

#### **List of TSSA Expired Facilities:**

Current to May 2013

Provincial

EXP

This is a list of all expired facilities that fall under the TSSA (TSSA Act & Safety Regulations), including the six regulations that exist under the Fuels Safety Division. It will include facilities such as private fuel outlets, bulk plants, fuel oil tanks, gasoline stations, marinas, propane filling stations, liquid fuel tanks, piping systems, etc. These tanks have been removed and automatically fall under the expired facilities inventory held by TSSA.

#### Federal Convictions:

1988-Jun 2007\*

Federal

Order #: 20140214020

<u>FCON</u>

Environment Canada maintains a database referred to as the "Environmental Registry" that details prosecutions under the Canadian Environmental Protection Act (CEPA) and the Fisheries Act (FA). Information is provided on the company name, location, charge date, offence and penalty.

#### Contaminated Sites on Federal Land:

June 2000-Jan 2014

Federal

FCS

The Federal Contaminated Sites Inventory includes information on all known federal contaminated sites under the custodianship of departments, agencies and consolidated Crown corporations as well as those that are being or have been investigated to determine whether they have contamination arising from past use that could pose a risk to human health or the environment. The inventory also includes non-federal contaminated sites for which the Government of Canada has accepted some or all financial responsibility. It does not include sites where contamination has been caused by, and which are under the control of, enterprise Crown corporations, private individuals, firms or other levels of government.

#### Fisheries & Oceans Fuel Tanks:

1964-Sept 2003

Federal

FOFT

Fisheries & Oceans Canada maintains an inventory of all aboveground & underground fuel storage tanks located on Fisheries & Oceans property or controlled by DFO. Our inventory provides information on the site name, location, tank owner, tank operator, facility type, storage tank location, tank contents & capacity, and date of tank installation.

#### Fuel Storage Tank:

2010-May 2013

Provincial

ST

The Technical Standards & Safety Authority (TSSA), under the Technical Standards & Safety Act of 2000 maintains a database of registered private and retail fuel storage tanks in Ontario with fields such as location, tank status, license date, tank type, tank capacity, fuel type, installation year and facility type.

#### Fuel Storage Tank - Historic:

Pre-Jan 2010\*

Provincial

<u>FSTH</u>

The Technical Standards & Safety Authority (TSSA), under the Technical Standards & Safety Act of 2000 maintains a database of registered private and retail fuel storage tanks in Ontario with fields such as location, tank status, license date, tank type, tank capacity, fuel type, installation year and facility type.

#### Ontario Regulation 347 Waste Generators Summary:

1986-Jul 2013

Provincial

GEN

Regulation 347 of the Ontario EPA defines a waste generation site as any site, equipment and/or operation involved in the production, collection, handling and/or storage of regulated wastes. A generator of regulated waste is required to register the waste generation site and each waste produced, collected, handled, or stored at the site. This database contains the registration number, company name and address of registered generators including the types of hazardous wastes generated. It includes data on waste generating facilities such as: drycleaners, waste treatment and disposal facilities, machine shops, electric power distribution etc. This information is a summary of all years from 1986 including the most currently available data. Some records may contain, within the company name, the phrase "See & Use..." followed by a series of letters and numbers. This occurs when one company is amalgamated with or taken over by another registered company. The number listed as "See & Use", refers to the new ownership and the other identification number refers to the original ownership. This phrase serves as a link between the 2 companies until operations have been fully transferred.

#### TSSA Historic Incidents:

2006-June 2009

Provincial

HINC

This database will cover all incidences recorded by TSSA with their older system, before they moved to their new management system. TSSA's Fuels Safety Program administers the Technical Standards & Safety Act 2000, providing fuel-related safety services associated with the safe transportation, storage, handling and use of fuels such as gasoline, diesel, propane, natural gas and hydrogen. Under this Act, TSSA regulates fuel suppliers, storage facilities, transport trucks, pipelines, contractors and equipment or appliances that use fuels. The TSSA works to protect the public, the environment and property from fuel-related hazards such as spills, fires and explosions. This database will include spills and leaks from pipelines, diesel, fuel oil, gasoline, natural gas, propane and hydrogen recorded by the TSSA.

#### Indian & Northern Affairs Fuel Tanks:

1950-Aug 2003\*

Federal

<u>IAFT</u>

The Department of Indian & Northern Affairs Canada (INAC) maintains an inventory of all aboveground & underground fuel storage tanks located on both federal and crown land. Our inventory provides information on the reserve name, location, facility type, site/facility name, tank type, material & ID number, tank contents & capacity, and date of tank installation.

Provincial INC June 2009-Apr 2013 TSSA Incidents:

TSSA's Fuels Safety Program administers the Technical Standards & Safety Act 2000, providing fuel-related safety services associated with the safe transportation, storage, handling and use of fuels such as gasoline, diesel, propane, natural gas and hydrogen. Under this Act, TSSA regulates fuel suppliers, storage facilities, transport trucks, pipelines, contractors and equipment or appliances that use fuels. Includes incidents from fuel-related hazards such as spills, fires and explosions. This database will include spills and leaks from diesel, fuel oil, gasoline, natural gas, propane and hydrogen recorded by the TSSA.

#### Landfill Inventory Management Ontario:

2012 Provincial LIMO The Landfill Inventory Management Ontario (LIMO) database is updated every year, as the ministry compiles new and updated information. The inventory will include small and large landfills. Additionally, each year the ministry will request operators of the larger landfills complete a landfill data collection form that will be used to update LIMO and will include the following information from the previous operating year. This will include additional information such as estimated amount of total waste received, landfill capacity, estimated total remaining landfill capacity, fill rates, engineering designs, reporting and monitoring details, size of location, service area, approved waste types, leachate of site treatment, contaminant attenuation zone and more. The small landfills will include information such as site owner, site location and

Canadian Mine Locations:

certificate of approval # and status.

1998-2009

Private MINE

This information is collected from the Canadian & American Mines Handbook. The Mines database is a national database that provides over 290 listings on mines (listed as public companies) dealing primarily with precious metals and hard rocks. Listed are mines that are currently in operation, closed, suspended, or are still being developed (advanced projects). Their locations are provided as geographic coordinates (x, y and/or longitude, latitude). As of 2002, data pertaining to Canadian smelters and refineries has been appended to this database.

1846-Apr 2013 Provincial MNR Mineral Occurrences:

In the early 70's, the Ministry of Northern Development and Mines created an inventory of approximately 19,000 mineral occurrences in Ontario, in regard to metallic and industrial minerals, as well as some information on building stones and aggregate deposits. Please note that the "Horizontal Positional Accuracy" is approximately +/- 200 m. Many reference elements for each record were derived from field sketches using pace or chain/tape measurements against claim posts or topographic features in the area. The primary limiting factor for the level of positional accuracy is the scale of the source material. The testing of horizontal accuracy of the source materials was accomplished by comparing the planimetric (X and Y) coordinates of that point with the coordinates of the same point as defined from a source of higher accuracy.

#### Federal NATE National Analysis of Trends in Emergencies System 1974-1994\* (NATES):

In 1974 Environment Canada established the National Analysis of Trends in Emergencies System (NATES) database, for the voluntary reporting of significant spill incidents. The data was to be used to assist in directing the work of the emergencies program. NATES ran from 1974 to 1994. Extensive information is available within this database including company names, place where the spill occurred, date of spill, cause, reason and source of spill, damage incurred, and amount, concentration, and volume of materials released.

#### Provincial Non-Compliance Reports: 1994-2012

**NCPL** 

Order #: 20140214020

The Ministry of the Environment provides information about non-compliant discharges of contaminants to air and water that exceed legal allowable limits, from regulated industrial and municipal facilities. A reported non-compliance failure may be in regard to a Control Order, Certificate of Approval, Sectoral Regulation or specific regulation/act.

National Defence & Canadian Forces Fuel Tanks: Up to May 2001\* Federal NDFT
The Department of National Defence and the Canadian Forces maintains an inventory of all aboveground & underground fuel storage tanks located on DND lands. Our inventory provides information on the base name, location, tank type & capacity, tank contents, tank class, date of tank installation, date tank last used, and status of tank as of May 2001. This database will no longer be updated due to the new National Security protocols which have prohibited any release of this

National Defence & Canadian Forces Spills:

The Department of National Defence and the Canadian Forces maintains an inventory of spills to land and water. All spill sites have been classified under the "Transportation of Dangerous Goods Act - 1992". Our inventory provides information on the facility name, location, spill ID #, spill date, type of spill, as well as the quantity of substance spilled & recovered.

## National Defence & Canadian Forces Waste Disposal 2001-Apr 2007\* Federal NDWD Sites:

The Department of National Defence and the Canadian Forces maintains an inventory of waste disposal sites located on DND lands. Where available, our inventory provides information on the base name, location, type of waste received, area of site, depth of site, year site opened/closed and status.

### National Environmental Emergencies System 1974-2003\* Federal NEES (NEES):

In 2000, the Emergencies program implemented NEES, a reporting system for spills of hazardous substances. For the most part, this system only captured data from the Atlantic Provinces, some from Quebec and Ontario and a portion from British Columbia. Data for Alberta, Saskatchewan, Manitoba and the Territories was not captured. However, NEES is also a repository for all previous Environment Canada spill datasets. NEES is composed of the historic datasets ' or Trends ' which dates from approximately 1974 to present. NEES Trends is a compilation of historic databases, which were merged and includes data from NATES (National Analysis of Trends in Emergencies System), ARTS (Atlantic Regional Trends System), and NEES. In 2001, the Emergencies Program determined that variations in reporting regimes and requirements between federal and provincial agencies made national spill reporting and trend analysis difficult to achieve. As a consequence, the department has focused efforts on capturing data on spills of substances which fall under its legislative authority only (CEPA and FA). As such, the NEES database will be decommissioned in December 2004.

National PCB Inventory:

1988-2008\* Federal NPCB

Environment Consideral BCB inventory includes information on in use BCB containing agruinment in Canada

Environment Canada's National PCB inventory includes information on in-use PCB containing equipment in Canada including federal, provincial and private facilities. All federal out-of-service PCB containing equipment and all PCB waste owned by the federal government or by federally regulated industries such as airlines, railway companies, broadcasting companies, telephone and telecommunications companies, pipeline companies, etc. are also listed. Although it is not Environment Canada's mandate to collect data on non-federal PCB waste, the National PCB inventory includes some information on provincial and private PCB waste and storage sites. Some addresses provided may be Head Office addresses and are not necessarily the location of where the waste is being used or stored.

National Pollutant Release Inventory:

1993-2011 Federal NPRI
Environment Canada has defined the National Pollutant Release Inventory ("NPRI") as a federal government initiative designed to collect comprehensive national data regarding releases to air, water, or land, and waste transfers for recycling for more than 300 listed substances.

Oil and Gas Wells: 1988-2013 Private OGW

The Nickle's Energy Group (publisher of the Daily Oil Bulletin) collects information on drilling activity including operator and well statistics. The well information database includes name, location, class, status and depth. The main Nickle's database is updated on a daily basis, however, this database is updated on a monthly basis. More information is available at www.nickles.com.

database.

#### Ontario Oil and Gas Wells:

1800-Jul 2013

Provincial

OOGW

In 1998, the MNR handed over to the Ontario Oil, Gas and Salt Resources Corporation, the responsibility of maintaining a database of oil and gas wells drilled in Ontario. The OGSR Library has over 20,000+ wells in their database. Information available for all wells in the ERIS database include well owner/operator, location, permit issue date, well cap date, licence no., status, depth and the primary target (rock unit) of the well being drilled. All geology/stratigraphy table information, plus all water table information is also provide for each well record.

#### Inventory of PCB Storage Sites:

1987-Oct 2004

Provincial

**OPCB** 

The Ontario Ministry of Environment, Waste Management Branch, maintains an inventory of PCB storage sites within the province. Ontario Regulation 11/82 (Waste Management - PCB) and Regulation 347 (Generator Waste Management) under the Ontario EPA requires the registration of inactive PCB storage equipment and/or disposal sites of PCB waste with the Ontario Ministry of Environment. This database contains information on: 1) waste quantities; 2) major and minor sites storing liquid or solid waste; and 3) a waste storage inventory.

Orders: 1994-2013 Provincial ORD

This is a subset taken from Ontario's Environmental Registry (EBR) database. It will include all Orders on the registry such as (EPA s. 17) - Order for remedial work, (EPA s. 18) - Order for preventative measures, (EPA s. 43) - Order for removal of waste and restoration of site, (EPA s. 44) - Order for conformity with Act for waste disposal sites, (EPA s. 136) - Order for performance of environmental measures.

2009

#### Canadian Pulp and Paper:

1999, 2002, 2004, 2005,

Private

PAP

This information is part of the Pulp and Paper Canada Directory. The Directory provides a comprehensive listing of the locations of pulp and paper mills and the products that they produce.

#### Parks Canada Fuel Storage Tanks:

1920-Jan 2005\*

Federal

CFT

Canadian Heritage maintains an inventory of all known fuel storage tanks operated by Parks Canada, in both National Parks and at National Historic Sites. The database details information on site name, location, tank install/removal date, capacity, fuel type, facility type, tank design and owner/operator.

#### Pesticide Register:

1988-Jun 2013

Provincial

PEŞ

The Ontario Ministry of Environment maintains a database of all manufacturers and vendors of registered pesticides.

#### TSSA Pipeline Incidents:

June 2009-Mar 2012

Provincial

PINC

TSSA's Fuels Safety Program administers the Technical Standards & Safety Act 2000, providing fuel-related safety services associated with the safe transportation, storage, handling and use of fuels such as gasoline, diesel, propane, natural gas and hydrogen. Under this Act, TSSA regulates fuel suppliers, storage facilities, transport trucks, pipelines, contractors and equipment or appliances that use fuels. This database will include spills, strike and leaks from recorded by the TSSA.

#### Private and Retail Fuel Storage Tanks:

1989-1996\*

Provincial

PRT

The Fuels Safety Branch of the Ontario Ministry of Consumer and Commercial Relations maintained a database of all registered private fuel storage tanks and licensed retail fuel outlets. This database includes an inventory of locations that have gasoline, oil, waste oil, natural gas and/or propane storage tanks on their property. The MCCR no longer collects this information. This information is now collected by the Technical Standards and Safety Authority (TSSA).

#### Permit to Take Water:

1994-2013

Provincial

<u>' | | VV</u>

This is a subset taken from Ontario's Environmental Registry (EBR) database. It will include all PTTW's on the registry such as OWRA s. 34 - Permit to take water.

#### Ontario Regulation 347 Waste Receivers Summary:

Provincial

**REC** 

Part V of the Ontario Environmental Protection Act ("EPA") regulates the disposal of regulated waste through an operating waste management system or a waste disposal site operated or used pursuant to the terms and conditions of a Certificate of Approval or a Provisional Certificate of Approval. Regulation 347 of the Ontario EPA defines a waste receiving site as any site or facility to which waste is transferred by a waste carrier. A receiver of regulated waste is required to register the waste receiving facility. This database represents registered receivers of regulated wastes, identified by registration number, company name and address, and includes receivers of waste such as: landfills, incinerators, transfer stations, PCB storage sites, sludge farms and water pollution control plants. This information is a summary of all years from 1986 including the most currently available data.

#### **Record of Site Condition:**

1997-Sept 2001, Oct 2004-

Provincial

**RSC** 

Jan 2014

1986-2012

The Record of Site Condition (RSC) is part of the Ministry of the Environment's Brownfields Environmental Site Registry. Protection from environmental cleanup orders for property owners is contingent upon documentation known as a record of site condition (RSC) being filed in the Environmental Site Registry. In order to file an RSC, the property must have been properly assessed and shown to meet the soil, sediment and groundwater standards appropriate for the use (such as residential) proposed to take place on the property. The Record of Site Condition Regulation (O. Reg. 153/04) details requirements related to site assessment and clean up.

RSCs filed after July 1, 2011 will also be included as part of the new (O.Reg. 511/09).

#### Retail Fuel Storage Tanks:

1999-Jun 2010

Private

RST

This database includes an inventory of retail fuel outlet locations (including marinas) that have on their property gasoline, oil, waste oil, natural gas and / or propane storage tanks.

#### Scott's Manufacturing Directory:

1992-Mar 2011

Private

<u>SCT</u>

Scott's Directories is a data bank containing information on over 200,000 manufacturers across Canada. Even though Scott's listings are voluntary, it is the most comprehensive database of Canadian manufacturers available. Information concerning a company's address, plant size, and main products are included in this database.

Ontario Spills: 1988-Jun 2013 Provincial SPL

This database identifies information such as location (approximate), type and quantity of contaminant, date of spill, environmental impact, cause, nature of impact, etc. Information from 1988-2002 was part of the ORIS (Occurrence Reporting Information System). The SAC (Spills Action Centre) handles all spills reported in Ontario. Regulations for spills in Ontario are part of the MOE's Environmental Protection Act, Part X.

#### Wastewater Discharger Registration Database:

1990-2011

Provincial

SRDS

Information under this heading is combination of the following 2 programs. The Municipal/Industrial Strategy for Abatement (MISA) division of the Ontario Ministry of Environment maintained a database of all direct dischargers of toxic pollutants within nine sectors including: Electric Power Generation; Mining; Petroleum Refining; Organic Chemicals; Inorganic Chemicals; Pulp & Paper; Metal Casting; Iron & Steel; and Quarries. All sampling information is now collected and stored within the Sample Result Data Store (SRDS).

#### Anderson's Storage Tanks:

1915-1953\*

Private

**TANK** 

The information provided in this database was collected by examining various historical documents, which identified the location of former storage tanks, containing substances such as fuel, water, gas, oil, and other various types of miscellaneous products. Information is available in regard to business operating at tank site, tank location, permit year, permit & installation type, no. of tanks installed & configuration and tank capacity. Data contained within this database pertains only to the city of Toronto and is not warranted to be complete, exhaustive or authoritative. The information was collected for research purposes only.

#### Transport Canada Fuel Storage Tanks:

1970-Mar 2007

Federal

TCFT

With the provinces of BC, MB, NB, NF, ON, PE, and QC; Transport Canada currently owns and operates 90 fuel storage tanks. Our inventory provides information on the site name, location, tank age, capacity and fuel type.

### TSSA Variances for Abandonment of Underground Storage Tanks:

Current to Jun 2013

Provincial

VAR

The TSSA, Under the Liquid Fuels Handling Code and the Fuel Oil Code, all underground storage tanks must be removed within two years of disuse. If removal of a tank is not feasible, you may apply to seek a variance from this code requirement. This is a list of all variances granted for abandoned tanks.

#### Waste Disposal Sites - MOE CA Inventory:

1970-Jan 2014

Provincial

**WDS** 

The Ontario Ministry of Environment, Waste Management Branch, maintains an inventory of known open (active or inactive) and closed disposal sites in the Province of Ontario. Active sites maintain a Certificate of Approval, are approved to receive and are receiving waste. Inactive sites maintain Certificate(s) of Approval but are not receiving waste. Closed sites are not receiving waste. The data contained within this database was compiled from the MOE's Certificate of Approval database. Locations of these sites may be cross-referenced to the Anderson database described under ERIS's Private Source Database section, by the CA number. All new Environmental Compliance Approvals handed out after Oct 31, 2011 for Waste Disposal Sites will still be found in this database.

### Waste Disposal Sites - MOE 1991 Historical Approval Up to Oct 1990\* Inventory:

Provincial

**WDSH** 

In June 1991, the Ontario Ministry of Environment, Waste Management Branch, published the "June 1991 Waste Disposal Site Inventory", of all known active and closed waste disposal sites as of October 30st, 1990. For each "active" site as of October 31st 1990, information is provided on site location, site/CA number, waste type, site status and site classification. For each "closed" site as of October 31st 1990, information is provided on site location, site/CA number, closure date and site classification. Locations of these sites may be cross-referenced to the Anderson database described under ERIS's Private Source Database section, by the CA number.

#### Water Well Information System:

1955-May 2013

Provincial

**WWIS** 

This database describes locations and characteristics of water wells found within Ontario in accordance with Regulation 903. It includes such information as coordinates, construction date, well depth, primary and secondary use, pump rate, static water level, well status, etc. Also included are detailed stratigraphy information, approximate depth to bedrock and the approximate depth to the water table.

#### **Definitions**

<u>Database Descriptions:</u> This section provides a detailed explanation for each database including: source, information available, time coverage, and acronyms used. They are listed in alphabetic order.

**<u>Detail Report</u>**: This is the section of the report which provides the most detail for each individual record. Records are summarized by location, starting with the project property followed by records in closest proximity.

**<u>Distance:</u>** The distance value is the distance between plotted points, not necessarily the distance between the sites' boundaries". All values are an approximation.

**<u>Direction:</u>** The direction value is the compass direction of the site in respect to the project property and/or center point of the report.

**Elevation:** The elevation value is taken from the location at which the records for the site address have been plotted. All values are an approximation. Source: Google Elevation API.

**Executive Summary:** This portion of the report is divided into 3 sections:

'Report Summary'- Displays a chart indicating how many records fall on the project property and, within the report search radii.

'Site Report Summary'-Project Property'- This section lists all the records which fall on the project property. For more details, see the 'Detail Report' section.

'Site Report Summary-Surrounding Properties'- This section summarizes all records on adjacent properties, listing them in order of proximity from the project property. For more details, see the 'Detail Report' section.

**Map Key:** The map key number is assigned according to closest proximity from the project property. Map Key numbers always start at #1. The project property will always have a map key of '1' if records are available. If there is a number in brackets beside the main number, this will indicate the number of records on that specific property. If there is no number in brackets, there is only one record for that property.

The symbol and colour used indicates 'elevation': the red inverted triangle will dictate 'ERIS Sites with Lower Elevation', the yellow triangle will dictate 'ERIS Sites with Higher Elevation' and the orange square will dictate 'ERIS Sites with Same Elevation.'

<u>Unplottables:</u> These are records that could not be mapped due to various reasons, including limited geographic information. These records may or may not be in your study area, and were included as reference.

Order #: 20140214020




100 NUGGET AVENUE, TORONTO, ONTARIO M1S 3A7 • TEL: (416) 754-8515 • FAX: (416) 754-8516

,	BARRIE	MISSISSAUGA	OSHAWA	NEWMARKET	GRAVENHURST	PETERBOROUGH	HAMILTON
	TEL: (705) 721-7863	TEL: (905) 542-7605	TEL: (905) 440-2040	TEL: (905) 853-0647	TEL: (705) 684-4242	TEL: (905) 440-2040	TEL: (905) 777-7956
	FAX: (705) 721-7864	FAX: (905) 542-2769	FAX: (905) 725-1315	FAX: (416) 754-8516	FAX: (705) 684-8522	FAX: (905) 725-1315	FAX: (905) 542-2769

#### APPENDIX 'E'

**AERIAL PHOTOGRAPHS** 

REFERENCE NO. 1410-E133

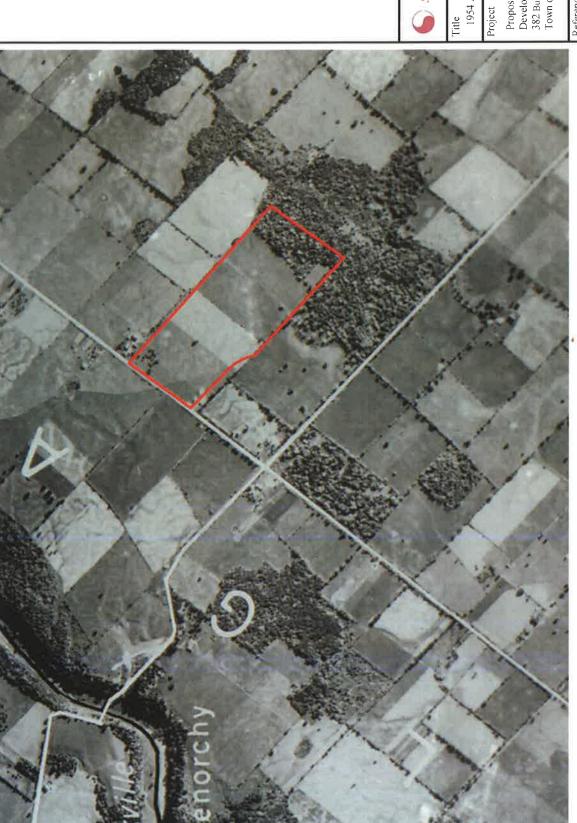



1954 Aerial Photograph

Proposed Residential Development 382 Burnhamthorpe Rd W Town of Oakville

Reference No. 1410-E133


Date February 20, 2014

Scale As Drawn

Appendix 'E'

Approximate Location of the Phase one Property

Source: Toronto Robarts Library © 1954 Digital Aerial Photographs, Southern Ontario

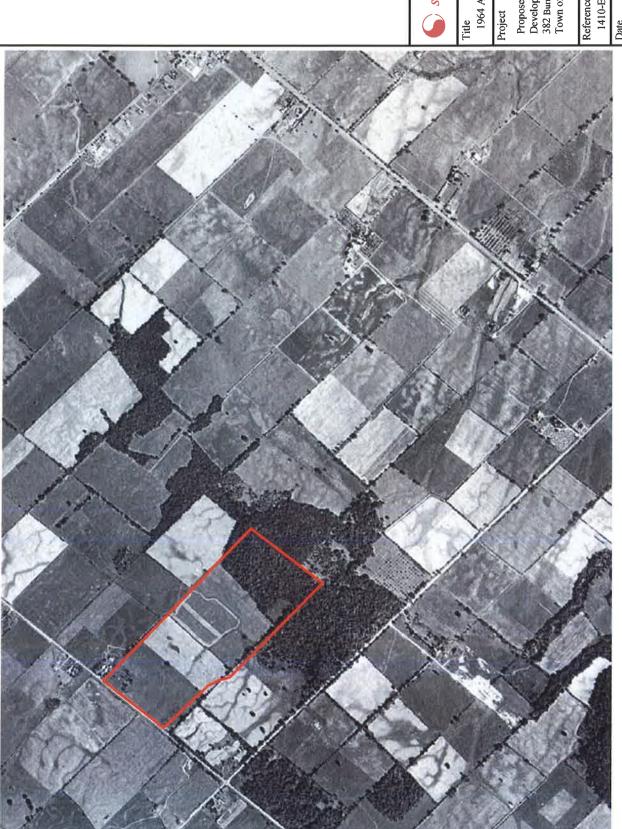

1964 Aerial Photograph

Proposed Residential Development 382 Bunnamthorpe Rd W Town of Oakville

Reference No. 1410-E133

Date February 20, 2014


Scale As Drawn

Appendix 'E'

2 of 7

Approximate Location of the Phase one Property

Source: National Air Photograph Library © 1964 Norwest Survey Corporation Limited

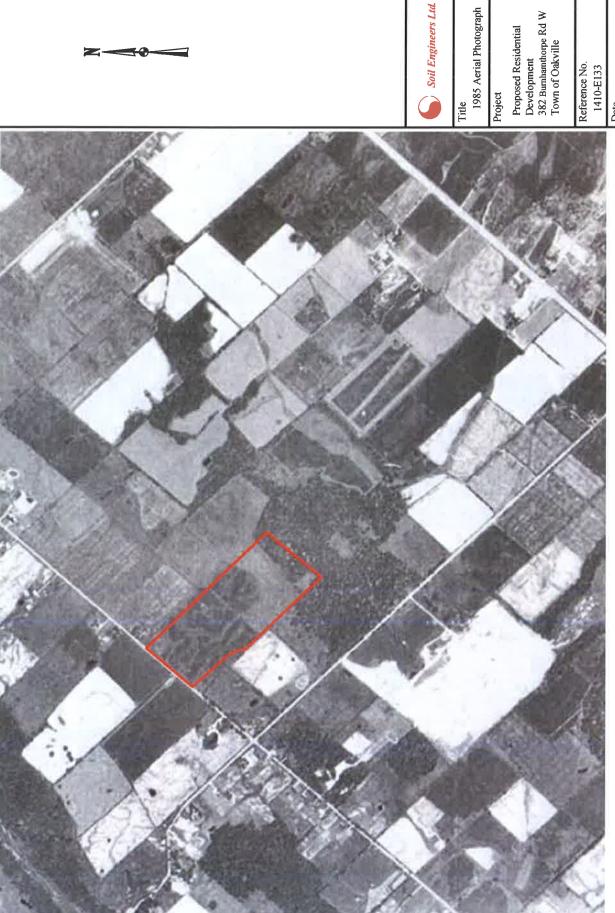

1985 Aerial Photograph

Reference No. 1410-E133

Date February 20, 2014

Scale As Drawn

Appendix 'E'

3 of 7

Approximate Location of the Phase one Property

Source: National Air Photograph Library © 1985 Norwest Survey Corporation Limited





1994 Aerial Photograph

Proposed Residential Development 382 Burnhamthorpe Rd W Town of Oakville

# Reference No. 1410-E133

Date February 20, 2014

# Scale As Drawn

Appendix 'E'

4 of 7

Approximate Location of the Phase one Property

Source: National Air Photograph Library © 1994 Norwest Survey Corporation Limited



Title 1999 Aerial Photograph

Proposed Residential Development 382 Burnhamthorpe Rd W Town of Oakville

Reference No. 1410-E133

Date February 20, 2014

Scale 1:8000

Appendix 'E' 5 of 7

Approximate Location of the Phase one Property





Title 2005 Aerial Photograph

# Project

Proposed Residential Development 382 Burnhamthorpe Rd W Town of Oakville

# Reference No. 1410-E133

Date February 20, 2014

# Scale 1:8000

Appendix 'E'

6 of 7



2012 Aerial Photograph

Proposed Residential Development 382 Burnhamthorpe Rd W Town of Oakville

# Reference No. 1410-E133

Date February 20, 2014

Scale 1:8000

Appendix 'E' 7 of 7

Approximate Location of the Phase one Property

Source: Explore Oakville @ Town of Oakville Interactive Map 2013



100 NUGGET AVENUE, TORONTO, ONTARIO M1S 3A7 • TEL: (416) 754-8515 • FAX: (416) 754-8516

BARRIE	MISSISSAUGA	OSHAWA	NEWMARKET	GRAVENHURST	PETERBOROUGH	HAMILTON
TEL: (705) 721-7863	TEL: (905) 542-7605	TEL: (905) 440-2040	TEL: (905) 853-0647	TEL: (705) 684-4242	TEL: (905) 440-2040	TEL: (905) 777-7956
FAX: (705) 721-7864	FAX: (905) 542-2769	FAX: (905) 725-1315	FAX: (416) 754-8516	FAX: (705) 684-8522	FAX: (905) 725-1315	FAX: (905) 542-2769

#### APPENDIX 'F'

**MOE WELL RECORDS** 

REFERENCE NO. 1410-E133

#### Ministry of the Environment

Wells Help Desk Environmental Monitoring and Reporting Branch

125 Resources Road Toronto ON M9P 3V6 (Toll Free) 1-888-396-9355 (follow prompts 1, 3) Fax: 416-235-5960 WellsHelpdesk@Ontario.ca

#### Ministère de l'Environnement

Service d'information sur les puits Direction de la surveillance environnementale

125 Resources Road Toronto (Ontario) M9P 3V6 Téléphone : 1 888 396-9355 – Faites ensuite le 2 et le 3 (sans frais en Ontario) Télécopieur : 416 235-5960 WellsHelpdesk@Ontario.ca



#### Computer Print-Out Data Well Search Request – Form B Reference Number 1314-1478Bs

March 3, 2014

Soil Engineers Ltd. 100 Nugget Avenue Toronto, ON M1S 3A7 Attn: Jenny Park

440 754 0540

Fax: : 416-754-8516 Email Address: jenny@soilengineersltd.com	
File/Reference No. : 1410-E133	
Search by UTM Coordinates	
(0.63km radius) Easting 600566 Northing 4814774	
County:	
Township:	
Conc.:	
Lot:	
No Well Record found matching the search criteria provided	

If you have any questions or concerns please contact the **Wells Help Desk**\*\*\* SEARCH REQUEST FORMS AVAILABLE AT <u>www.forms.ssb.gov.on.ca</u> \*\*\*

Please note: The Ministry cannot and does not represent or guarantee that the Well Records information is current, accurate or complete. The Ministry assumes no responsibility for errors or omissions in the Well Records information and is not liable in any way for damages of any kind arising out of or related to the Well Records information or for delay or failure to provide the Well Records information. Any reliance upon the Well Records information provided is solely at the risk of the requester. Well Information provided is subject to the Freedom of Information and Protection of Privacy Act (FIPPA), Ontario.

4
<u> </u>
0
$\mathcal{C}$
3
March
of
as
Data
Out
Print
Computer
=
Wel

$Page: 1/2 \\ \text{SCREEN} \qquad \text{Well \# (AUDIT\#) Well Tag \# STATE}^2 \\ \text{INFO}^{10} \qquad \text{DEPTHS TO WHICH FORMATIONS EXTEND}^5,11}$	7135912 (Z01650) A BLDR 0017 0026 GRVL 0027 0027	2802139 () CLAY 0032 RED SHLE 0050	2802142 () LOAM 0001 BRWN CLAY 0018 BLUE CLAY STNS 0034 RED SHLE 0050	2802214 () CLAY 0034 SHLE 0055	2804788 () BRWN CLAY 0023 RED CLAY 0044 RED SHLE 0070	7102652 (Z62483) A056727 BLCK LOAM 0003 GREY SILT CLAY DRY 0010 RED SILT CLAY DNSE 0015	7100722 (M00406) A013306 A
WATER USE <sup>9</sup>	NU	DO	DO	DO	OD		
Well Computer Print Out Data as of March 3 2014  DATE 2 CASING WATER 5,6 STAT LVL/PUMP LVL7  CNTR 3 DIA 4 DETAIL RATE B/TIME HR:MIN	003 /	008 / 050 001 / 1:0	015 / 031 004 / 2:0	015 / / :0	028 / 070 001 / 2:0		
Out Data a water <sup>5,6</sup> detail		FR 0046	FR 0047	FR 0053	FR 0062		
ter Print CASING DIA 4		90 90	90 50	90 90	90	00	
'ell Compui DATE <sup>2</sup> CNTR <sup>3</sup>	2009/11 7140	1959/05 4602	1967/09 1612	1956/10 1642	1975/08	2008/02 7241	2007/11 7241
W UIM <sup>1</sup>	17 600397 4815275 W	17 600065 4814686 W	17 599972 4814572 W	17 600076 4814831 W	17 599971 4814693 W	17 600245 4814472 W	17 600282 4814637 W
TOWNSHIP CONCESSION (LOT)	MILTON TOWN (TRAFALG DS N 02(019)	OAKVILLE TOWN DS N 01(020)	OAKVILLE TOWN DS N 01(021)	OAKVILLE TOWN DS N 02(020)	OAKVILLE TOWN DS N 02(021)	OAKVILLE TOWN ()	OAKVILLE TOWN ()

- Notes: 1. UTM in Zone, Easting, Northing and Datum is NAD83,  $\mathbb{L}_1$  UTM estimated from Centroid of Lot, W: UTM not from Lot Centroid
  - 2 6 4 6 9
  - Date Work Completed Well Contractor Licence Number Casing diameter in inches Unit of Depth in Feet See Table 4 for Meaning of Code

- STAT LVL: Static Water Level in Feet; PUMP LVL: Water Level After Pumping in Feet
  Pump Test Rate in GPM, Pump Test Duration in Hour: Minutes See Table 3 for Meaning of Code
  Screen Depth and Length in feet
  See Table 1 and 2 for Meaning of Code
  A: Abandonment; P: Partial Data Entry Only
- 8. 9. 10. 11.

ш. С		No.	1. Core Ma	terial	1. Core Material and Descriptive terms	ive ter	swo			2	2. Core Color
Code	Description .	- Code	Description	Code	Description .	- Code	Code Description	Code	Description	Code	Code Description
BLDR	BOULDERS	FCRD	FRACTURED	IRFM	IRON	PORS	POROUS	SOFT	SOFT	TIHM	WHIT WHITE
BSLT	BASALT	FGRD	FINE-GRAINED	LIMY	LIMY	PRDG	PREVIOUSLY DUG	SPST	SOAPSTONE	GREY	GREY
CGRD	COARSE- GRAINED	FGVL	FINE GRAVEL	LMSN	LIMESTONE	PRDR	PREV. DRILLED	STKY	STICKY	GREN	
CGVL	COARSE GRAVEL	FILL	FILL	LOAM	TOPSOIL	QRTZ	QUARTZITE	SILS	STONES	MTTA	YELLOW
CHRT	CHERT	FLDS	FELDSPAR	LOOS	LOOSE	OSND	QUICKSAND	STNY	STONEY	BRWN	BROWN
CLAY	CLAY	FLNT	FLINT	LTCL	LIGHT- COLOURED	QTZ	QUARTZ	THIK	THICK	RED	RED
CLN	CLEAN	FOSS	FOSILIFEROUS	LYRD	LAYERED	ROCK	ROCK	THIN	THIN	BLCK	BLCK BLACK
CLYY	CLAYEY	FSND	FINE SAND	MARL	MARL	SAND	SAND	TILL	TILL	5	1000
CMTD	CEMENTED	GNIS	GNEISS	MGRD	MEDIUM- GRAINED	SHLE	SHALE	UNKN	UNKNOWN		
CONG	CONGLOMERATE	GRNT	GRANITE	MGVL	MEDIUM GRAVEL	SHLY	SHALY	VERY	VERY		
CRYS	CRYSTALLINE	GRSN	GREENSTONE	MRBL	MARBLE	SHRP	SHARP	WBRG	WATER- BEARING		
CSND	COARSE SAND	GRVL	GRAVEL	MSND	MEDIUM SAND	SHST	SCHIST	WDFR	WOOD		
DKCL	DARK- COLOURED	GRWK	GREYWACKE	MUCK	MUCK	SILT	SILT	WTHD	WEATHERED		
DLMT	DOLOMITE	GVLY	GRAVELLY	OBDN	OVERBURDEN	SLTE	SLATE				
DNSE	DENSE	GYPS	GYPSUM	PCKD	PACKED	SLTY	SILTY				
DRTY	DIRTY	HARD	HARD	PEAT	PEAT	SNDS	SANDSTONE				
DRY	DRY	HPAN	HARDPAN	PGVL	PEA GRAVEL	SNDY	SANDY				

Code	Code Description Code Description	Code	Description
DO	Domestic	OT	Other
ST	Livestock	TH	Test Hole
IR	Irrigation	DE	Dewatering
IN	Industrial	MO	Monitoring
8	Commercial		
MN	Municipal		
PS	Public		
AC	Cooling And A/C		
R	Not Used		

	4. Water Detail	r Det	ail
Code	Code Description Code Description	Code	Description
FR	Fresh	GS	Gas
SA	Salty	IR	Iron
SU	Sulphur		
¥	Mineral		
UK	Unknown		



100 NUGGET AVENUE, TORONTO, ONTARIO M1S 3A7 • TEL: (416) 754-8515 • FAX: (416) 754-8516

#### APPENDIX 'G'

**OCCUPANCY SEARCH** 

REFERENCE NO. 1410-E133



Reference No. 1410-E133
Appendix 'G': Occupancy Records
Please noted that there is no record for this Phase One ESA Report prior to 1976

1991 1985 1981 1976		*\!\	
1996			
2001		×	×
Direction from Site		***************************************	2115-110
Owner/ Company Name	thorpe Road West	4 Comm Integrated Technologies Inc.	All Care Landscape
Address	Burnhamth	382	



100 NUGGET AVENUE, TORONTO, ONTARIO M1S 3A7 • TEL: (416) 754-8515 • FAX: (416) 754-8516

BARRIE	MISSISSAUGA	OSHAWA	NEWMARKET	GRAVENHURST	PETERBOROUGH	HAMILTON
TEL: (705) 721-7863	TEL: (905) 542-7605	TEL: (905) 440-2040	TEL: (905) 853-0647	TEL: (705) 684-4242	TEL: (905) 440-2040	TEL: (905) 777-7956
FAX: (705) 721-7864	FAX: (905) 542-2769	FAX: (905) 725-1315	FAX: (416) 754-8516	FAX: (705) 684-8522	FAX: (905) 725-1315	FAX: (905) 542-2769
FAX: (705) 721-7864	FAX: (905) 542-2769	FAX: (905) 725-1315	FAX: (416) /54-8516	FAX: (103) 004-0322	FAX. (900) 120-1010	TAX. (303) 342-2703

#### APPENDIX 'H'

#### LANDOWNER/TENANT/OCCUPANT QUESTIONNAIRE

REFERENCE NO. 1410-E133

## PHASE I: ENVIRONMENTAL SITE ASSESSMENT Landowner/Tenant/Occupant Questionnaire

Address of Site: 382 Butham thorpe Rd W. Cakville ON  Person Interviewed: Alex Drung Relationship to Site: representative of Method of Interview:  Project No.: Date of Interview: Method of Interview	
How long have you lived/worked at this address?	
Have never lived there	
2. What are the main operations that occur on this site?  Horse state, riding academy, residential dwelling	
3 What activities were previously performed on this site?	
always been that (horse operation / residential dwelling), farming  4. What is the Assessment Roll Number of the site?	
2401-010-030-02610-0000	
To the best of your knowledge, have any of the following occurred, or is presently occurring on the	property;
the state of the s	
5. Foul odours or stained surfaces (such as soil, concrete, asphalt, surrounding stormwater stained surfaces)	,,,,,,,,,,,,,,,,,,,,,,,,,,,,,,,,,,,,,,,
6. Spills, leaks or hazardous materials activities?	
No	
7. Above ground or underground storage tanks (such as those used for for utility, fuel or chemical bove ground differ fuel storage tanks for helse stable, 2 pro	cal)? <b>//41</b> 6
+nhs for dwilling. 8. Specific chemicals located or stored on site in drums, tanks, barrels or sacks?	
No	
9. Previous environmental site assessments completed? If yes what were the results? Was the environmental cleanup?	
No evidence of contimination in connection with	the.
No evidence of contamination in connection without property. No phase 2 ESA is warranted.  No clear up was ever required / done	
No Clear up was ever required /done	

## PHASE I: ENVIRONMENTAL SITE ASSESSMENT Landowner/Tenant/Occupant Questionnaire

10. If the property is served by a well or septic system ar	d heating system? Please specify the location and
age. potable connete Cistern used	of water applying ocated near
10. If the property is served by a well or septic system ar age.  Offile Counte Cistern used  Z Septic + 1/4 S  11. Dumping of hazardous substances or petroleum properts, household garbage, mixed municipal refuse, described to the counterparts.	ducts, unidentified waste materials, automotive emolition debris, fill material from an unknown site?
No	
40. If the residuh and a properties are as house been prove	ough, used as a gasoline station, motor repair
<ol> <li>If the neighbouring properties are or have been previous facility, commercial printing facility, dry cleaners, juni processing or recycling facility or photo developing is</li> </ol>	kyard or landfill, waste treatment, storage, disposal,
$N_0$	
13. Do you know of others who may have knowledge of	the property?
Candice Delia (tenent)	
Additional Comments and Explanations	
No. of the second secon	
The person completing this report affirms that the above	statements and facts are true and correct, based on
his/her current knowledge as of the date completed.	
Alle of	Date Completed (YY-MM-DD)
Signature of person completing questionnaire	Date Completed (YY-MM-DD)



100 NUGGET AVENUE, TORONTO, ONTARIO M1S 3A7 • TEL: (416) 754-8515 • FAX: (416) 754-8516

MISSISSAUGA **OSHAWA** NEWMARKET GRAVENHURST PETERBOROUGH **HAMILTON** BARRIE TEL: (705) 721-7863 TEL: (905) 542-7605 TEL: (905) 440-2040 TEL: (905) 853-0647 TEL: (705) 684-4242 TEL: (905) 440-2040 TEL: (905) 777-7956 FAX: (705) 721-7864 FAX: (905) 542-2769 FAX: (905) 725-1315 FAX: (416) 754-8516 FAX: (705) 684-8522 FAX: (905) 725-1315 FAX: (905) 542-2769

#### APPENDIX 'I'

SITE PHOTOGRAPHS

REFERENCE NO. 1410-E133



General view of the Residence A (facing south)



General view of the Residence B (facing north)

	Title	Project	Reference No.	Date	Appendix 'I'
Soil Engineers Ltd.	Site Photographs	Proposed Residential Development 382 Burnhamthorpe Rd W Town of Oakville	1410-E113	February 20, 2014	Page [ of 6



General view of Phase One Property from Burnhamthorpe Road West (facing south)



View of vacant field & pond and ANSI at south of Residence A (facing south)

	Title	Project	Reference No.	Date	Appendix 'I'
Soil Engineers Ltd.	Site Photographs	Proposed Residential Development 382 Burnhamthorpe Rd W Town of Oakville	1410-E113	February 20, 2014	Page 2 of 6



View of water filtration unit in the basement of Residence A



General view of garage in Residence A

	Title	Project	Reference No.	Date	Appendix 'I'
Soil Engineers Ltd.	Site Photographs	Proposed Residential Development 382 Burnhamthorpe Rd W Town of Oakville	1410-E113	February 20, 2014	Page 3 of 6



General view of garage attached to the stable



General view of an AST at north of the stable (facing northeast)

	Title	Project	Reference No.	Date	Appendix 'I'
Soil Engineers Ltd.	Site Photographs	Proposed Residential Development 382 Burnhamthorpe Rd W Town of Oakville	1410-E113	February 20, 2014	Page 4 of 6



General view of the arena, west of the stable



General view of attached garage to the Residence B (facing northeast)

	Title	Project	Reference No.	Date	Appendix 'l'
Soil Engineers Ltd.	Site Photographs	Proposed Residential Development 382 Burnhamthorpe Rd W Town of Oakville	1410-E113	February 20, 2014	Page 5 of 6



View of septic tanks, east of Residence B



View of a garbage bin at north of the stable (facing west)

	Title	Project	Reference No.	Date	Appendix 'I'
Soil Engineers Ltd.	Site Photographs	Proposed Residential Development 382 Burnhamthorpe Rd W Town of Oakville	1410-E113	February 20, 2014	Page 6 of 6



100 NUGGET AVENUE, TORONTO, ONTARIO M1S 3A7 • TEL: (416) 754-8515 • FAX: (416) 754-8516

BARRIE	MISSISSAUGA	OSHAWA	NEWMARKET	GRAVENHURST	PETERBOROUGH	HAMILTON
TEL: (705) 721-7863	TEL: (905) 542-7605	TEL: (905) 440-2040	TEL: (905) 853-0647	TEL: (705) 684-4242	TEL: (905) 440-2040	TEL: (905) 777-7956
FAX: (705) 721-7864	FAX: (905) 542-2769	FAX: (905) 725-1315	FAX: (416) 754-8516	FAX: (705) 684-8522	FAX: (905) 725-1315	FAX: (905) 542-2769

#### APPENDIX 'J'

TABLE OF CURRENT AND PAST USES

REFERENCE NO. 1410-E133

# TABLE OF PAST AND CURRENT USES 24929-0219

	Name of Owner		Description of Property		Other Observations from	
Year	Lot 19	Lot 20	Use	Property Use	Aerials, Fire Insurance Plans etc.	
1998 to present	Sherborne Lodge Developments Limited		Residential use with green pastures	Residential/green pastures use	Based on the review of 1999, 2005 and 2012 aerial photographs, the Phase One Property appears to be used as a rural residential property with green pastures. Houses and other structures are noted on the Phase One Property during this period.	
1990 - 1998	Firestone, David Morgan Firestone, Bente		Rural Residential	Rural residential use	Based on the review of the 1994 aerial photograph, the Phase One Property appears to be used as a rural residential property with agricultural use.  Houses and other structures are noted on the Phase One Property during this period	
1976 - 1990	Firestone, David Morgan  Firestone, David Morgan  Gdynia Developments     Limited  Sobra Investments     Limited  Anna Marie Madeleine  A. H. Johnston     Ruby Lattice		Agricultural or other use	Agricultural or other use		
1976 - 1990					According to 1954, 1964 and 1985 aerial photographs, the Phase One Property appears to be a part of agricultural lands or vacant lands during this period	
1969 – 1976						
1969						
1955 - 1969						
1948 – 1955						
1920 - 1948	John K. Guthris		Agricultural or other use	Agricultural or other use	No information available	
1905 – 1920	William Dowler					
1899 – 1905	Elizabeth A. Bowbeer					
1899	William A. Bowbeer		Agricultural or other use	Agricultural or other use	Based on the 1877 Historical Map, the Phase One Property appears to be used for agricultural purposes	
1871	George Allen Bowbeer					
1868 - 1871	William S. Bowbeer		No information available	No information available	No information available	
1854 - 1868	William Kaitting & wife					
1845 – 1854	James L. Biggar					
1817 - 1845	Charles Biggar & wife					
1810 - 1817		Daniel Clark				
Prior to 1810		Crown	No information	No information	Part of Lot 20 of the Phase One Property was part of the lands patented to Daniel Clark by the Crown in 1810.	
Prior to 1808	rior to 1808 Crown		available	available	Part of Lot 19 of the Phase One Property was part of the lands patented to Charles Biggar by the Crown in 1808.	