



TREE PRESERVATION NOTES:

- A) ALL EXISTING TREES TO REMAIN ON SITE, OR ON ADJACENT PROPERTIES WHICH MAY BE AFFECTED, SHALL BE PROTECTED WITH HOARDING, I.E. PROTECTIVE FENCING, ERRECTED BEYOND THEIR "DRIP LINE" PRIOR TO THE COMMENCEMENT OF SITE CLEARING AND STRIPPING, TO THE SATISFACTION OF THE LANDSCAPE ARCHITECT AND THE LOCAL AUTHORITY. GROUPS OF TREES AND OTHER EXISTING PLANTINGS TO BE PROTECTED SHALL BE TREATED IN A LIKE MANNER WITH HOARDING AROUND THE ENTIRE CLUMP(S) AREAS WITHIN THE PROTECTIVE FENCING SHALL REMAIN UNDISTURBED AND SHALL NOT BE USED FOR THE STORAGE OF BUILDING MATERIALS, STRUCTURES OR EQUIPMENT. THIS SHALL BE COMPLETED PRIOR TO THE COMMENCEMENT OF SITE CLEARANCE, DEMOLITION, OR ANY TYPE OF CONSTRUCTION.
- B) NO CABLES OF ANY TYPE SHALL BE WRAPPED AROUND OR INSTALLED IN TREES. SURPLUS SOIL, EQUIPMENT, VEHICLES, DEBRIS OR MATERIALS SHALL NOT BE PLACED OVER ROOT SYSTEMS OF THE TREES WITHIN THE PROTECTIVE FENCING. NO CONTAMINANTS WILL BE DUMPED OR FLUSHED WHERE FEEDER ROOTS OF TREES EXIST.
- C) THE DEVELOPER OR THEIR AGENTS SHALL TAKE EVERY PRECAUTION NECESSARY TO PREVENT DAMAGE TO TREES OR SHRUBS TO BE RETAINED.
- D) WHERE LIMBS OR PORTIONS OF TREES ARE REMOVED TO ACCOMMODATE CONSTRUCTION WORK, THEY WILL BE REMOVED CAREFULLY IN ACCORDANCE WITH THE ACCEPTED ARBORICULTURAL PRACTICE. MEASURES SHALL BE TAKEN TO PREVENT ANY FURTHER DAMAGE.
- E) WHERE ROOT SYSTEMS OF PROTECTED TREES ARE EXPOSED OR DAMAGED BY CONSTRUCTION WORK, THEY SHALL BE TRIMMED NEATLY AND THE AREA BACKFILLED WITH APPROPRIATE MATERIAL TO PREVENT DESICCATION.
- F) WHERE NECESSARY, THE TREES WILL BE GIVEN AN OVERALL PRUNING TO RESTORE THE BALANCE BETWEEN ROOTS AND TOP GROWTH OR TO RESTORE THE APPEARANCE OF THE TREES.
- G) IF GRADES AROUND TREES TO BE PROTECTED ARE LIKELY TO CHANGE, THE OWNER SHALL BE REQUIRED TO TAKE SUCH PRECAUTIONS AS DRY WELLING, RETAINING WALLS AND ROOT FEEDING TO THE SATISFACTION OF THE LANDSCAPE ARCHITECT AND THE TOWN OF OAKVILLE.

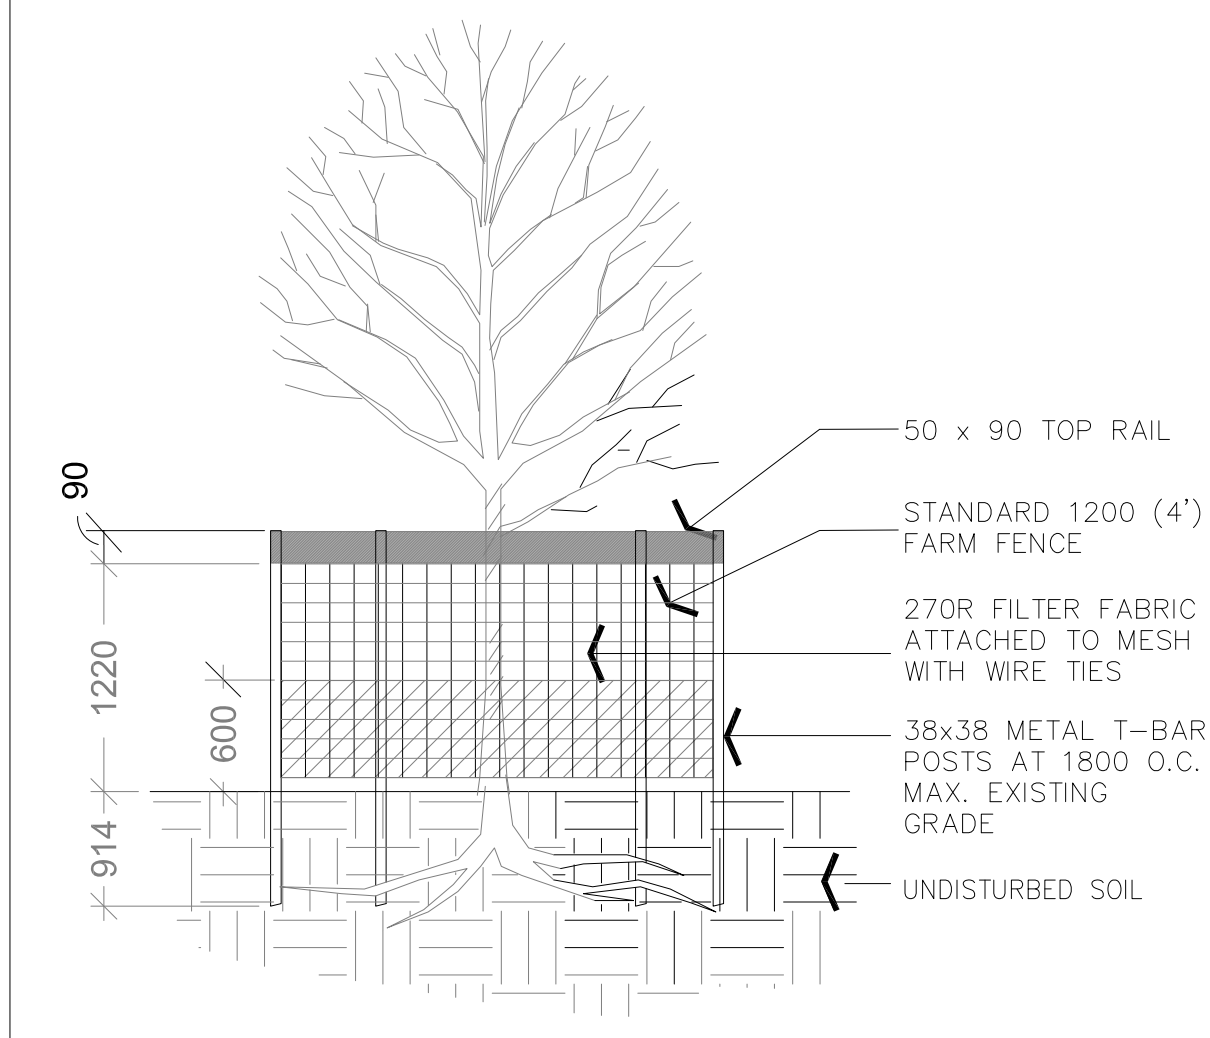

NOTES:
 A) SIGN SHOULD BE MOUNTED ON ALL SIDES OF THE TREE PROTECTION HOARDING FOR THE DURATION OF THE PROJECT.
 THE SIGN WILL BE A MINIMUM OF 400MMX600MM AND MADE OF B) WHITE GATOR BOARD OR EQUIVALENT MATERIAL.

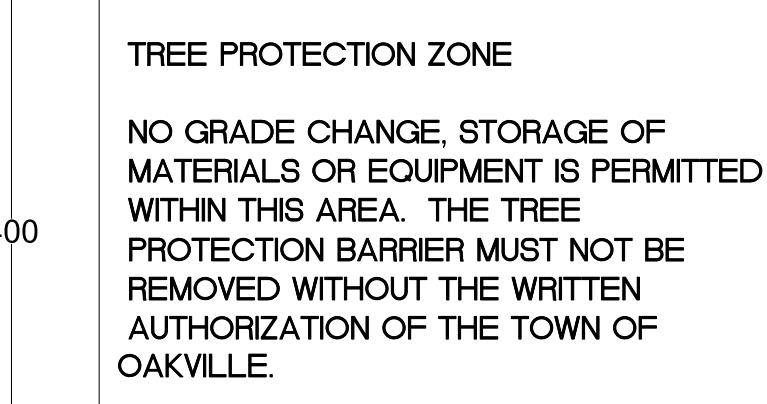

TREE PROTECTION ZONE SIGN

TREE CATEGORIES

1	Trees with diameters of 20cm or more, situated on private property, on the subject site.
2	Trees with diameters of 20cm or more, situated on private property, within 6m of the subject site.
3	Trees of all diameters situated on Town owned parkland within 6m of the subject site.
4	Trees of all diameters situated within the Town road allowance adjacent to the subject site.
Exempt	Trees that are less than 20cm diameter and located on private property.


EXISTING TREE INVENTORY

KEY	SPECIES	CALIPER	CROWN	HEALTH	STRUCTURE	COMMENTS	PRESERVATION	TREE CATEGORY	MIN. TPZ	KEY	
	COMMON NAME	BOTANICAL NAME	IN (cm)	IN (m)	G/F/P		DIRECTION				
1	HONEYLOCUST	<i>Gleditsia triacanthos</i>	15	4	GOOD	ASYMMETRICAL FORM	SLIGHT DIEBACK ON LOWER BRANCHES, CROWN SOMEWHAT ONE SIDED DUE TO ADJACENT RETAINING WALL	PRESERVE	5	1.8	1
2	HONEYLOCUST	<i>Gleditsia triacanthos</i>	13	4	GOOD	ASYMMETRICAL FORM	SLIGHT DIEBACK ON LOWER BRANCHES, CROWN SOMEWHAT ONE SIDED DUE TO ADJACENT RETAINING WALL	PRESERVE	5	1.8	2

GENERAL NOTES

- VERIFY ALL DIMENSIONS.
- DO NOT SCALE DRAWINGS.
- REPORT ANY DISCREPANCIES, DISCOVERED ERRORS, OR OMISSIONS TO THE LANDSCAPE ARCHITECT BEFORE PROCEEDING.
- IT IS ADVISED THAT CONTRACTORS CONTACT THE LANDSCAPE ARCHITECT PRIOR TO CONSTRUCTION TO ENSURE THE USE OF THE LATEST REVISED DRAWINGS.
- DRAWINGS AND SPECIFICATIONS ARE THE PROPERTY OF THE LANDSCAPE ARCHITECT.

KEY MAP

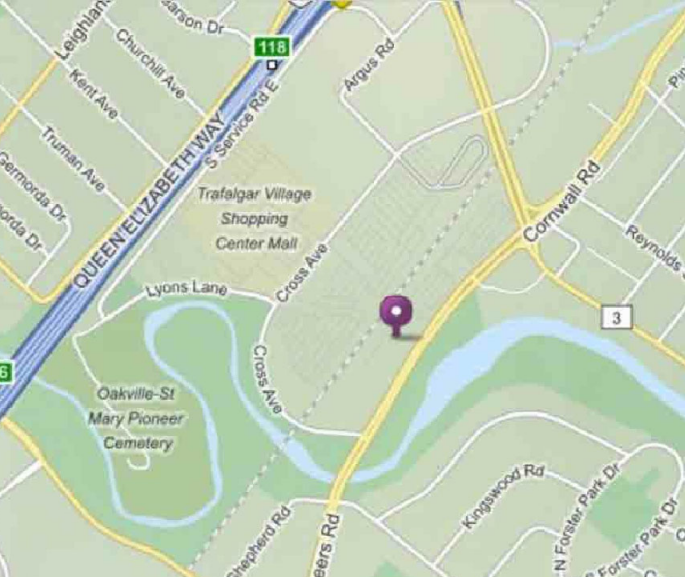


LEGEND

- TREE PROTECTION HOARDING
- EXISTING TREES TO BE PRESERVED
- MINIMUM TREE PROTECTION ZONE
- VEGETATION NUMBER KEY

Matthew C. Gehres
MATTHEW C. GEHRES
 International Society of Arboriculture
 Certified Arborist #CN-1144
 Date: AUGUST 31 2015

No.	DATE	REVISION	BY
18	OCT. 14, 2021	ISSUED FOR OPA/ZBA	SV
17	SEPT. 17, 2021	ISSUED FOR COORDINATION	SV
16	JULY 30, 2019	PLANTING IN BOULEVARD AS PER TOWN COMMENTS	SV
15	JULY 23, 2019	RETAINING WALL PATTERN	SV
14	JUNE 7, 2019	RETAINING WALL PATTERN	SV
13	MAY 22, 2019	RETAINING WALL	SV
12	MAY 1, 2019	BIKE RACK REVISED	SV
11	AUG. 08, 2018	AS PER LATEST TRANSFORMER LOCATION + GRADING PLAN	SV
10	DEC. 06, 2017	ISSUED FOR PERMIT	SV
9	JUN. 19, 2017	REVISED AS PER GRADING PLAN	SV
8	APR. 7, 2017	AS PER CITY COMMENTS	SV
7	APR. 4, 2017	ENTRANCE REVISED	SV
6	MAR. 3, 2017	ISSUED FOR SUBMISSION	SV
5	JAN. 30, 2017	ISSUED FOR SUBMISSION	SV
4	NOV. 21, 2016	AS PER LATEST SITE PLAN + GRADING PLAN	SV
3	MAR. 11, 2016	ISSUED FOR SPA	SV
2	FEB. 26, 2016	AS PER LATEST ARCH PLANS	SV
1	SEPT. 9, 2015	ISSUED FOR SUBMISSION	SV

It is the responsibility of the Contractor and/or Owner to ensure that the drawings with the latest revisions are used for construction.

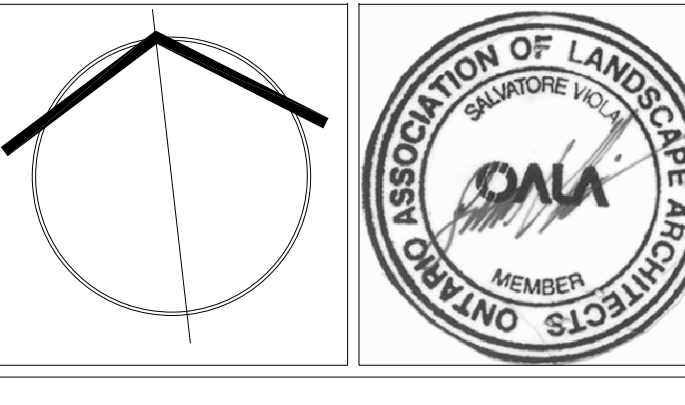

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 MISSISSAUGA, ONTARIO, L4R 3G9
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 WWW.STRYBOS.COM

STRYBOS BARRON KING
 LANDSCAPE ARCHITECTURE

PROJECT:
2317511 ONTARIO LTD.
 345 LAKESHORE RD E, SUITE 402
 OAKVILLE, ON L6J 1J5
 70 OLD MILL ROAD
 OAKVILLE, ONTARIO

DRAWING TITLE:
TREE INVENTORY AND PROTECTION PLAN

SCALE: 1:100	PROJECT No. 4710
DATE: JULY 09, 2015	DRAWING No. V100
DRAWN BY: H.C.Y./J.M.	
CHECKED BY: S.V.	