

_100 OVERALL LANDSCAPE PLAN & KEYPLAN SCAI

L100T TREE INVENTORY, PRESERVATION AND REMOVALS PLAN

L101 MAIN ENTRANCE LAYOUT PLAN AND DETAILS

L102 MAIN ENTRANCE PLANTING PLAN AND DETAILS

L103 TREE CANOPY COVER AND CALCULATION PLAN

L200 LANDSCAPE DETAILS

SCALE: 1:300	
SCALE: 1:300	

SCALE AS NOTED
SCALE AS NOTED

SCALE 1:300

SCALE AS NOTED

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Key	Qty.	Botanical Name	Common Name	Cal.	Sprd.	Hgt.	Root	Remarks
TREES								
Pa	3	Picea Abies	Norw ay Spruce			2000	B&B	
Pg	8	Picea glauca	White Spruce			2000	B&B	Native / Drought Tolerant
Ps	3	Picea strobus	Eastern White Pine			2000	B&B	Native
Qr	2	Quercus rubra	Red Oak	70			B&B	Native / Salt Tolerant

 ^{1. &#}x27;* ' Denotes new trees planted as compensatory trees for the ones being removed. 26 out of 27 new trees are compensatory trees.
 For species refer to plant list. For locations refer to L100 and L102.

2. 22 of the compensatory trees are part of the tree canopy cover contribution. For locations refer to L103.



VERTECHS DESIGN landscape architects

Project Name:

Halton WWTP
Maint Facility
Location:

2195 North Service Rd W, Oakville, ON

Number:

2102

Scale: 1:300


Sheet Title:

OVERALL LANDSCAPE PLAN & KEYPLAN

Date:	2023-03-22		
Legend:			
	PROPERTY LINE	-	CHAIN LINK FENG 1800mm HT
	CONCRETE PAVING	- - FH	FIRE HYDRANT SEE CIVIL
	900x300 UNIT PAVING BY TECHOBLOC	© BL	BOLLARD LIGHT SEE ELECT.
	ACCESSIBLE LIMESTONE SCREENINGS	EV	EV CHARGING PEDESTAL SEE ELECT.
00000000000	TACTILE ATTENTION INDICATOR		SIGNAGE SEE ARCH
	EXISTING LAWN	FR	FIRE ROUNTE SIGNAGE SEE ARCH
	LOW MOW MEADOW	Q Ls	LIGHT STANDARD SEE ELECT.
	NEW SOD	мн	MANHOLE SEE CIVIL
\odot	EXISTING DECIDUOUS TREE TO REMAIN	СВ	CATCH BASIN SEE CIVIL
	EXISTING CONIFEROUS TREE TO REMAIN	FDC 🙏	SIAMESE CONNECTION SEE CIVIL

Issued For:

No.	Description	Date
5	Issued for SPA	2023-0
4	Issued for VE submission	2022-1
3	Issued for Site Plan Approval	2022-0
2	Issued for Class 'C' Costing	2022-0
1	Issued for Coordination	2022-0

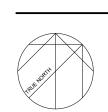

L100

DEVICES SHALL BE FULL CUT-OFF TO DIRECT ILLUMINATION DOWNWARD, DARK SKY COMPLIANT TO REDUCE LIGHT POLLUTION

AND SKYGLARE, AND SHALL BE MITIGATED AT THE


SOURCE SO THAT NO LIGHT


(0.0) WILL BE DIRECTLY

PROJECTED ONTO ADJACENT PROPERTIES. REFER TO ELECTRICAL FOR

LIGHTING PLAN.

Drawing Numbo

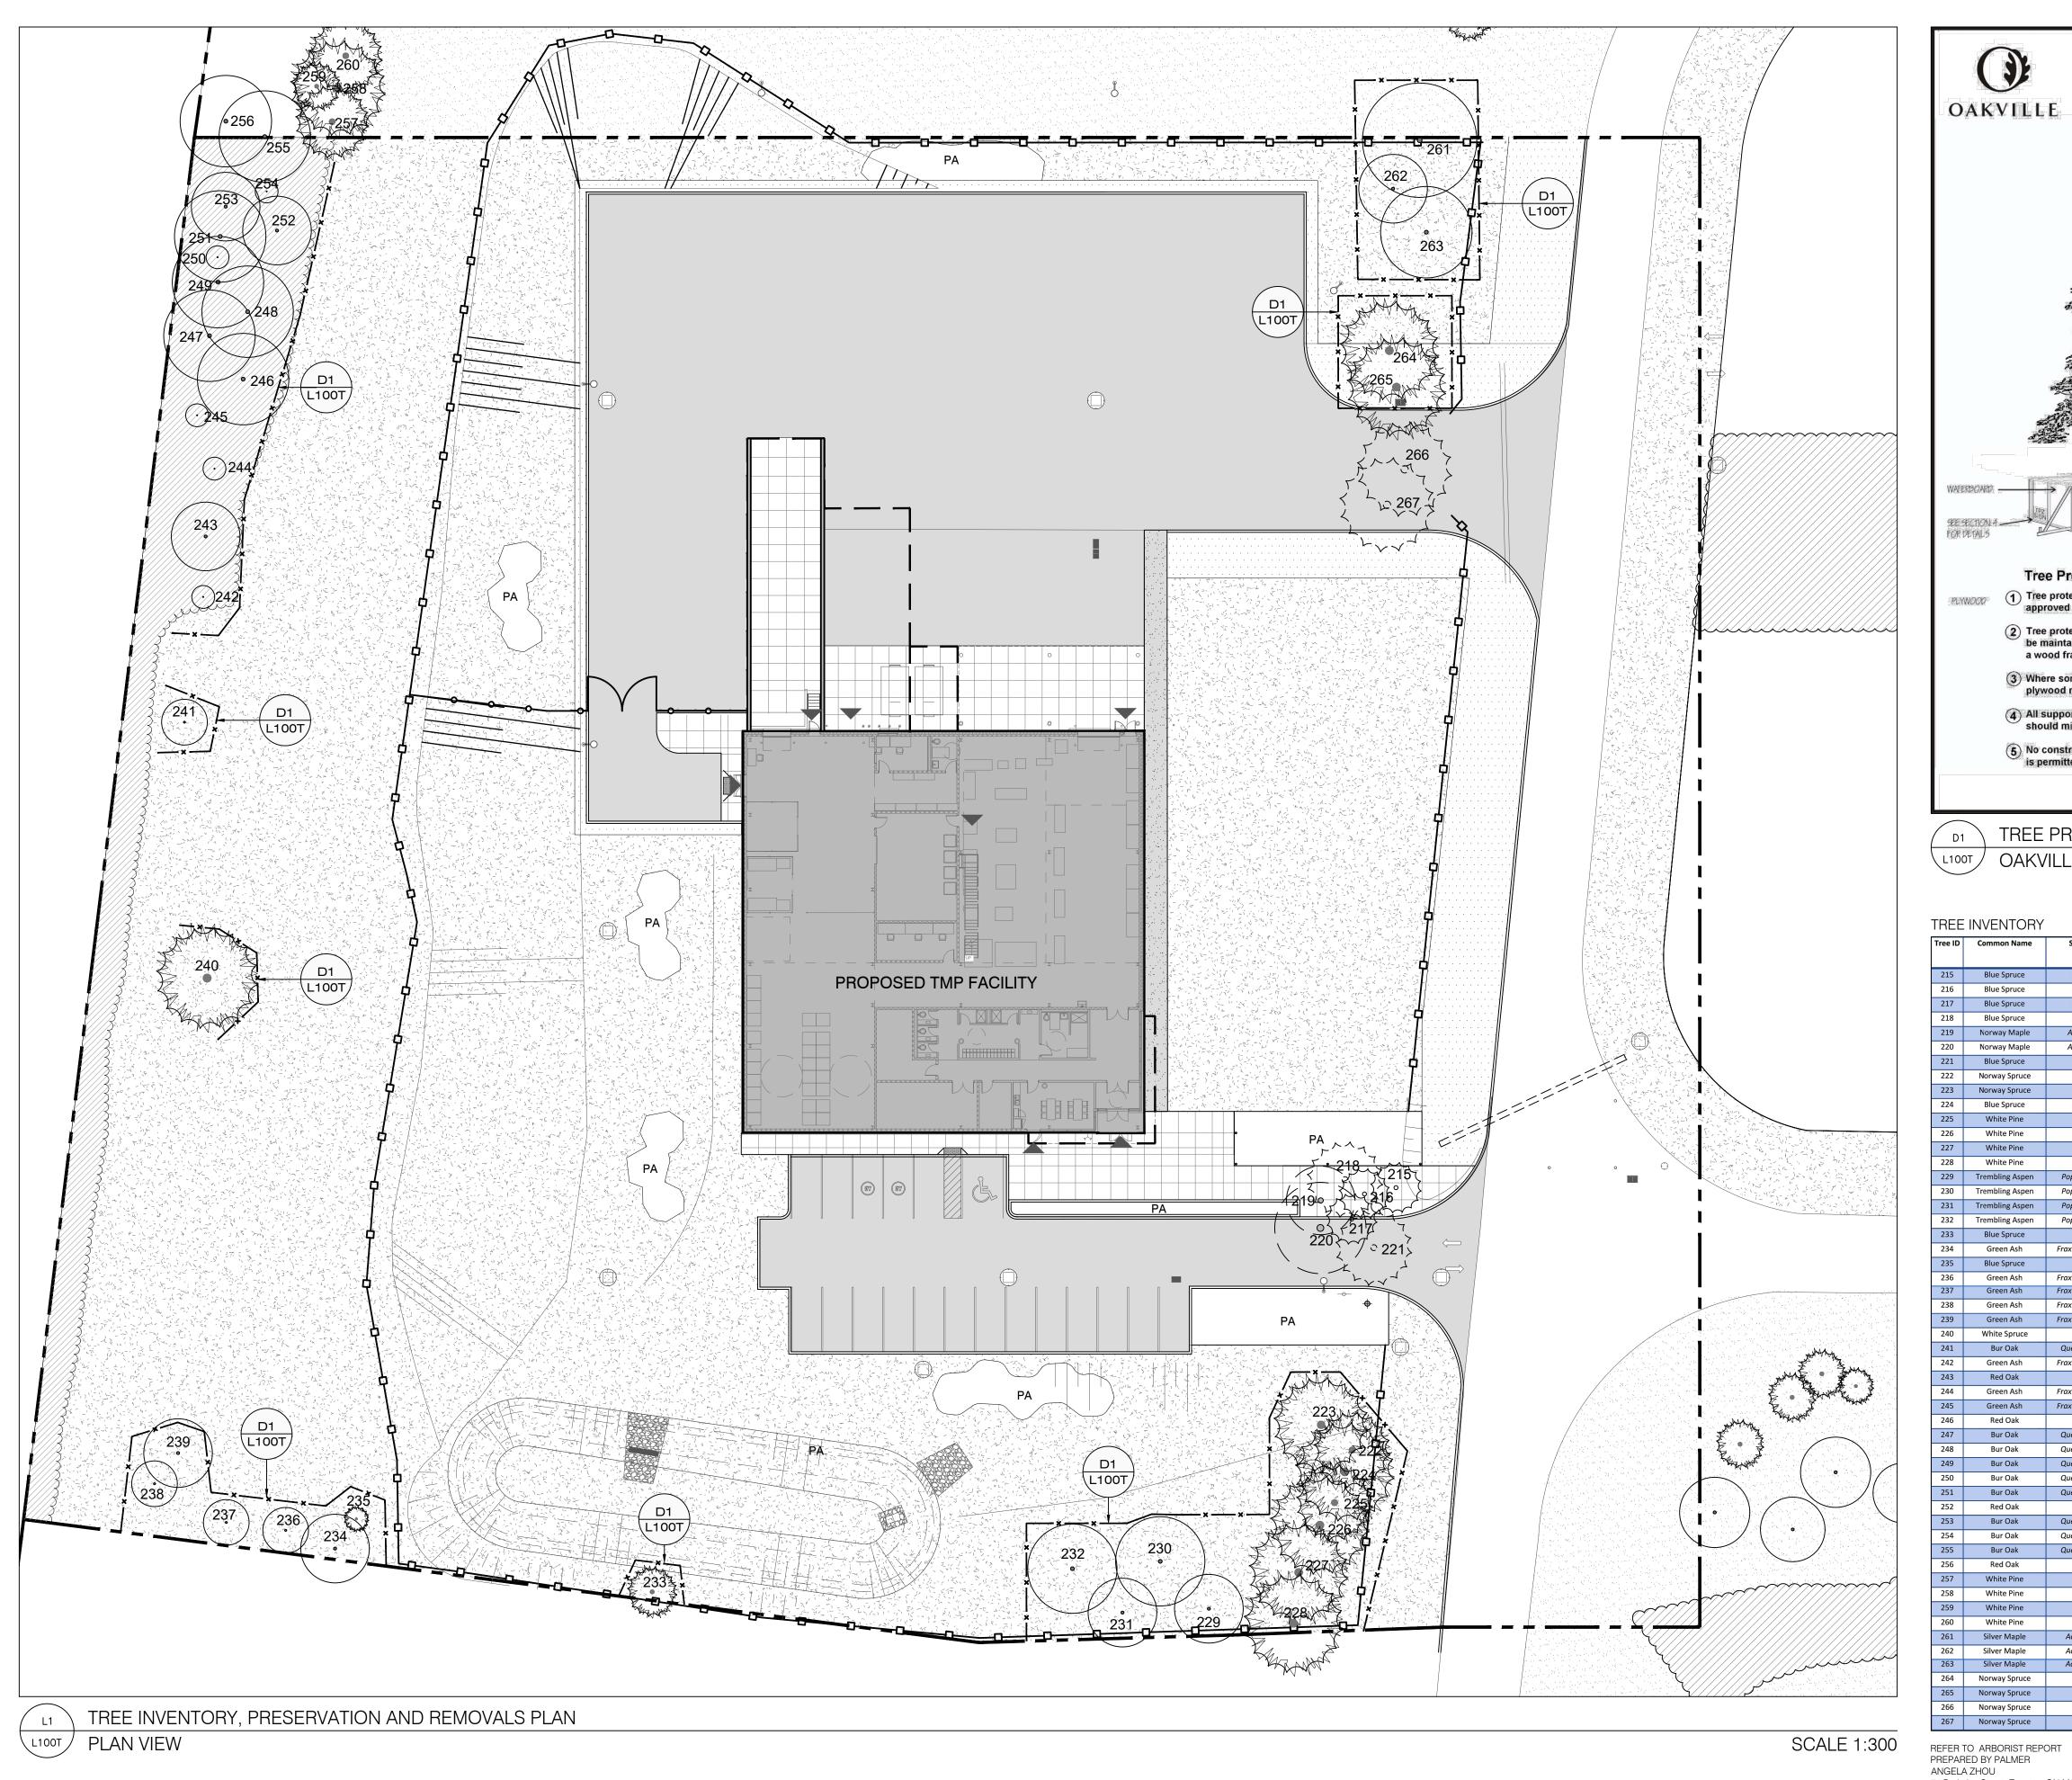

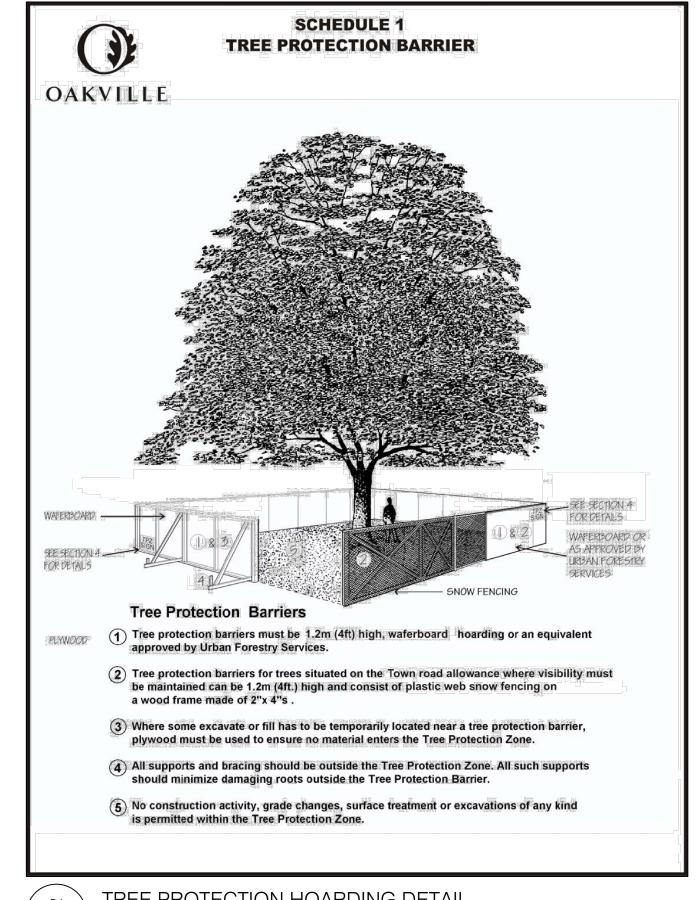

TREE PROTECTION HOARDING DETAIL
OOT OAKVILLE CITY STANDARD

N.T.S.

Tree ID	Common Name	Scientific Name	DBH (cm)	Effective DBH (cm)	Dripline (m)	Condition			TPZ (m)	Proposed Action	
						Structure	Vigour	Overall			
215	Blue Spruce	Picea pungens	18	18	2	G	G	G	2.4	Remove	
216	Blue Spruce	Picea pungens	18	18	2	G	G	G	2.4	Remove	
217	Blue Spruce	Picea pungens	19	19	2	G	F	F	2.4	Remove	
218	Blue Spruce	Picea pungens	25	25	3	G	F	G	2.4	Remove	
219	Norway Maple	Acer platanoides	26	26	3	G	G	G	2.4	Remove	
220	Norway Maple	Acer platanoides	30	30	4	G	F	G	2.4	Remove	
221	Blue Spruce	Picea pungens	27	27	3	G	G	G	2.4	Remove	
222	Norway Spruce	Picea abies	21	21	3	G	G	G	2.4	Retain	
223	Norway Spruce	Picea abies	21	21	4	G	G	G	2.4	Remain	
224	Blue Spruce	Picea pungens	26	26	4	G	G	G	2.4	Retain	
225	White Pine	Pinus strobus	27	27	3	G	G	G	2.4	Retain	
226	White Pine	Pinus strobus	13,16	21	4	G	G	G	2.4	Retain	
227	White Pine	Pinus strobus	22	22	4	G	G	G	2.4	Retain	
228	White Pine	Pinus strobus	32	32	4	G	G	G	3.0	Retain	
229	Trembling Aspen	Populus tremuloides	25,29	38	3	G	Р	F	3.0	Retain	
230	Trembling Aspen	Populus tremuloides	16,32,30	47	4	G	G	G	3.0	Retain	
231	Trembling Aspen	Populus tremuloides	18,23,22	43	3	G	F	F	3.0	Retain	
232	Trembling Aspen	Populus tremuloides	26,18	32	4	G	G	G	3.0	Retain	
233	Blue Spruce	Picea pungens	14	14	2	G	G	G	2.4	Retain	
234	Green Ash	Fraxinus pennsylvanica	14	14	3	G	G	G	2.4	Retain	
235	Blue Spruce	Picea pungens	13	13	1	G	F	F	2.4	Retain	
236	Green Ash	Fraxinus pennsylvanica	15,12	19	2	F	Р	Р	2.4	Retain	
237	Green Ash	Fraxinus pennsylvanica	12	12	2	F	Р	F	2.4	Retain	
238	Green Ash	Fraxinus pennsylvanica	10	10	2	Р	Р	Р	2.4	Retain	۰
239	Green Ash	Fraxinus pennsylvanica	16	16	3	F	G	G	2.4	Retain	ı
240	White Spruce	Picea glauca	18	18	4	G	G	G	2.4	Retain	١
241	Bur Oak	Quercus macrocarpa	10	10	2	G	G	G	2.4	Retain	ĺ
242	Green Ash	Fraxinus pennsylvanica	26,26,24	44	1	Р	VP	VP	3.0	Retain	۱
243	Red Oak	Quercus rubra	10	10	3	G	G	G	2.4	Retain	ı
244	Green Ash	Fraxinus pennsylvanica	16,8	18	1	VP	VP	VP	2.4	Retain	
245	Green Ash	Fraxinus pennsylvanica	30	30	0	D	D	D	2.4	Retain	ĺ
246	Red Oak	Quercus rubra	24	24	4	G	G	G	2.4	Retain	١
247	Bur Oak	Quercus macrocarpa	17	17	4	G	G	G	2.4	Retain	ĺ
248	Bur Oak	Quercus macrocarpa	26,21	33	4	G	G	G	3.0	Retain	٠
249	Bur Oak	Quercus macrocarpa	45	45	4	G	F	F	3.0	Retain	İ
250	Bur Oak	Quercus macrocarpa	20	20	0	D	D	D	2.4	Retain	
251	Bur Oak	Quercus macrocarpa	21	21	4	F	F	F	2.4	Retain	İ
252	Red Oak	Quercus rubra	24,24	34	3	G	G	G	3.0	Retain	
253	Bur Oak	Quercus macrocarpa	24	24	3	G	G	G	2.4	Retain	
254	Bur Oak	Quercus macrocarpa	32	32	0	D	D	D	3.0	Retain	
255	Bur Oak	Quercus macrocarpa	26,15	30	4	Р	G	F	2.4	Retain	
256	Red Oak	Quercus rubra	40	40	4	G	G	G	3.0	Retain	
257	White Pine	Pinus strobus	24	24	3	G	G	G	2.4	Retain	į
258	White Pine	Pinus strobus	23	23	4	G	G	G	2.4	Retain	
259	White Pine	Pinus strobus	12	12	2	G	G	G	2.4	Retain	
260	White Pine	Pinus strobus	24	24	3	G	G	G	2.4	Retain	
261	Silver Maple	Acer saccharinum	28,26	38	5	G	G	G	3.0	Retain	İ
262	Silver Maple	Acer saccharinum	28	28	3	G	G	G	2.4	Retain	
263	Silver Maple	Acer saccharinum	24,28,14	39	4	G	G	G	3.0	Retain	
264	Norway Spruce	Picea abies	32	32	4	G	G	G	3.0	Retain	
265	Norway Spruce	Picea abies	25	25	4	G	G	G	2.4	Potential Injury	ĺ
266	Norway Spruce	Picea abies	22,22	31	4	G	G	G	3.0	Remove	
267	Norway Spruce	Picea abies	26	26	4	G	G	G	2.4	Remove	i

74 Berkeley Street, Toronto, ON M5A 2W7

Tel: 647-795-8153 www.pecg.ca Dated: July 28, 2022 OWNER

Halton
REGION

VERTECHS DESIGN landscape architects

Project Name:

Halton WWTP
Maint Facility
Location:

2195 North Service Rd W, Oakville, ON

Number:

2102

Sheet Title:

TREE INVENTORY, PRESERVATION AND REMOVALS PLAN

Scale: 1:300

Drawn: JJ / IW / RM / YC

Checked: VK / JJ

Date: 2023-03-22

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Legend:

PROPERTY LINE

TREE PROTECTION HOARDING

EXISTING DECIDUOUS TREE TO REMOVE

EXISTING
CONIFER TREE
TO REMOVE

EXISTING
CONIFEROUS TREE

CONIFEROUS TR TO REMAIN

EXISTING TREE
TO REMAIN

TREE NUMBER


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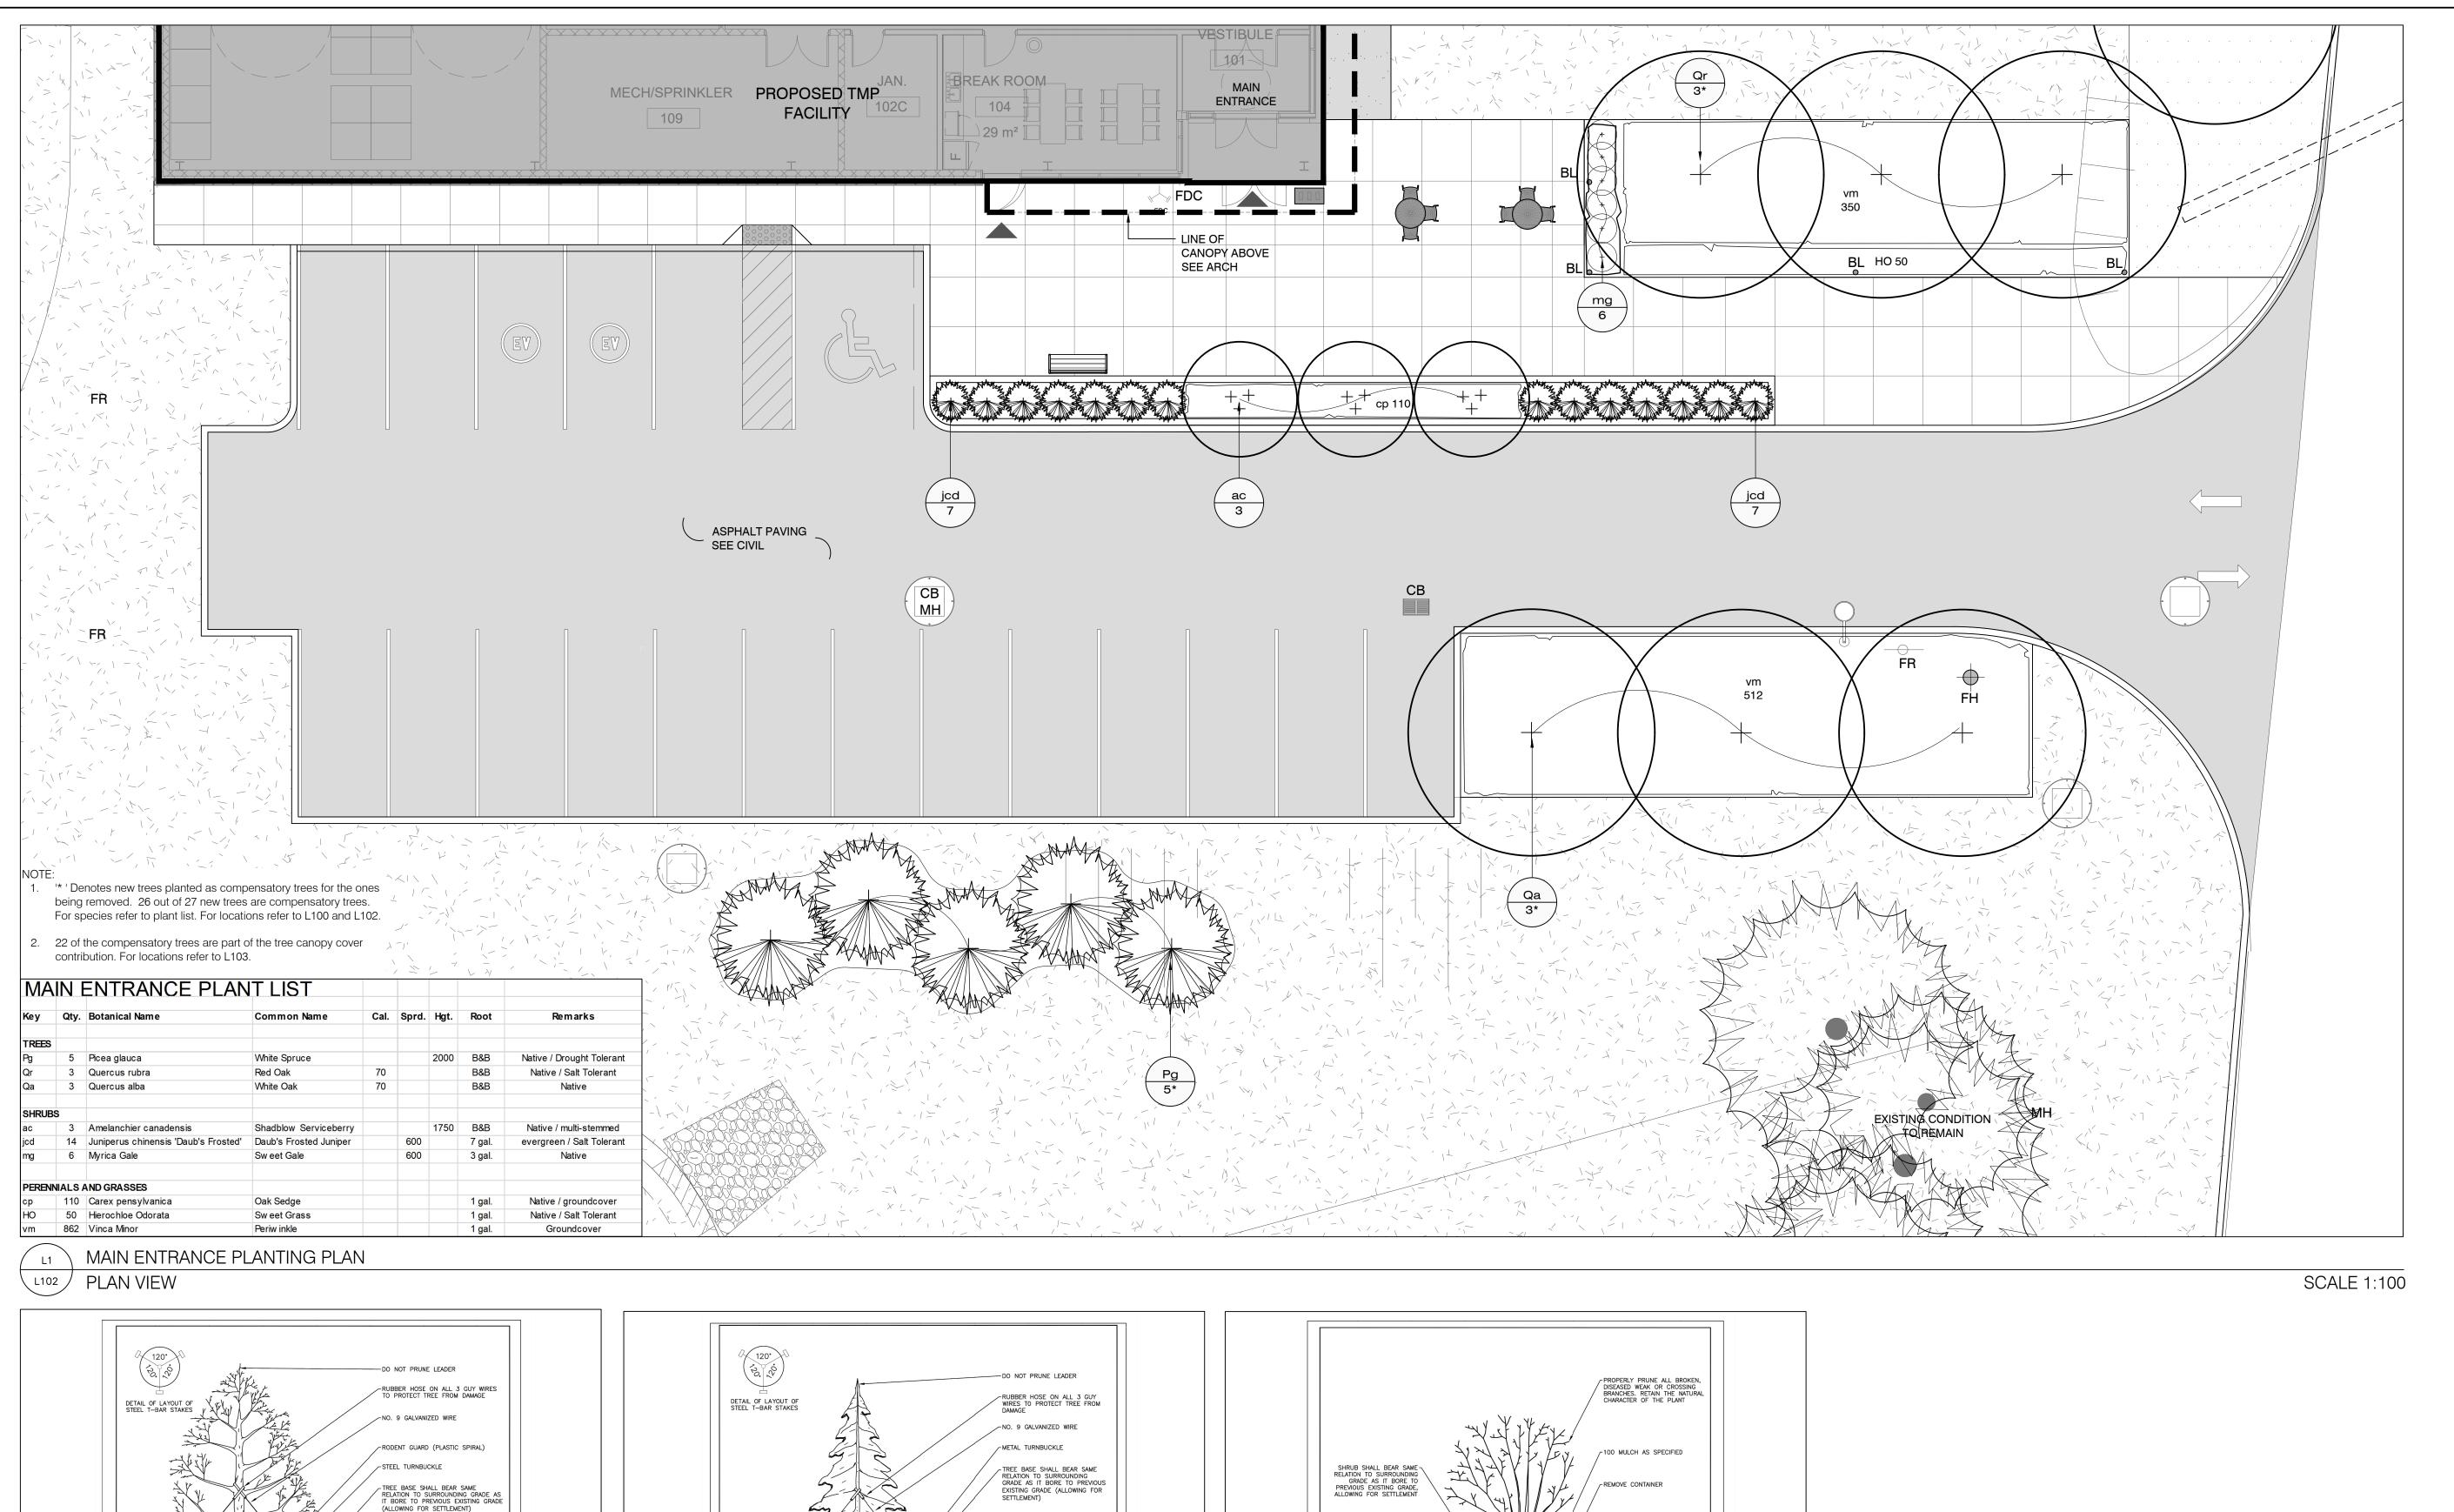
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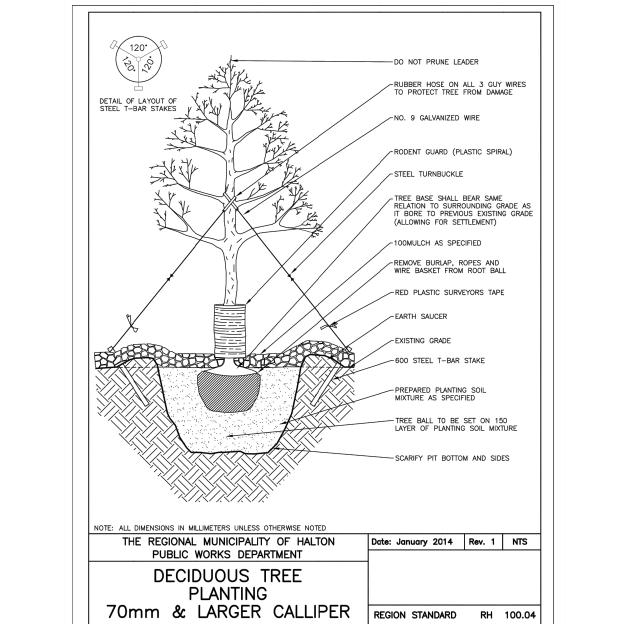
No.	Description	Date
5	Issued for SPA	2023-03-22
4	Issued for VE submission	2022-11-14
3	Issued for Site Plan Approval	2022-08-12
2	Issued for Class 'C' Costing	2022-06-16
1	Issued for Coordination	2022-05-25



L100T





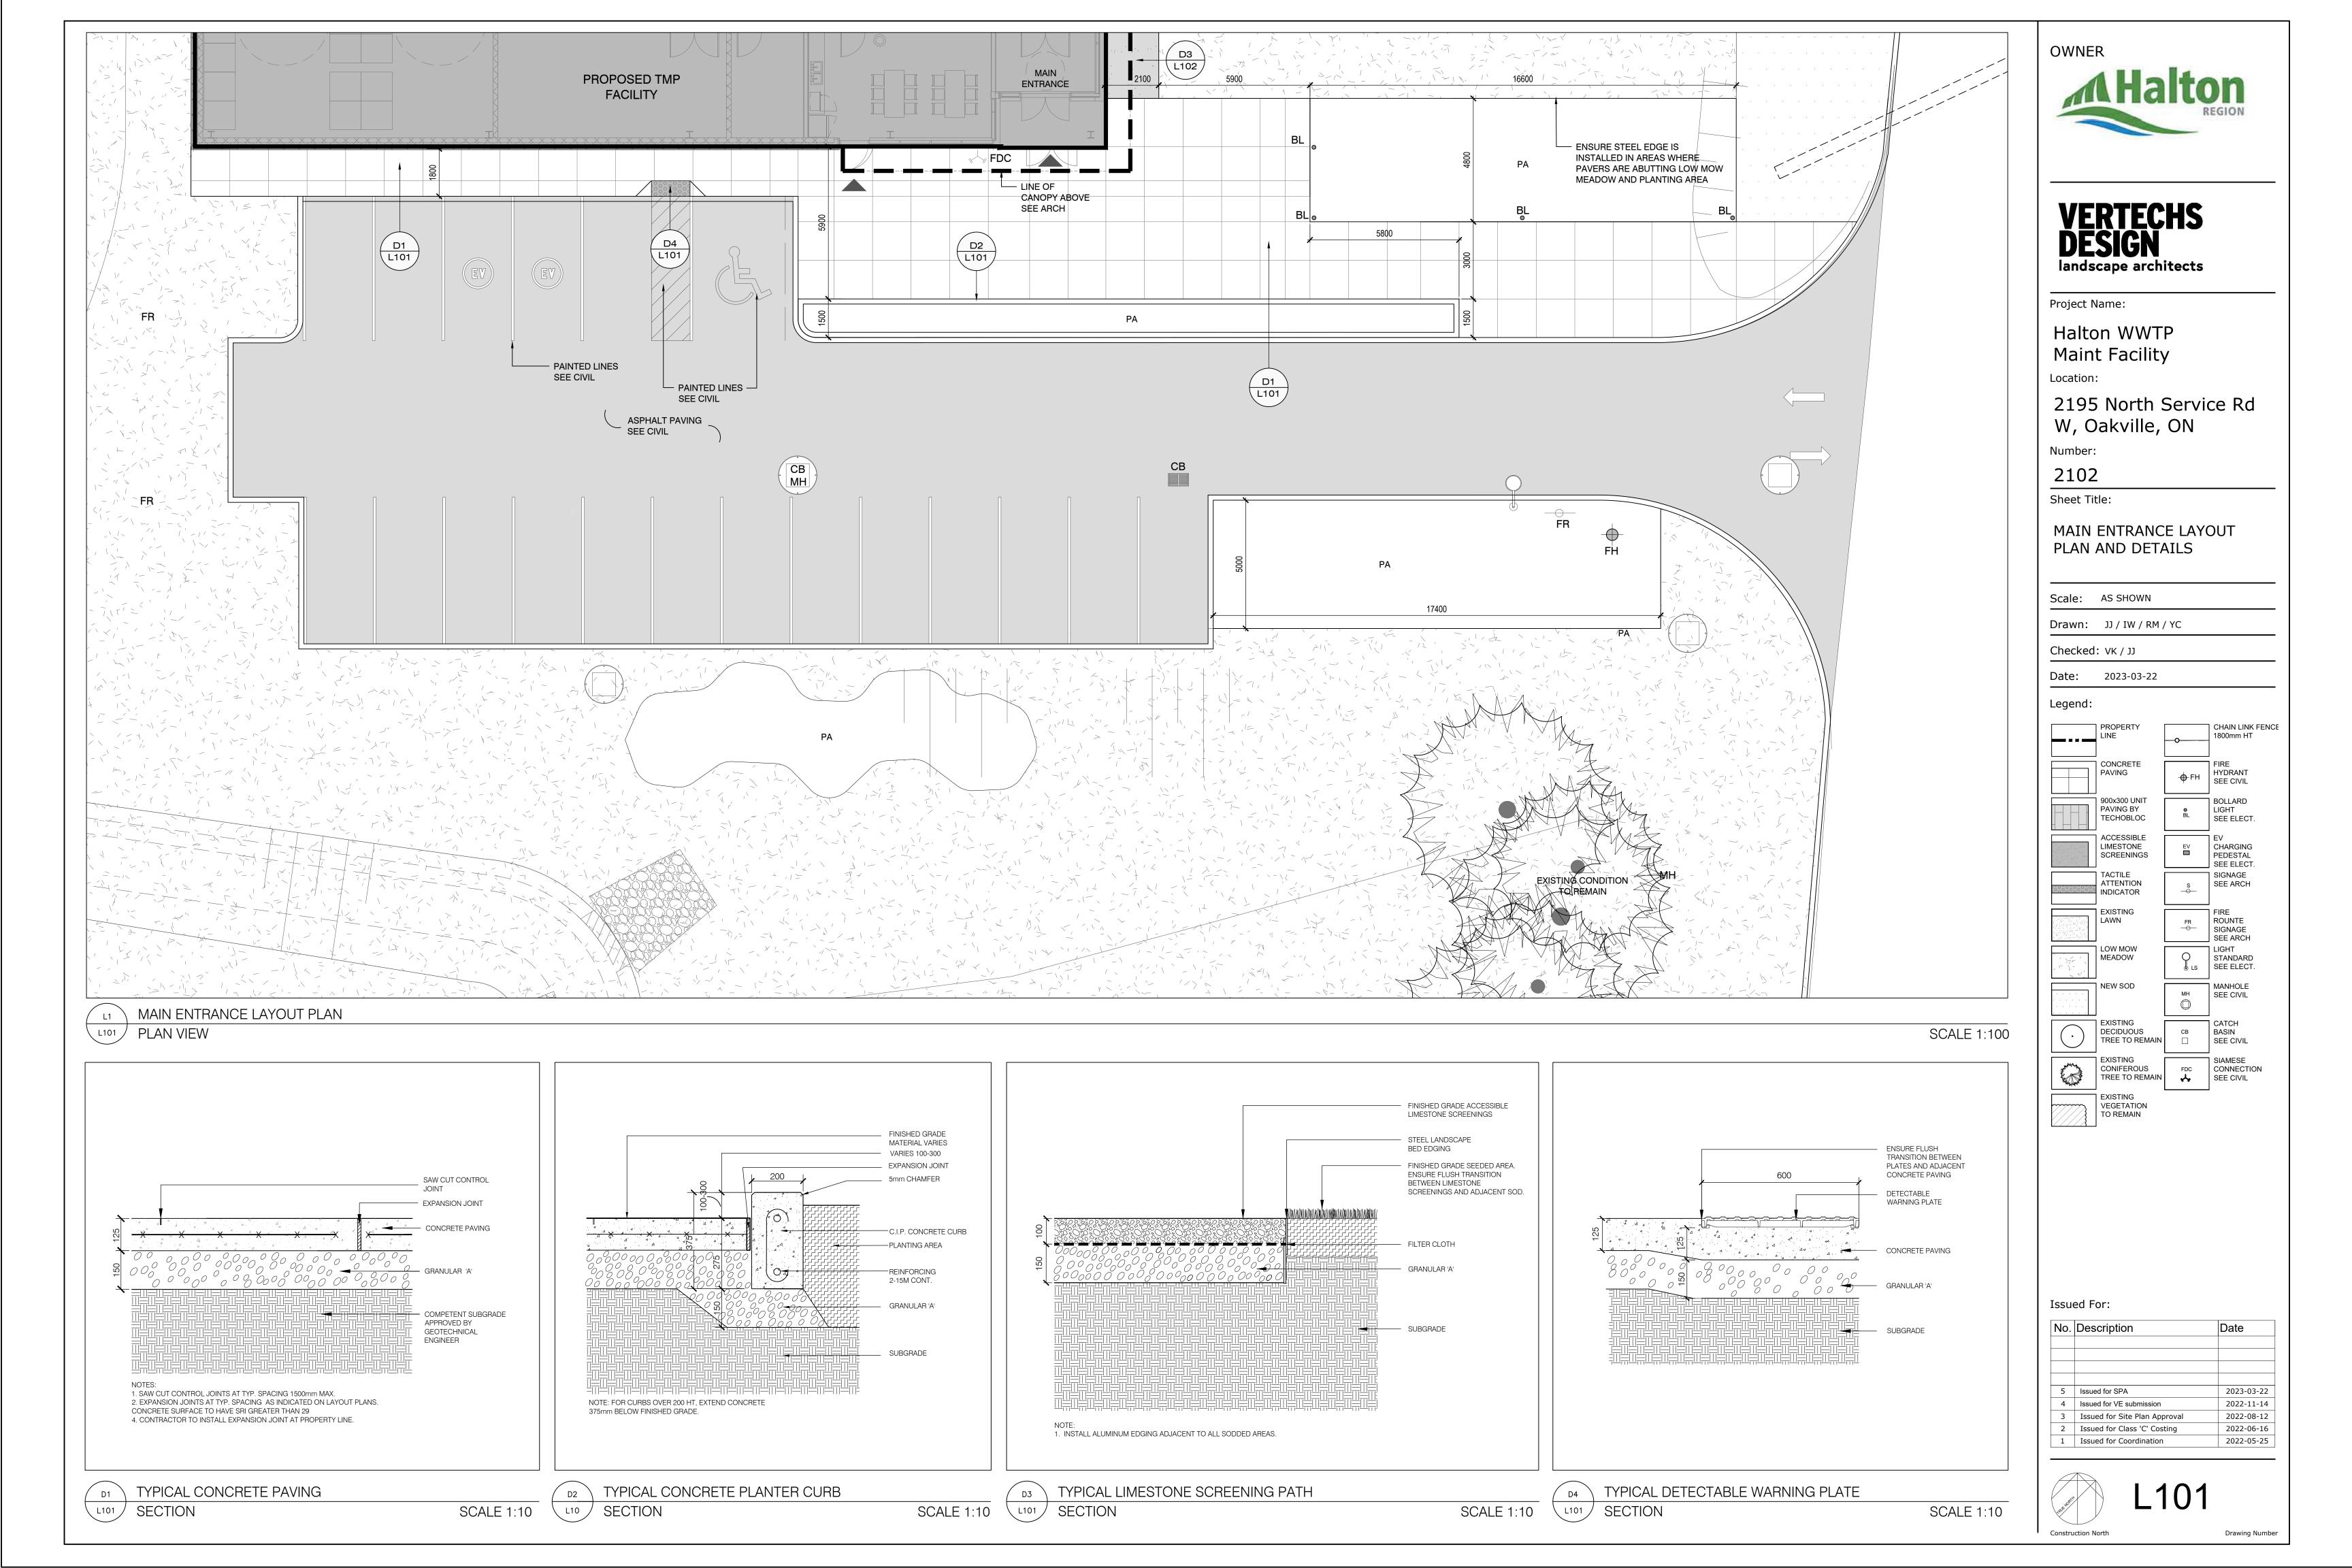


TYPICAL DECIDUOUS TREE PLANTING

HALTON REGION STANDARD DETAIL

D1

L102

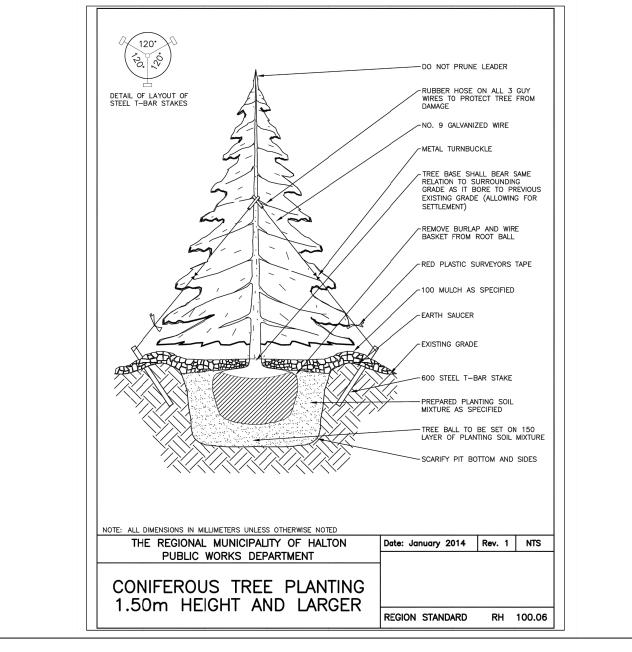

TYPICAL CONIFEROUS TREE PLANTING HALTON REGION STANDARD DETAIL L102

NOT TO SCALE

SHRUB PLANTING POTTED REGION STANDARD RH 100.01 TYPICAL SHRUB PLANTING NOT TO SCALE HALTON REGION STANDARD DETAIL L102

MIN. 150 PREPARED PLANTING ^J SOIL MIXTURE ALL AROUND ROOT BALL. CONTINUOUS BED FOR MASS PLANTINGS

NOTE: ALL DIMENSIONS IN MILLIMETERS UNLESS OTHERWISE NOTED

THE REGIONAL MUNICIPALITY OF HALTON

PUBLIC WORKS DEPARTMENT

PAVING 900x300 UNIT PAVING BY 999 ACCESSIBLE LIMESTONE SHRUB PERNNIALS, **GRASSES AND** ATTENTION INDICATOR GROUNDCOVERS DINING TABLE FENCE AND CHAIRS **TEXISTING** BENCH LAWN MEADOW RECEPTACLE NEW SOD **HYDRANT** SEE CIVIL DECIDUOUS ROUNTE SIGNAGE TREE TO REMAIN CONIFEROUS STANDARD TREE TO REMAIN VEGETATION SEE CIVIL SEE ELECT. SEE CIVIL SIAMESE CONNECTION PEDESTAL SEE ELECT SIGNAGE SEE ARCH Issued For: No. Description 2022-11-14 4 Issued for VE submission 2022-08-12 Issued for Site Plan Approval Issued for Class 'C' Costing 2022-06-16 2022-05-25 Issued for Coordination Drawing Number

OWNER

VERTECHS DESIGN

landscape architects

2195 North Service Rd

MAIN ENTRANCE PLANTING

Project Name:

Location:

Number:

2102

Sheet Title:

Halton WWTP

Maint Facility

W, Oakville, ON

PLAN AND DETAILS

Scale: AS SHOWN

Checked: VK / JJ

Legend:

Date: 2023-03-22


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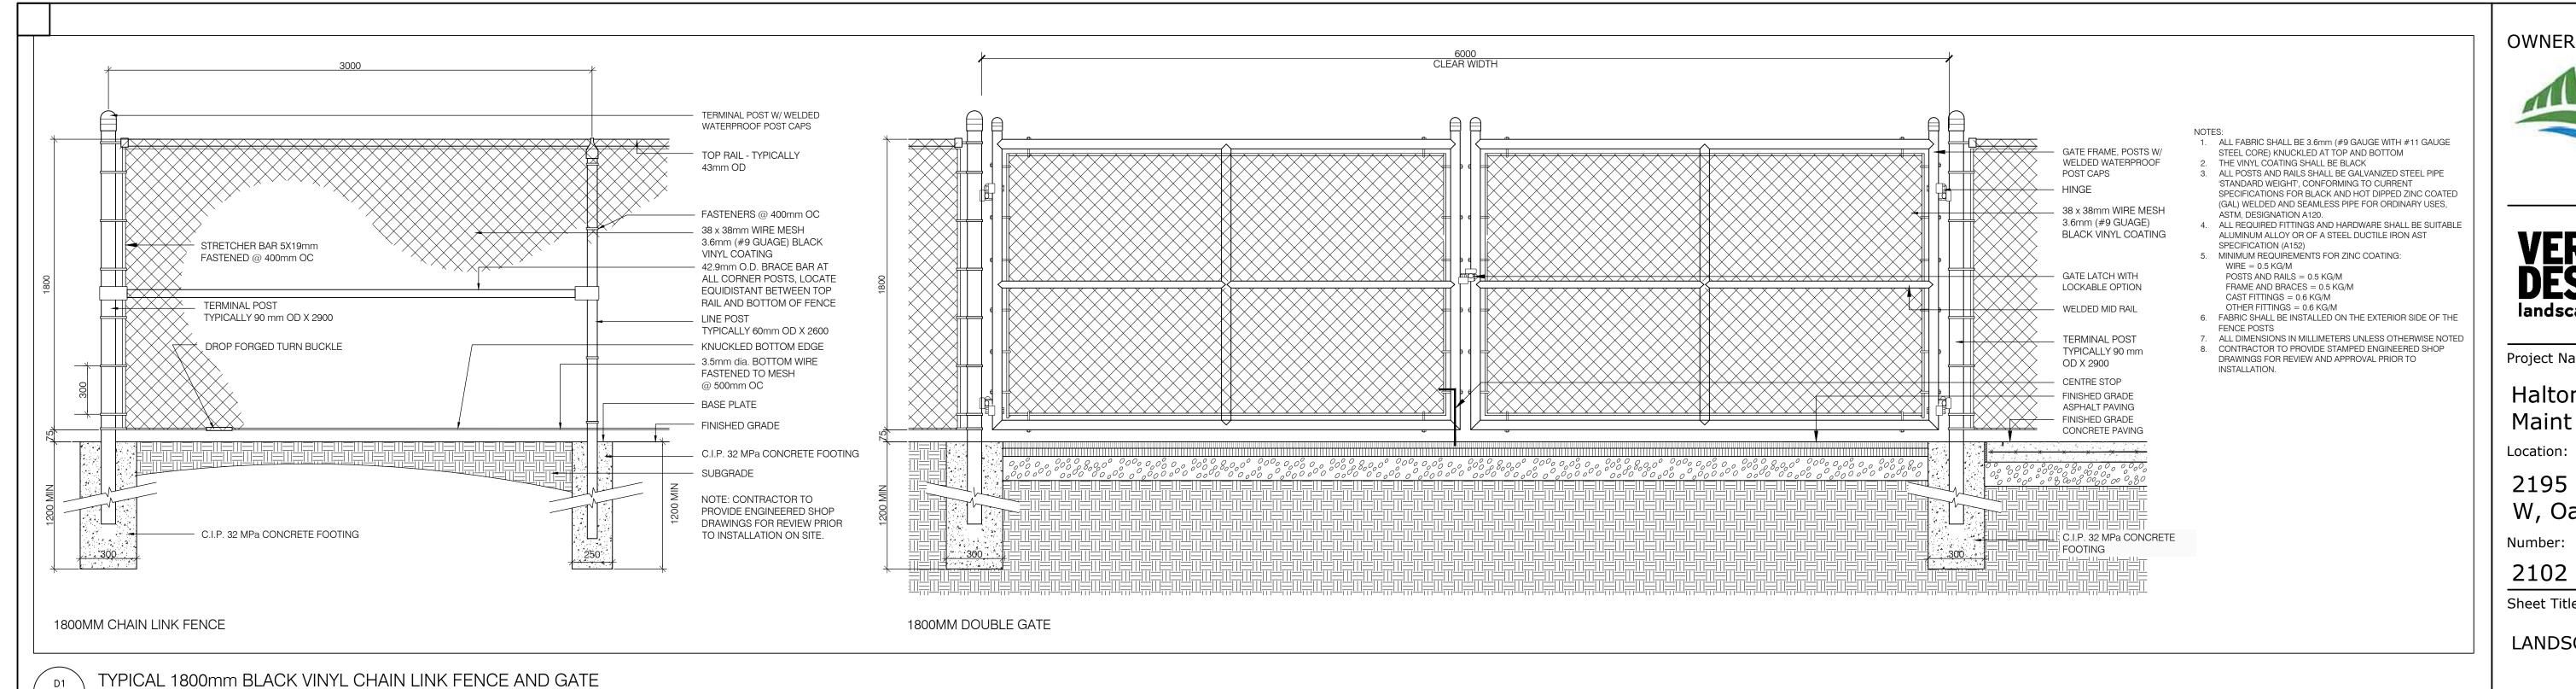
CONCRETE

NOT TO SCALE

SCARIFY PIT BOTTOM AND SIDES

Date: January 2014 Rev. 1 NTS



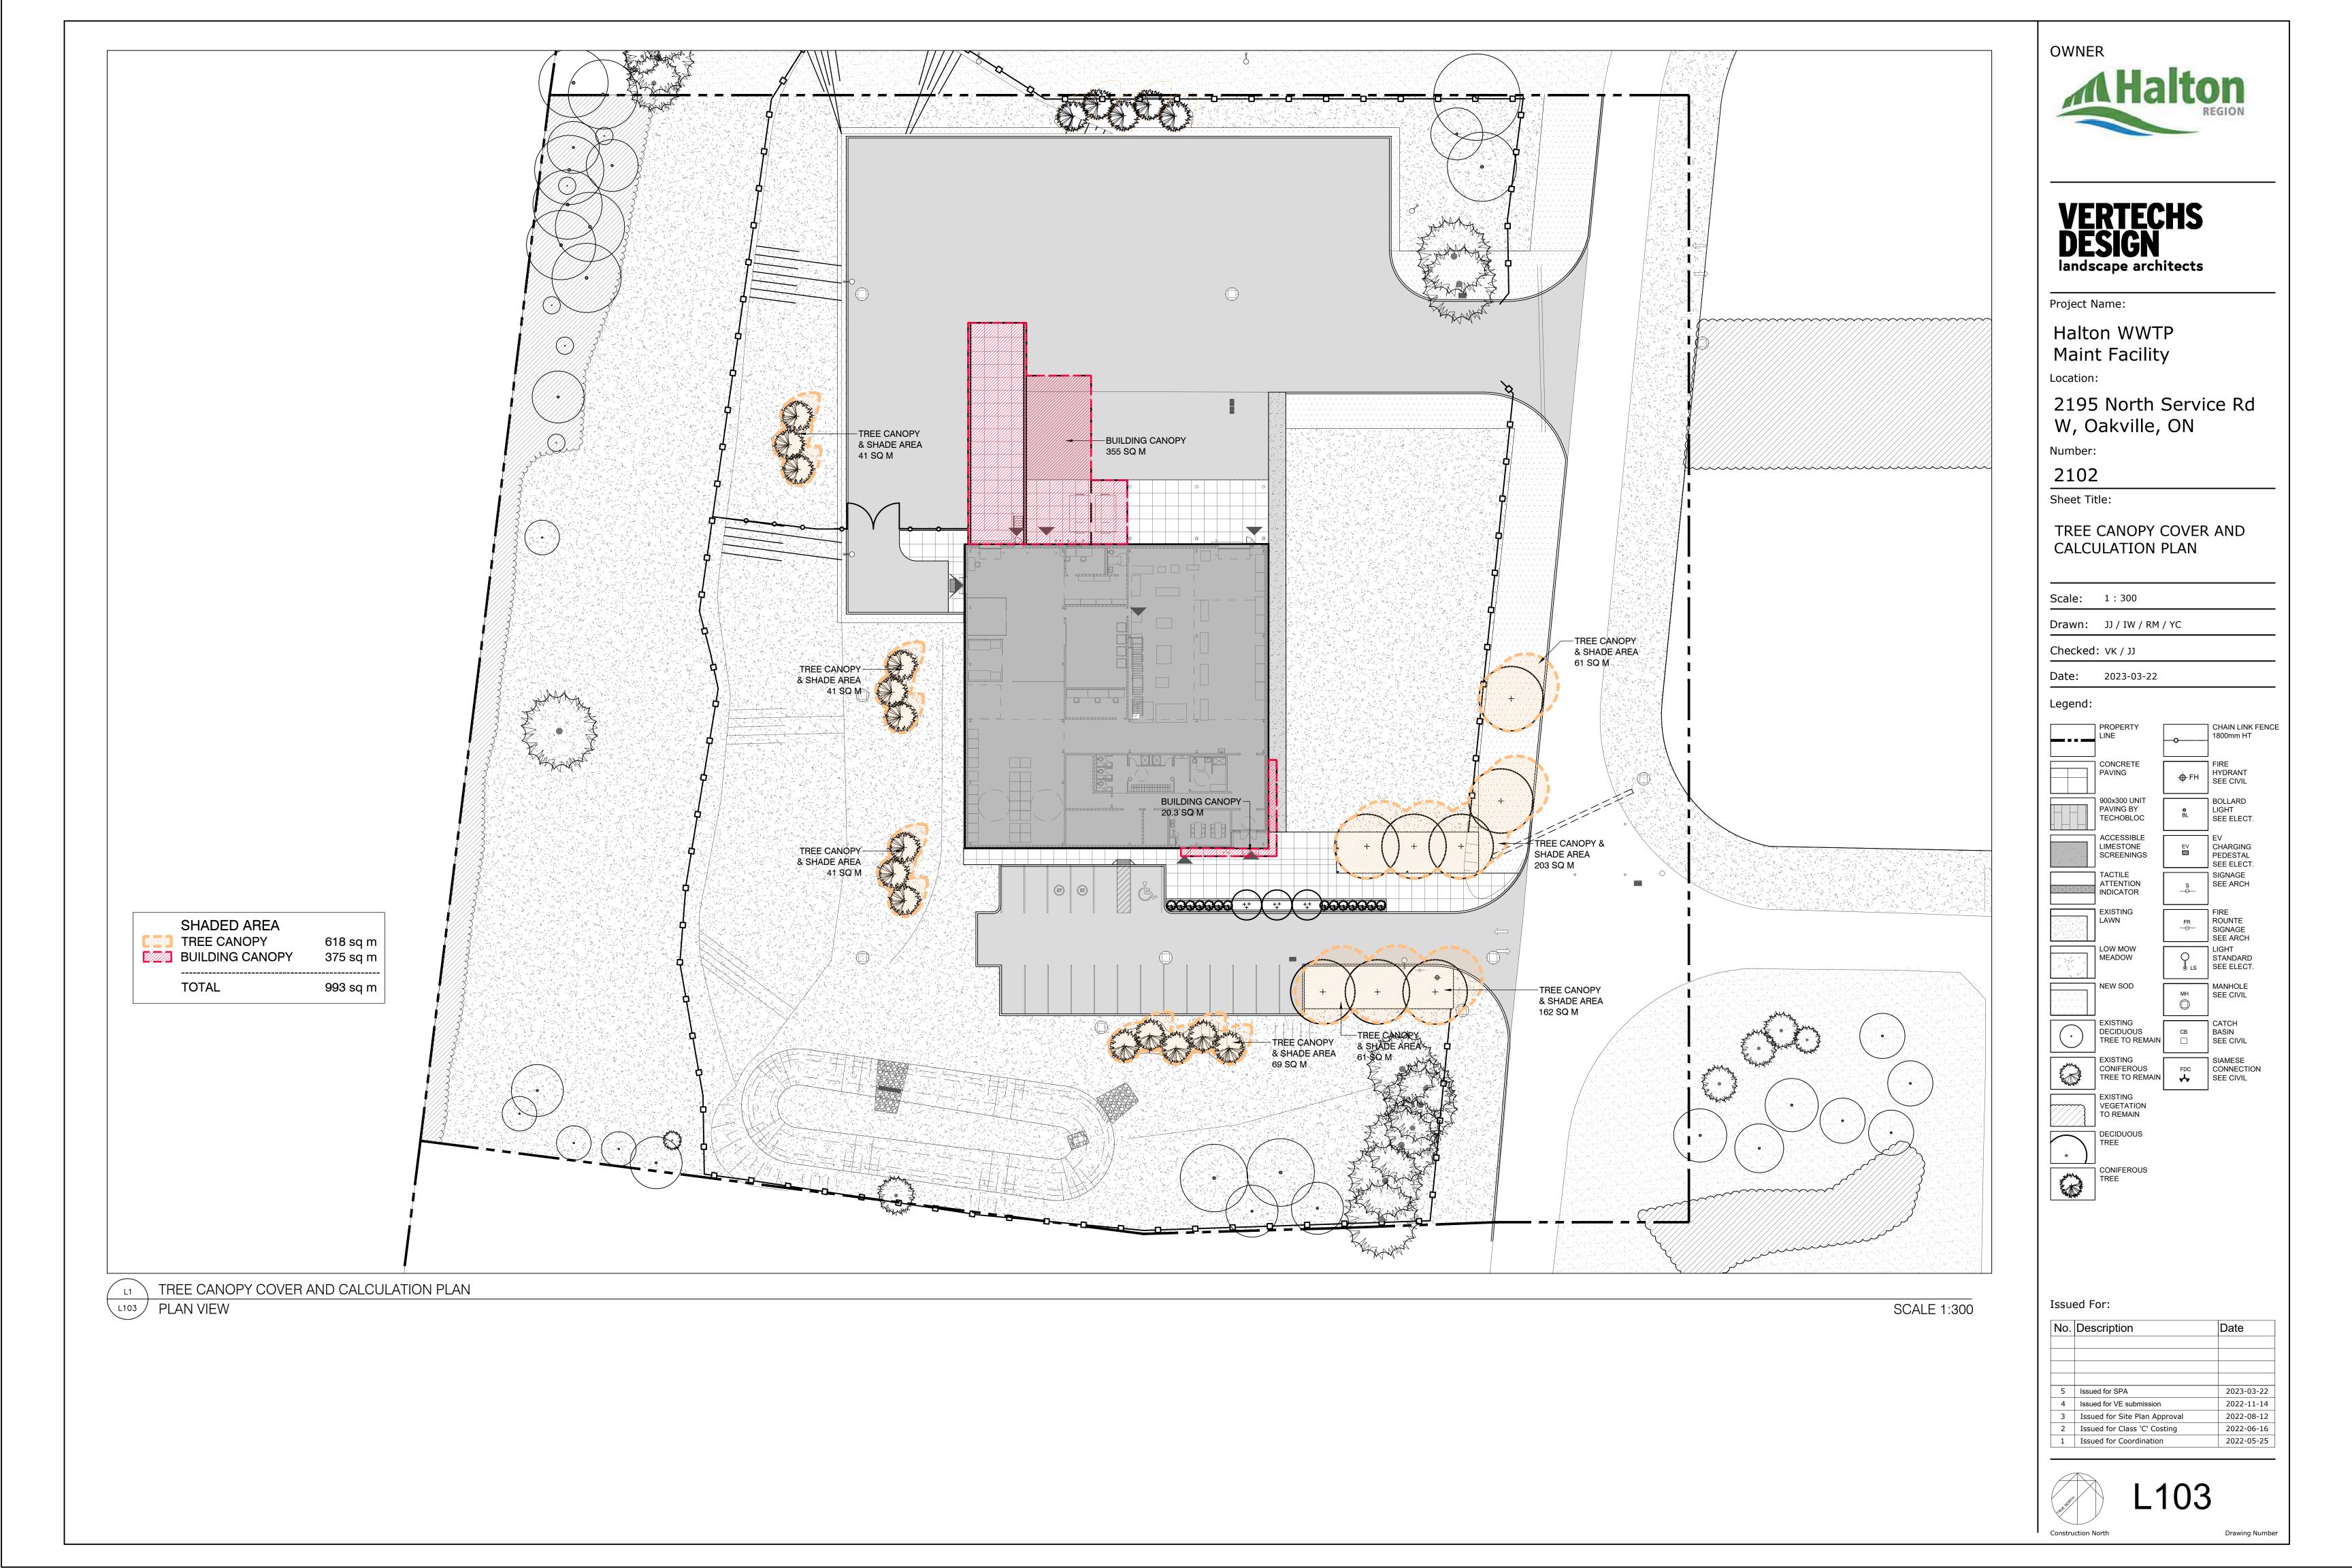

L200 SECTION

OWNER

VERTECHS DESIGN landscape architects

Project Name:

Halton WWTP **Maint Facility**

2195 North Service Rd W, Oakville, ON

Number:

2102

Sheet Title:

Legend:

SCALE 1:20

LANDSCAPE DETAILS

Scale: AS SHOWN Drawn: JJ / IW / RM / YC Checked: VK / JJ Date: 2023-03-22

Issued For:

No.	Description	Date
5	Issued for SPA	2023-0
4	Issued for VE submission	2022-1
3	Issued for Site Plan Approval	2022-0
2	Issued for Class 'C' Costing	2022-0
1	Issued for Coordination	2022-0

