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Architect:



Municipality:

OAKVILLE

KEY	QNTY	BOTANICAL NAME	COMMON NAME	HT/CAL	SPREAD	ROOT	DROUGHT TOLERANT	NATIVE	REMARKS
DECIDUC	US CANC	DPY TREES	·	•					
AXF	5	Acer x freemanii "Sienna"	Sienna Glen Maple	70 mm		B.&B.	High	Yes	Full Form
CEH	4	Celtis occidentalis	Hackberry	70 mm		B.&B.	High	Yes	Full Form
GSS	6	Gleditsia triacanthos 'Shademaster'	Shademaster Honey-Locust	70 mm		B.&B.	High	Yes	Full Form
QRB	5	Quercus rubra	Red Oak	70 mm		B.&B.	High	Yes	Full Form
TAM	5	Tilia Americana	Basswood Linden	70 mm		B.&B.	High	Yes	Full Form
CONIFER	OUS TRE	ES	•						
PSB	3	Pinus strobus	White Pine	200 cm		B.&B.	High	Yes	Full Form
DECIDUC	US SHRU	JBS	•	•					
CNK	59	Cornus sericea 'Kelseyi'	Kelsey Red Osier Dogwood	60 cm		C.G.	High	Yes	Full Form
LDI	78	Diervilla Ionicera	Bush Honysuckle	60 cm		C.G.	High	Yes	Full Form
RHG	100	Rhus aromatica 'Gro-Low'	'Gro-Low' Fragrant Sumac	60 cm		C.G.	High	Yes	Full Form
SBG	54	Spirea bumalda 'Gold Mound'	Gold Mound Spirea	60 cm		C.G.	High	No	Full Form
VLE	20	Viburnum lentago	Nannyberry	80 cm		C.G.	High	Yes	Full Form
CONIFER	OUS SHR	UBS							
JCD	27	Juniperus communis var. depressa	Depressa Juniper	60 cm		C.G.	High	Yes	Full Form
JSA	46	Juniper sabina	Savin Juniper (vase shaped)	60 cm		C.G.	High	No	Full Form
TCF	8	Taxus x media 'Fairview'	Fairview Yew		65 cm	C.G.	High	No	Full Form
ORNAME	NTAL GR	ASSES	•	•					
SCS	78	Schizachyrium scoparium	Little Bluestem			2 Gal.	High	Yes	Full Form — Native
PERENNI	ALS			•					
ANA	51	Aster novae—angliae	New England Aster			2 Gal.	High	Yes	Full Form
RUD	9	Rudbeckia fulgida var. sullivantii 'Goldsturm'	Black Eyed Susan			2 Gal.	High	Yes	Full Form (*PPOY Winner)
GER	29	Geranium 'Rozanne'	Hardy Cranesbill Geranium			2 Gal.	High	Yes	Full Form (PPOY Winner)

03 Issued for 3rd Submission 02 Issued for Submission 04/14/22 01 Issued for Submission


Proposed Landscape Upgrades Site Plan File #: SP.1629.003/01 2330 Wyecroft Road,

Oakville, Ontario 1:350 Date: March 2021

C.F. Checked By: L.M. Drawn By: Drawing Title:

Landscape Plan

Project No. 21112 L1-01

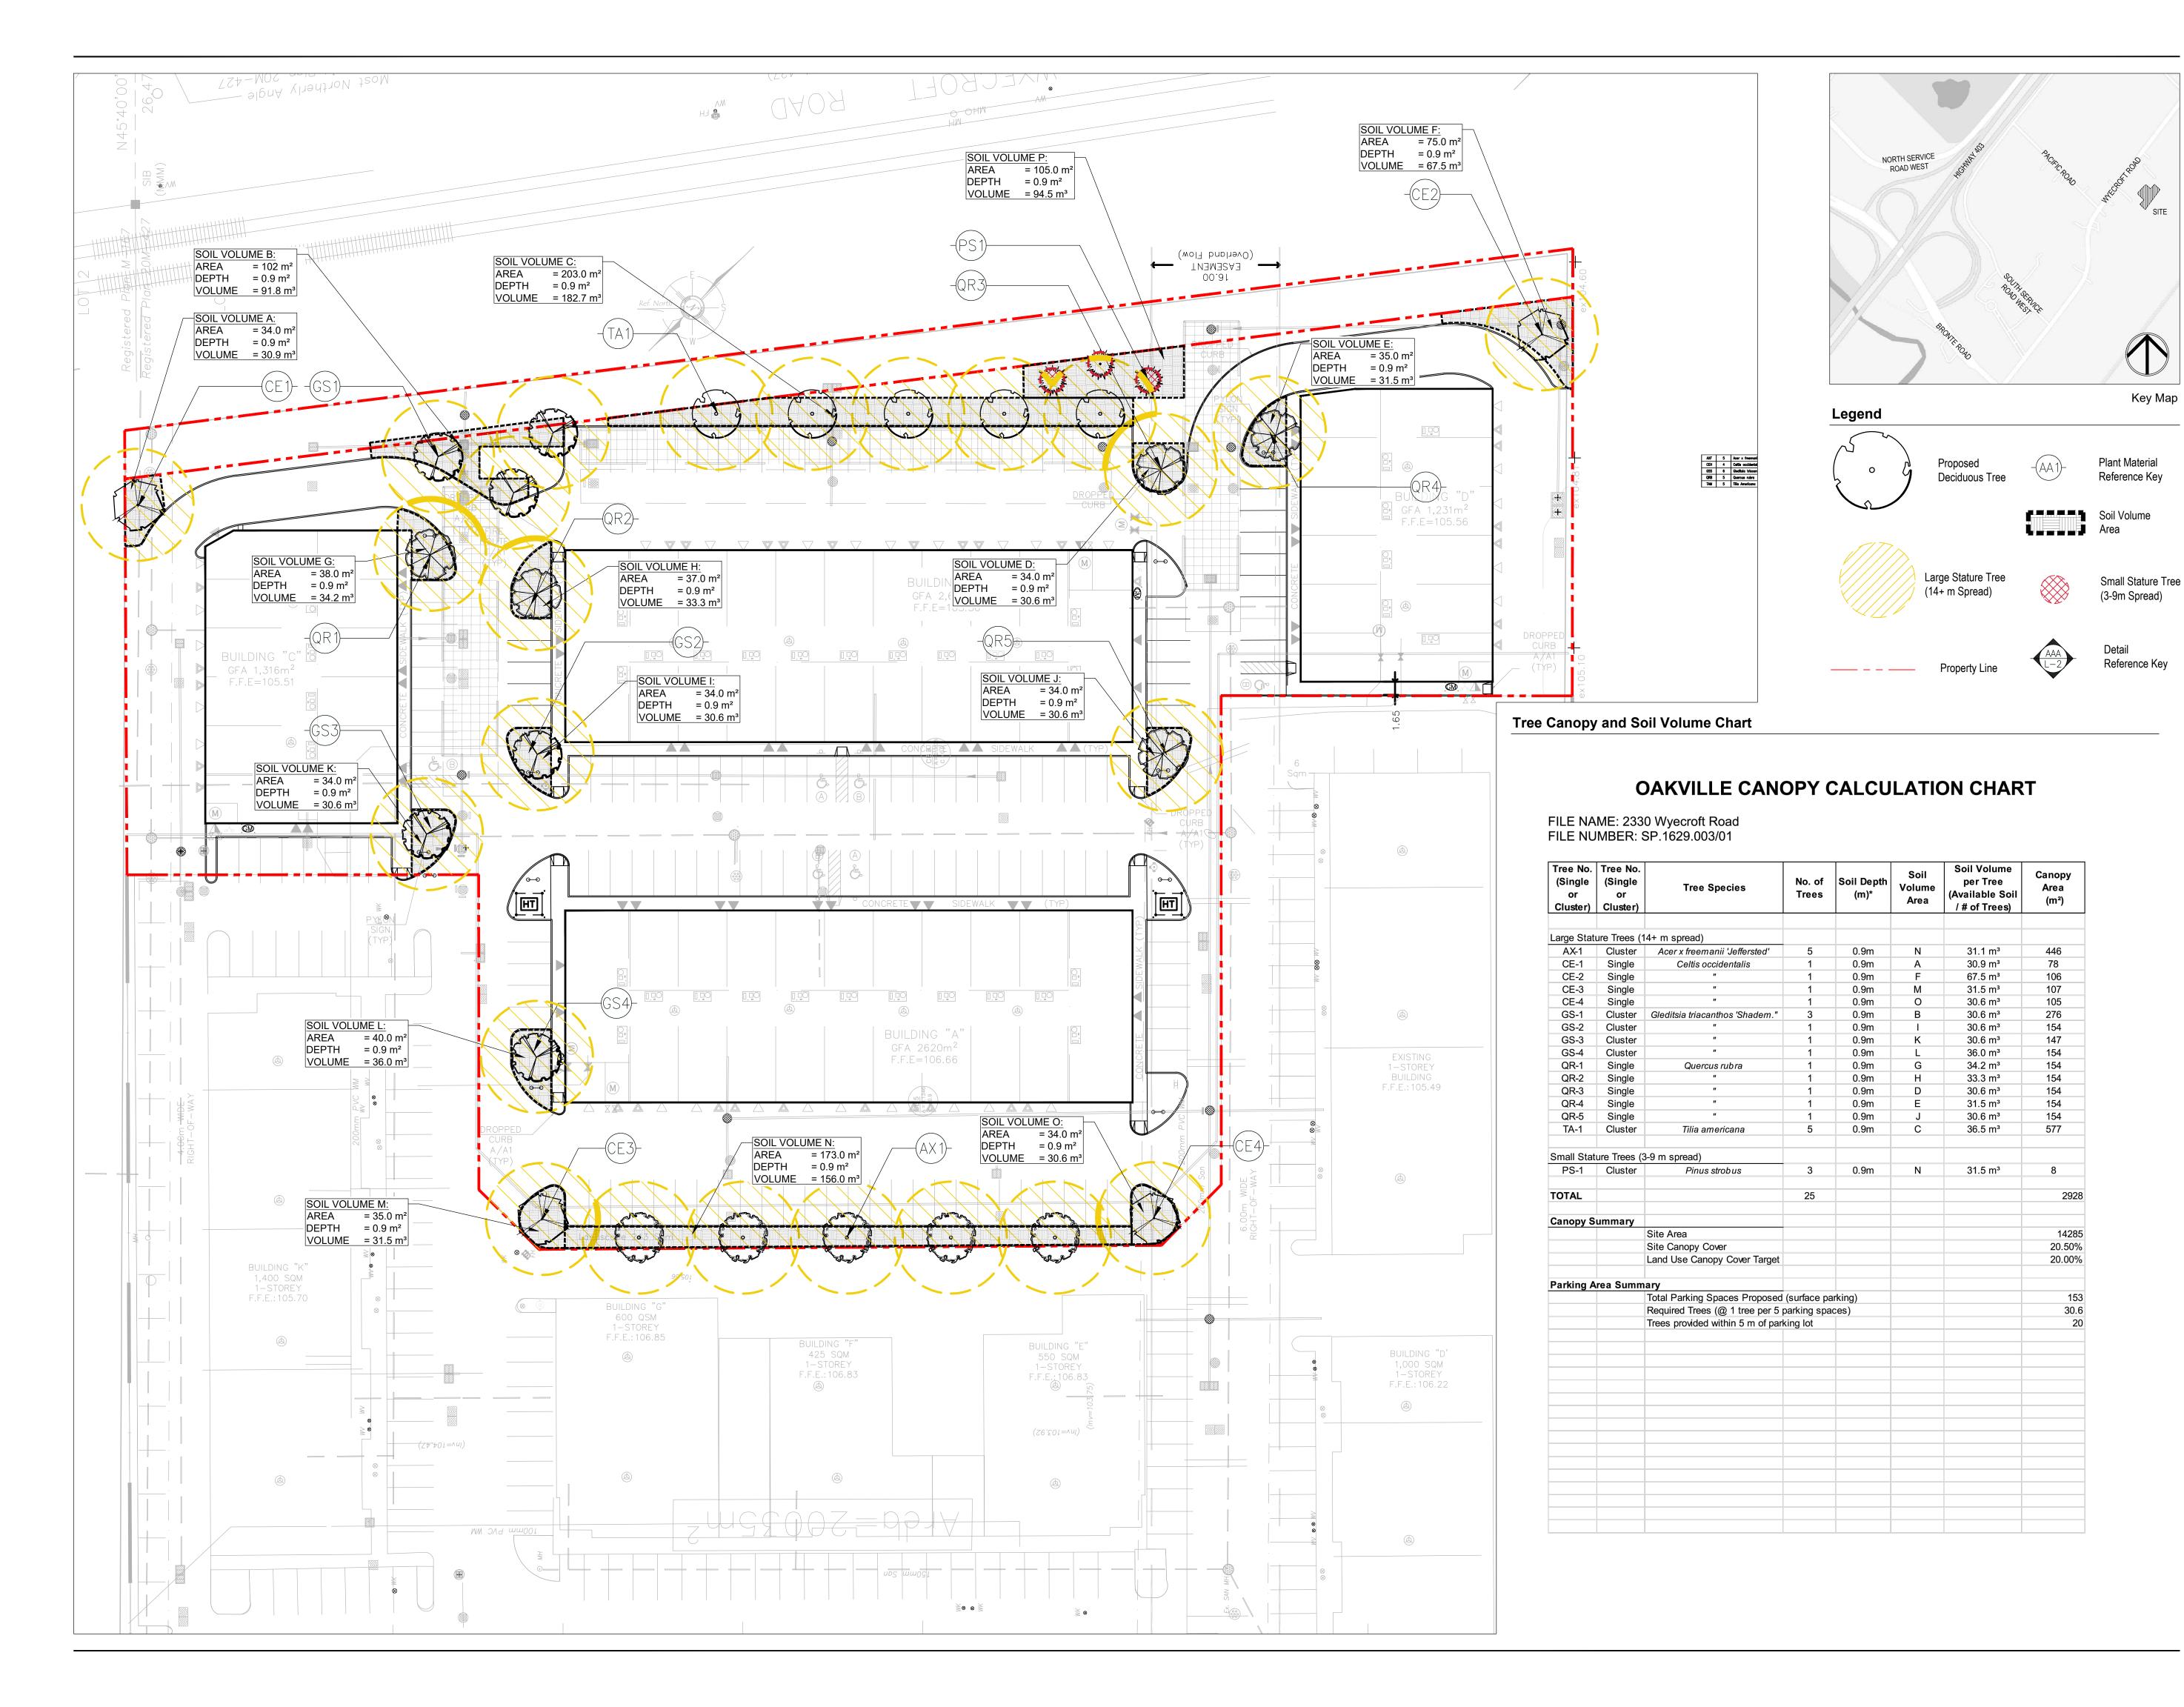






Municipality: **OAKVILLE**

03 Issued for 3rd Submission 02 Issued for Submission 04/14/22 04/19/21 01 Issued for Submission Date No. Revision

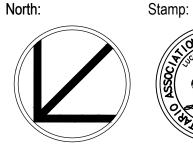



Proposed Landscape Upgrades Site Plan File #: SP.1629.003/01 2330 Wyecroft Road, Oakville, Ontario

1:350 Date: March 2021 Drawn By: C.F. Checked By: L.M.

Drawing Title:

Tree Soil Volume & Canopy Plan

Project No. Sheet No. L2-01

LANDSCAPE SPECIFICATIONS

CONTRACTOR MUST CONTACT ALL UTILITY COMPANIES FOR STAKE OUTS PRIOR TO ANY EXCAVATION OR PLANTING.

ROUGH GRADE AND FILL AREAS TO ESTABLISH SUBGRADE AS REQUIRED. PROVIDE DRAINAGE PATTERN AS INDICATED ON DRAWINGS. ROUND SMOOTHLY ALL TOPS AND TOES OF SLOPES. COMPACT ALL AREAS TO 95% STANDARD PROCTOR DENSITY UNLESS SPECIFIED OTHERWISE. EXISTING TREES TO REMAIN ON SITE ARE TO BE PROTECTED AS DETAILED.

FINE GRADE ALL AREAS TO FINISHED GRADES AS SHOWN ON LAYOUT OR GRADING PLAN OR ARCHITECT'S SITE PLAN. PROVIDE UNIFORM SLOPES AWAY FROM THE BUILDING, UNLESS SPECIFIED OTHERWISE. SLOPES MAY NOT EXCEED 33 1/3% (3:1).

SCARIFY THE SUBSOIL PRIOR TO THE SPREADING THE TOPSOIL. REMOVE ALL DEBRIS AND LEAVE A FINE-TEXTURED EVEN SURFACE. ALL TOPSOIL TO BE IMPORTED UNLESS PREVIOUSLY APPROVED BY LANDSCAPE ARCHITECT. OBTAIN APPROVAL FOR THE QUALITY OF ANY IMPORTED TOPSOIL BEFORE DELIVERY TO THE SITE. TOPSOIL IS TO BE COMPACTED. TO CREATE A FIRM AND EVEN SURFACE.

USE NO. 1 GRADE TURFGRASS NURSERY SOD WHICH CONFORMS WITH THE SPECIFICATIONS OF THE NURSERY SOD GROWERS ASSOCIATION OF ONTARIO. ALL LAWN AREAS SHALL RECEIVE A MINIMUM OF 100MM (4") OF COMPACTED TOPSOIL, AND SHALL BE SODDED WITH #1 KENTUCKY BLUEGRASS - FESCUE. NO SOD SLOPES ARE TO EXCEED 3:1. SLOPE IN EXCESS OF 4:1 TO BE PEGGED.

APPLY THE FOLLOWING MINERAL FERTILIZER UNLESS SOILS TESTS SHOW OTHER REQUIREMENTS:

1. SODDED AREAS - 11% NITROGEN, 8% PHOSPHORUS AND 4% POTASH (11-8-4) AT THE RATE OF 4.5 KG OVER M2 (10 LBS OVER 1000 SQ.

2. PLANTING BEDS - 7% NITROGEN, 7% PHOSPHORUS AND 7% POTASH (7-7-7) AT THE RATE OF 40 GRAMS (4 OZ.) FOR EVERY BUSHEL OF

PREPARATION OF PLANTING BEDS

MINERAL FERTILIZER

ALL PLANT BEDS TO BE CONTINUOUS. EXCAVATE ALL PLANTING BEDS TO THE DEPTH AS INDICATED ON THE DRAWINGS AND DETAILS MIN 450mm(18"). BACKFILL ALL PLANTING BEDS WITH A SOIL MIXTURE CONSISTING OF SIX (6) PARTS OF SAND LOAM, ONE (1) PART OF FINELY PULVERIZED PEAT MOSS, TWO (2) PARTS OF WELL-ROTTED MANURE AND THE MINERAL FERTILIZER AS SPECIFIED ABOVE. ALSO ADD .58 KILOS BONEMEAL/CUBIC METER OF PLANTING SOIL (1 LB./CUBIC YARD). PREPARE THE PLANTING BEDS FOR PLANTING BEFORE THE DELIVERY OF THE PLANT MATERIAL TO THE JOB SITE.

NOTE: IF THE EXISTING SOIL CONDITIONS ARE CLAY OR WET IN NATURE, CONTACT THE LANDSCAPE ARCHITECT FOR INSTRUCTIONS OF A SUITABLE SOIL MIXTURE. FAILURE TO DO THIS MAY RESULT IN DELAY OF APPROVAL AND ACCEPTANCE.

ALL PLANT MATERIAL SHALL CONFORM TO THE STANDARDS OF THE CANADIAN NURSERY TRADES ASSOCIATION FOR SIZE AND

ALL SHRUB AND TREE MATERIAL SHALL BE CONTAINER GROWN, POTTED, S/B OR B/B, UNLESS OTHERWISE NOTED. BARE ROOT PLANTING SHALL BE ACCEPTABLE FOR CERTAIN SPECIES DURING EARLY SPRING OR LATE FALL PLANTING SEASON. CONTRACTOR SHALL MAKE REQUESTS FOR ROOT CONDITION SUBSTITUTION IN WRITING TO THE LANDSCAPE ARCHITECT PRIOR TO COMMENCEMENT OF PLANTING OPERATIONS. ALL PLANT MATERIAL TO BE CLAY GROWN STOCK UNLESS OTHERWISE NOTED.

LANDSCAPE SPECIFICATIONS

SCALE: N.T.S. DATE:

PLANT MATERIALS

PLANT MATERIAL INSTALLATION

ALL TREES, SHRUBS AND GROUNDCOVERS SHALL BE PLANTED AS DETAILED & AS SHOWN ON THE PLANTING PLAN. ALL BEDS TO RECEIVE A COVER OF CLEAN MULCH TO A DEPTH OF 75mm(3"). FOR GUYING AND STAKING TREES, REFER TO PLANTING DETAILS. WRAP ALL DECIDUOUS TREES UNDER EXPERIENCED SUPERVISION ONLY TO THE SPECIFICATIONS OF THE ONTARIO LANDSCAPE

PLANT MATERIAL SIZES AND CONDITIONS ARE TO BE AS INDICATED ON THE LANDSCAPE DRAWING.

THE INDIVIDUAL PLANT GROUPING TOTAL AS ILLUSTRATED ON THE PLANTING PLAN SUPERSEDES THE ESTIMATED QUANTITY ON THE MASTER PLANT LIST. CONTRACTOR MUST REPORT ANY DISCREPANCIES TO THE LANDSCAPE ARCHITECT IN WRITING BEFORE COMMENCING ANY WORK. CONTRACTOR WILL ASSUME FULL RESPONSIBILITY IF LANDSCAPE ARCHITECT IS NOT NOTIFIED OF

* MULCH - SHREDDED PINE MULCH BY "GRO BARK" OR APPROVED EQUAL. LANDSCAPE ARCHITECT TO APPROVE MULCH BEFORE INSTALLATION.

GENERAL MAINTENANCE

PROPER MAINTENANCE PROCEDURES ARE TO BE FULLY ADMINISTERED FOR ALL NEWLY CONSTRUCTED LANDSCAPE WORK, IN ACCORDANCE WITH LANDSCAPE ONTARIO SPECIFICATIONS (SECTION 1E - MAINTENANCE WORK). THIS SHALL APPLY ONLY DURING THE CONSTRUCTION PERIOD, UNLESS OTHERWISE SPECIFIED. CONTRACTOR IS RESPONSIBLE FOR MAINTENANCE OF SOD AND PLANTING UNTIL FINAL ACCEPTANCE BY LANDSCAPE ARCHITECT.

RODENT PROTECTION

THE CONTRACTOR SHALL BE RESPONSIBLE FOR THE PROTECTION OF ALL TREES AND SHRUBS FOR WINTER PROTECTION AND FROM RODENT INJURY FOR THE DURATION OF GUARANTY PERIOD. PROTECTIVE GUARDS SHALL BE EMPLOYED AROUND ALL DECIDUOUS TREES. GUARDS TO BE 150MM DIA. PVC PIPE OR AS MUNICIPAL GUIDELINES. GUARDS SHALL BE INSTALLED PRIOR TO THE

APPLICATION OF THE MULCH AND SHOULD BE PLACED A MINIMUM OF 50MM (2") OUT FROM THE TREE TRUNK ON ALL SIDES.

ALL SHRUBS AND CONIFEROUS TREES SHALL HAVE AN APPLICATION OF "SKOOT" OR APPROVED EQUIVALENT RODENT FORMULA, TO BE APPLIED AT THE END OF OCTOBER. FOLLOW MANUFACTURER'S DIRECTIONS FOR APPLICATION.

USE ABOVE SPECIFICATIONS IN CONJUNCTION WITH THE GENERAL LANDSCAPE SPECIFICATIONS OF THE ONTARIO LANDSCAPE CONTRACTORS ASSOCIATION, THE NURSERY SOD GROWERS ASSOCIATION OF ONTARIO AND WITH THE GUIDE SPECIFICATIONS FOR NURSERY STOCK OF THE CANADIAN NURSERY TRADES ASSOCIATION. USE ONLY PLANT MATERIAL TRUE TO NAME, SIZE AND GRADE AS SPECIFIED ON PLANTING PLAN; PROVIDE SUFFICIENT LABELS OR MARKINGS TO INDICATE CLEARLY THE VARIETY, SIZE AND GRADE OF EACH SPECIMEN OR BUNDLE.


OBTAIN APPROVAL FOR SUBSTITUTIONS AS TO VARIETY, SIZE OR GRADE FROM THE LANDSCAPE ARCHITECT. USE ONLY NURSERY STOCK GROWN UNDER PROPER HORTICULTURAL PRACTICES, VIABLE, FREE FROM PEST AND DISEASE AND UNDAMAGED. CHECK LOCATIONS AND OBTAIN STAKEOUTS OF ALL UTILITY LINES BEFORE EXCAVATION. OBTAIN ALL NECESSARY PERMITS BEFORE COMMENCEMENT OF CONSTRUCTION. REPORT IN WRITING ANY DISCREPANCIES IN THE DRAWINGS, SPECIFICATIONS AND CONTRACT DOCUMENTS TO THE LANDSCAPE ARCHITECT BEFORE THE END OF THE BIDDING PROCESS AND COMMENCEMENT OF CONSTRUCTION. THESE SPECIFICATIONS MAY BE SUPERCEDED BY ADDITIONAL SPECIFICATIONS SET OUT IN THE TENDER DOCUMENTS. CONTRACTOR TO REVIEW ALL DOCUMENTS.

GUARANTEE PERIOD

PROVIDE ONE FULL YEAR GUARANTEE ON ALL LANDSCAPE WORK FROM DATE OF FINAL ACCEPTANCE BY LANDSCAPE ARCHITECT. GUARANTEE PERIOD MAY BE EXTENDED TO TWO FULL YEARS DEPENDING ON MUNICIPAL STANDARDS. CONTRACTOR TO VERIFY WITH OWNER AND LANDSCAPE ARCHITECT.

PLANT MATERIAL INSTALLATION

SCALE: N.T.S. DATE:

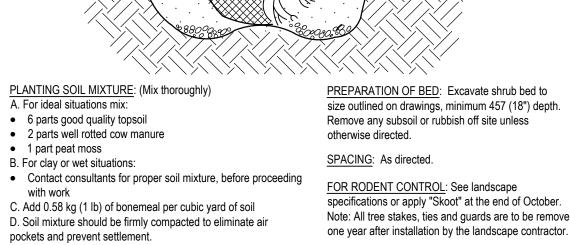

PREPARATION OF BED: Excavate shrub bed to size outlined on drawings, minimum 457 (18") depth. Remove any subsoil or rubbish off site unless otherwise directed.

PRUNING: (To suit species)

Prune to remove damaged or

proper horticultural practice.

DO NOT PRUNE LEADERS.

to species and size of shrub

Provide 102 (4") saucer.

plant list)

MULCHING: 102 (4") shredded

bark mulch be "All Treat" or equal.

CUT AND REMOVE: burlap from

top $\frac{1}{3}$ of ball as shown. (B.B. as per

FERTILIZER: Two (2) 21 gram

equivalent for each shrub in bed.

Agriform tablets or approved

objectionable branches following

GUYING: As directed; appropriate

FOR RODENT CONTROL: See landscape specifications or apply "Skoot" at the end of October. Note: All tree stakes, ties and guards are to be removed

STANDARD SHRUB PLANTING DETAIL


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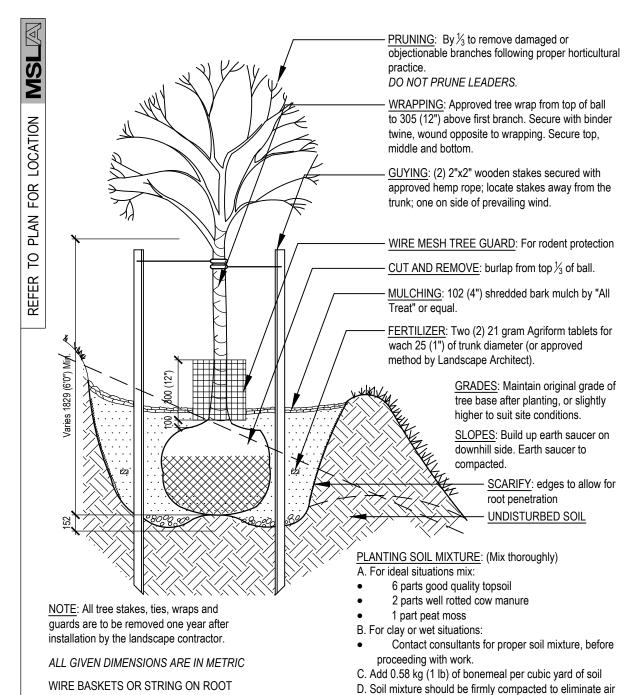
SCALE: N.T.S. SURFACE MOUNT MODEL

Shrubs to be wrapped with

ourlap or approved equal

during guaruntee period.



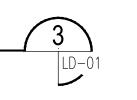

pockets and prevent settlement.

STANDARD DECIDUOUS TREE DETAIL

BALL - CUT AND TOP REMOVE 3/3


SCALE: N.T.S. WOODEN STAKES

MARTON SMITH LANDSCAPE ARCHITECTS 170 The Donway W Suite 206. Toronto, Ontario, Canada. M3C 2G3 tel. 416.492.9966 | email. info@msla.ca Architect: bramcon

DESIGN·BUILD·LEASE


Municipality: **OAKVILLE**


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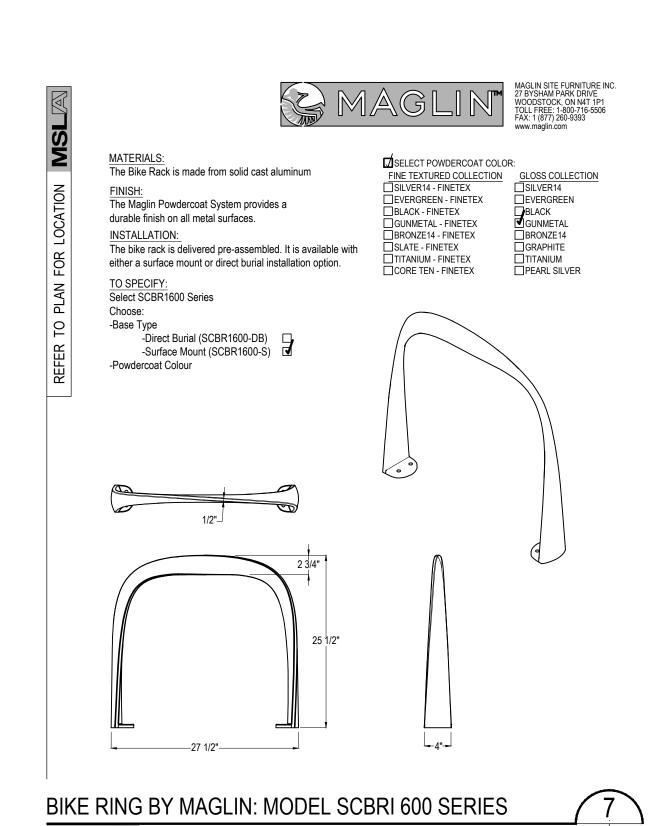


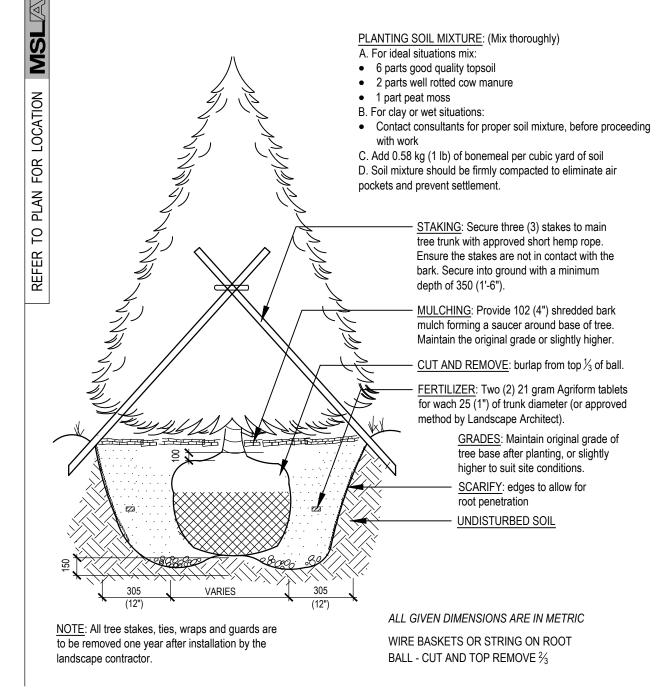
STANDARD CONIFEROUS TREE DETAIL


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C.F. Checked By: **L.M.**

LD-01

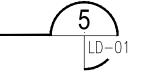
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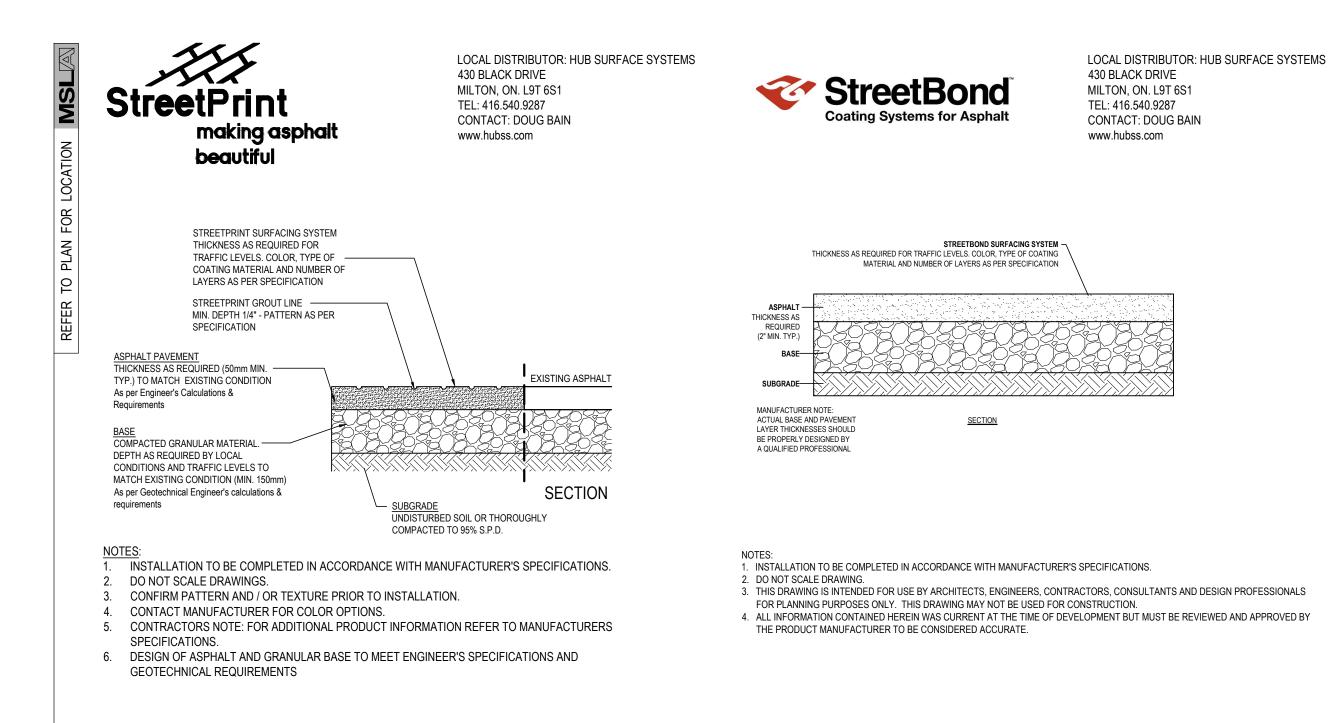
Drawing Title:

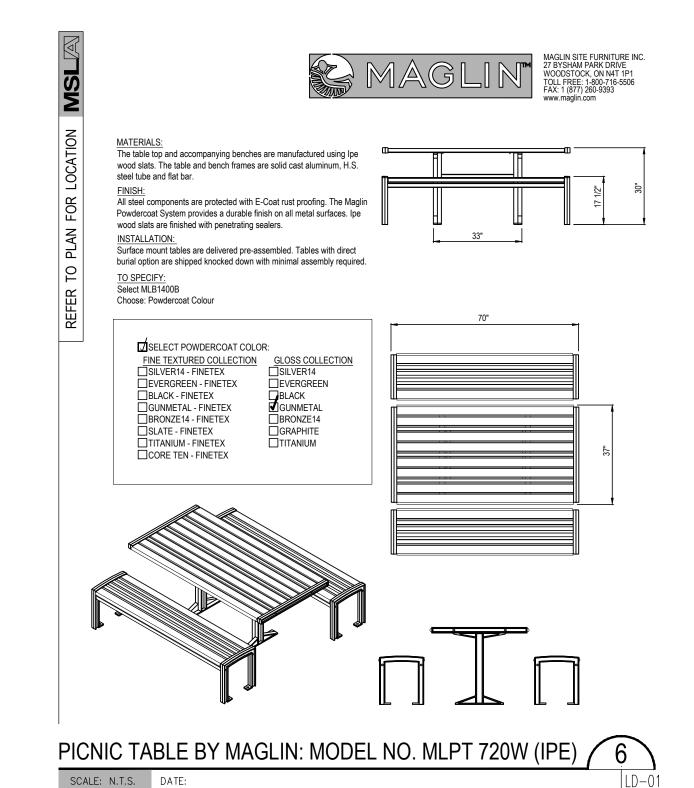Project No.

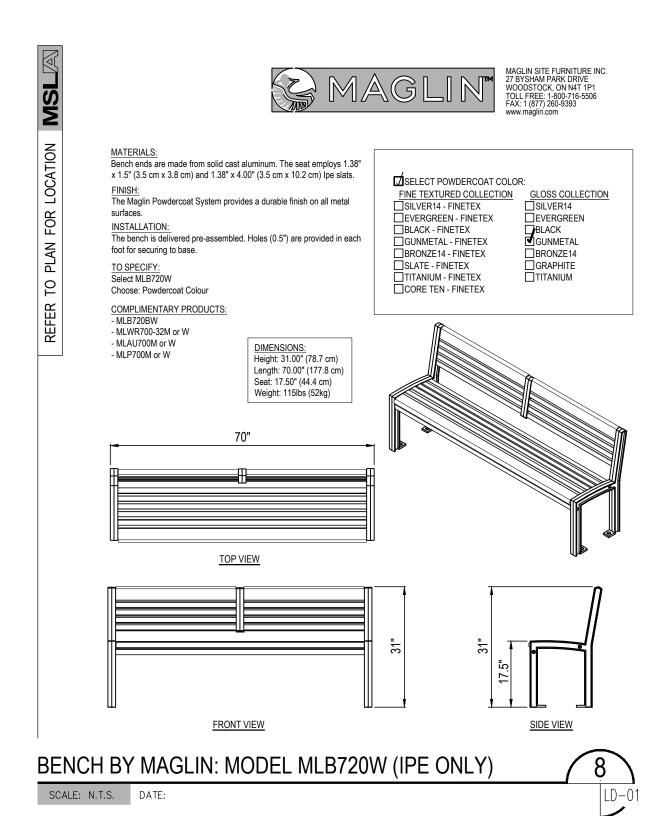Landscape

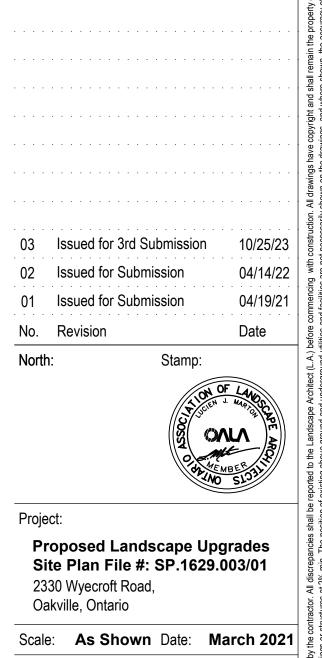Details



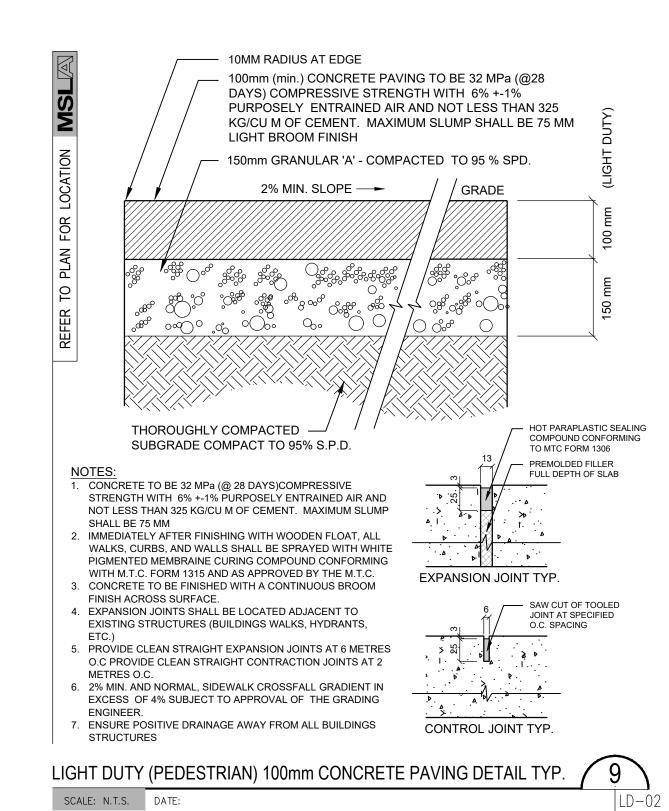





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Architect:

Client/Owner:



OAKVILLE

03 Issued for 3rd Submission 02 Issued for Submission 01 Issued for Submission No. Revision

North:

Proposed Landscape Upgrades Site Plan File #: SP.1629.003/01 2330 Wyecroft Road, Oakville, Ontario

Scale: As Shown Date: March 2021

Drawn By: C.F. Checked By: L.M.

Drawing Title:

Landscape **Details**

Project No. 21112

LD-02

IMPRESSED ASPHALT PAVEMENT - BY STREET PRINT WITH STREET BONG PAVEMNT COATING

