

OAKVILLE DUNDAS & SIXTH LINE

3000 Sixth line & 21 Dundas street West Oakville, Ontario

OWNER: SHOPPERS REALTY INC.

LANDSCAPE DEVELOPMENT

Ground Level Layout and Surface Treatment Plan
Ground Level Layout and Surface Treatment Plan (Ultimate)
Planting Plan
Planting Plan (Ultimate)
Pedestrian Circulation Plan

Pedestrian Circulation Plan (Ultimate)

Tree Canopy Plan
Tree Canopy Plan (Ultimate)
Lighting Plan
Lighting Plan (Ultimate)


Landscape Details Landscape Details


Issued For Zoning Submission: September 11th, 2025


Client: Daniels Emshih Oakvillage Corporation





421 RONCESVALLES AVENUE, TORONTO, ON M6R 2N1 CANADA T 416.340.8700 F 416.340.7100 NAKDESIGNSTRATEGIES.COM

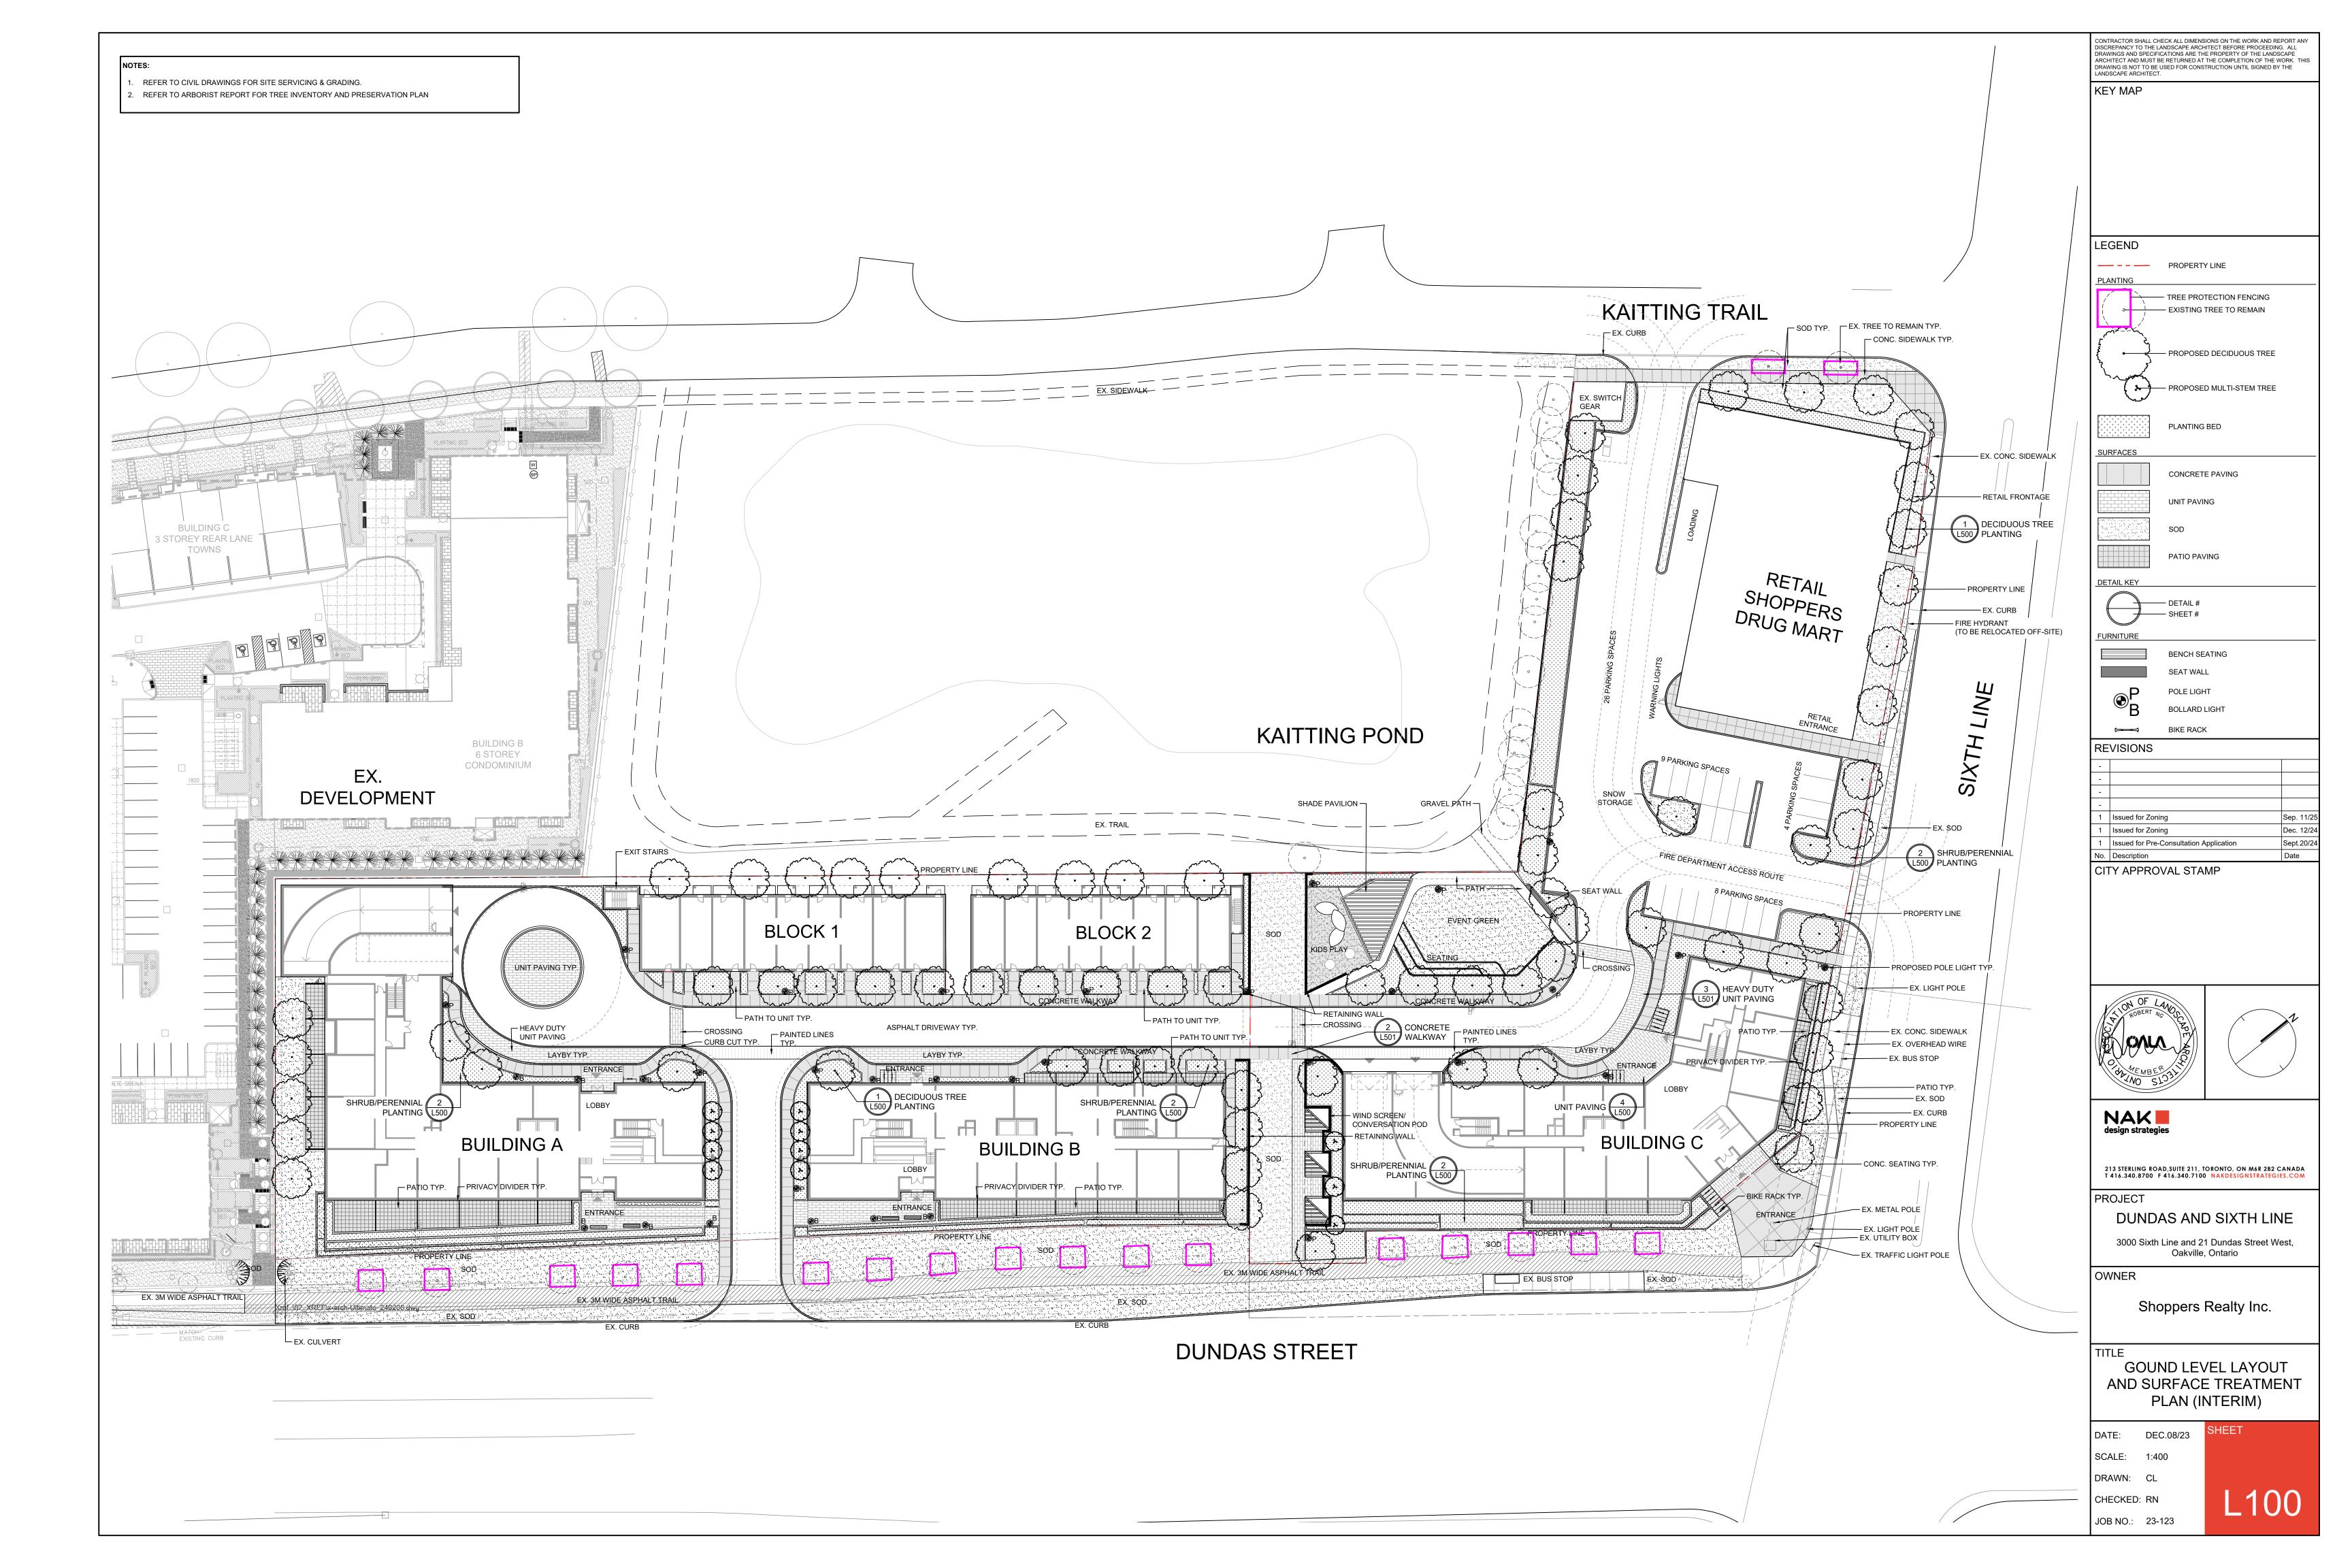


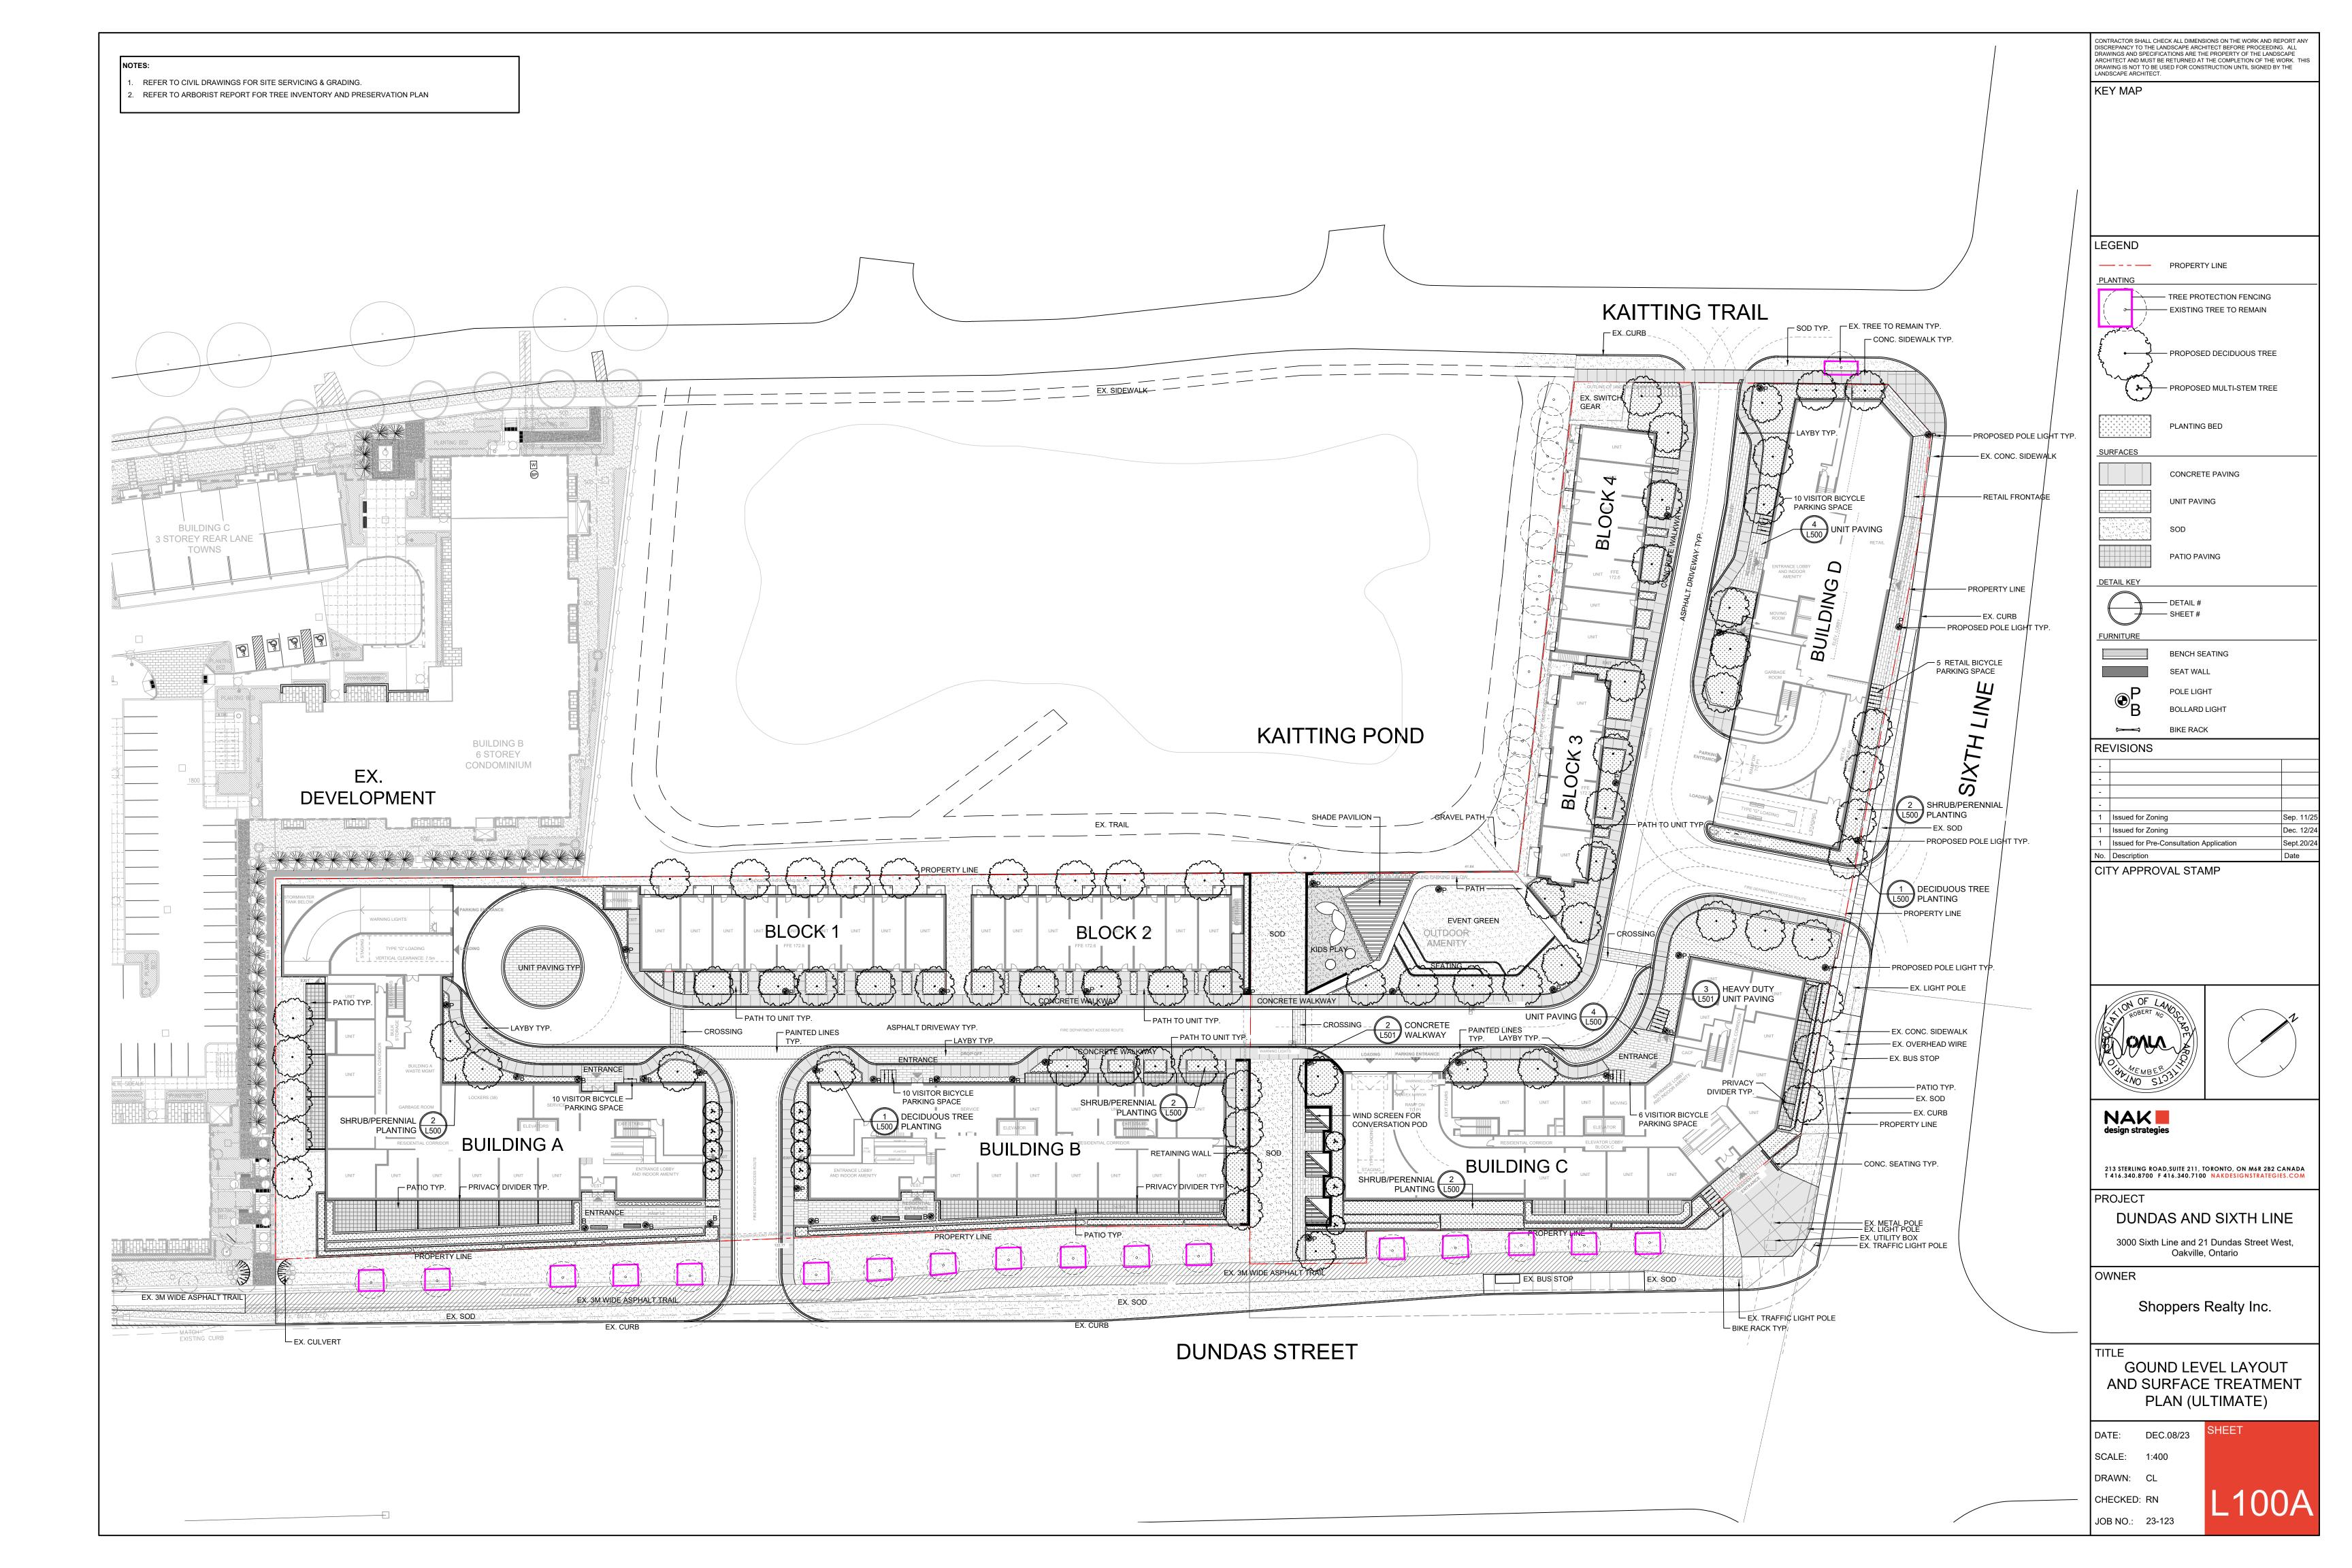


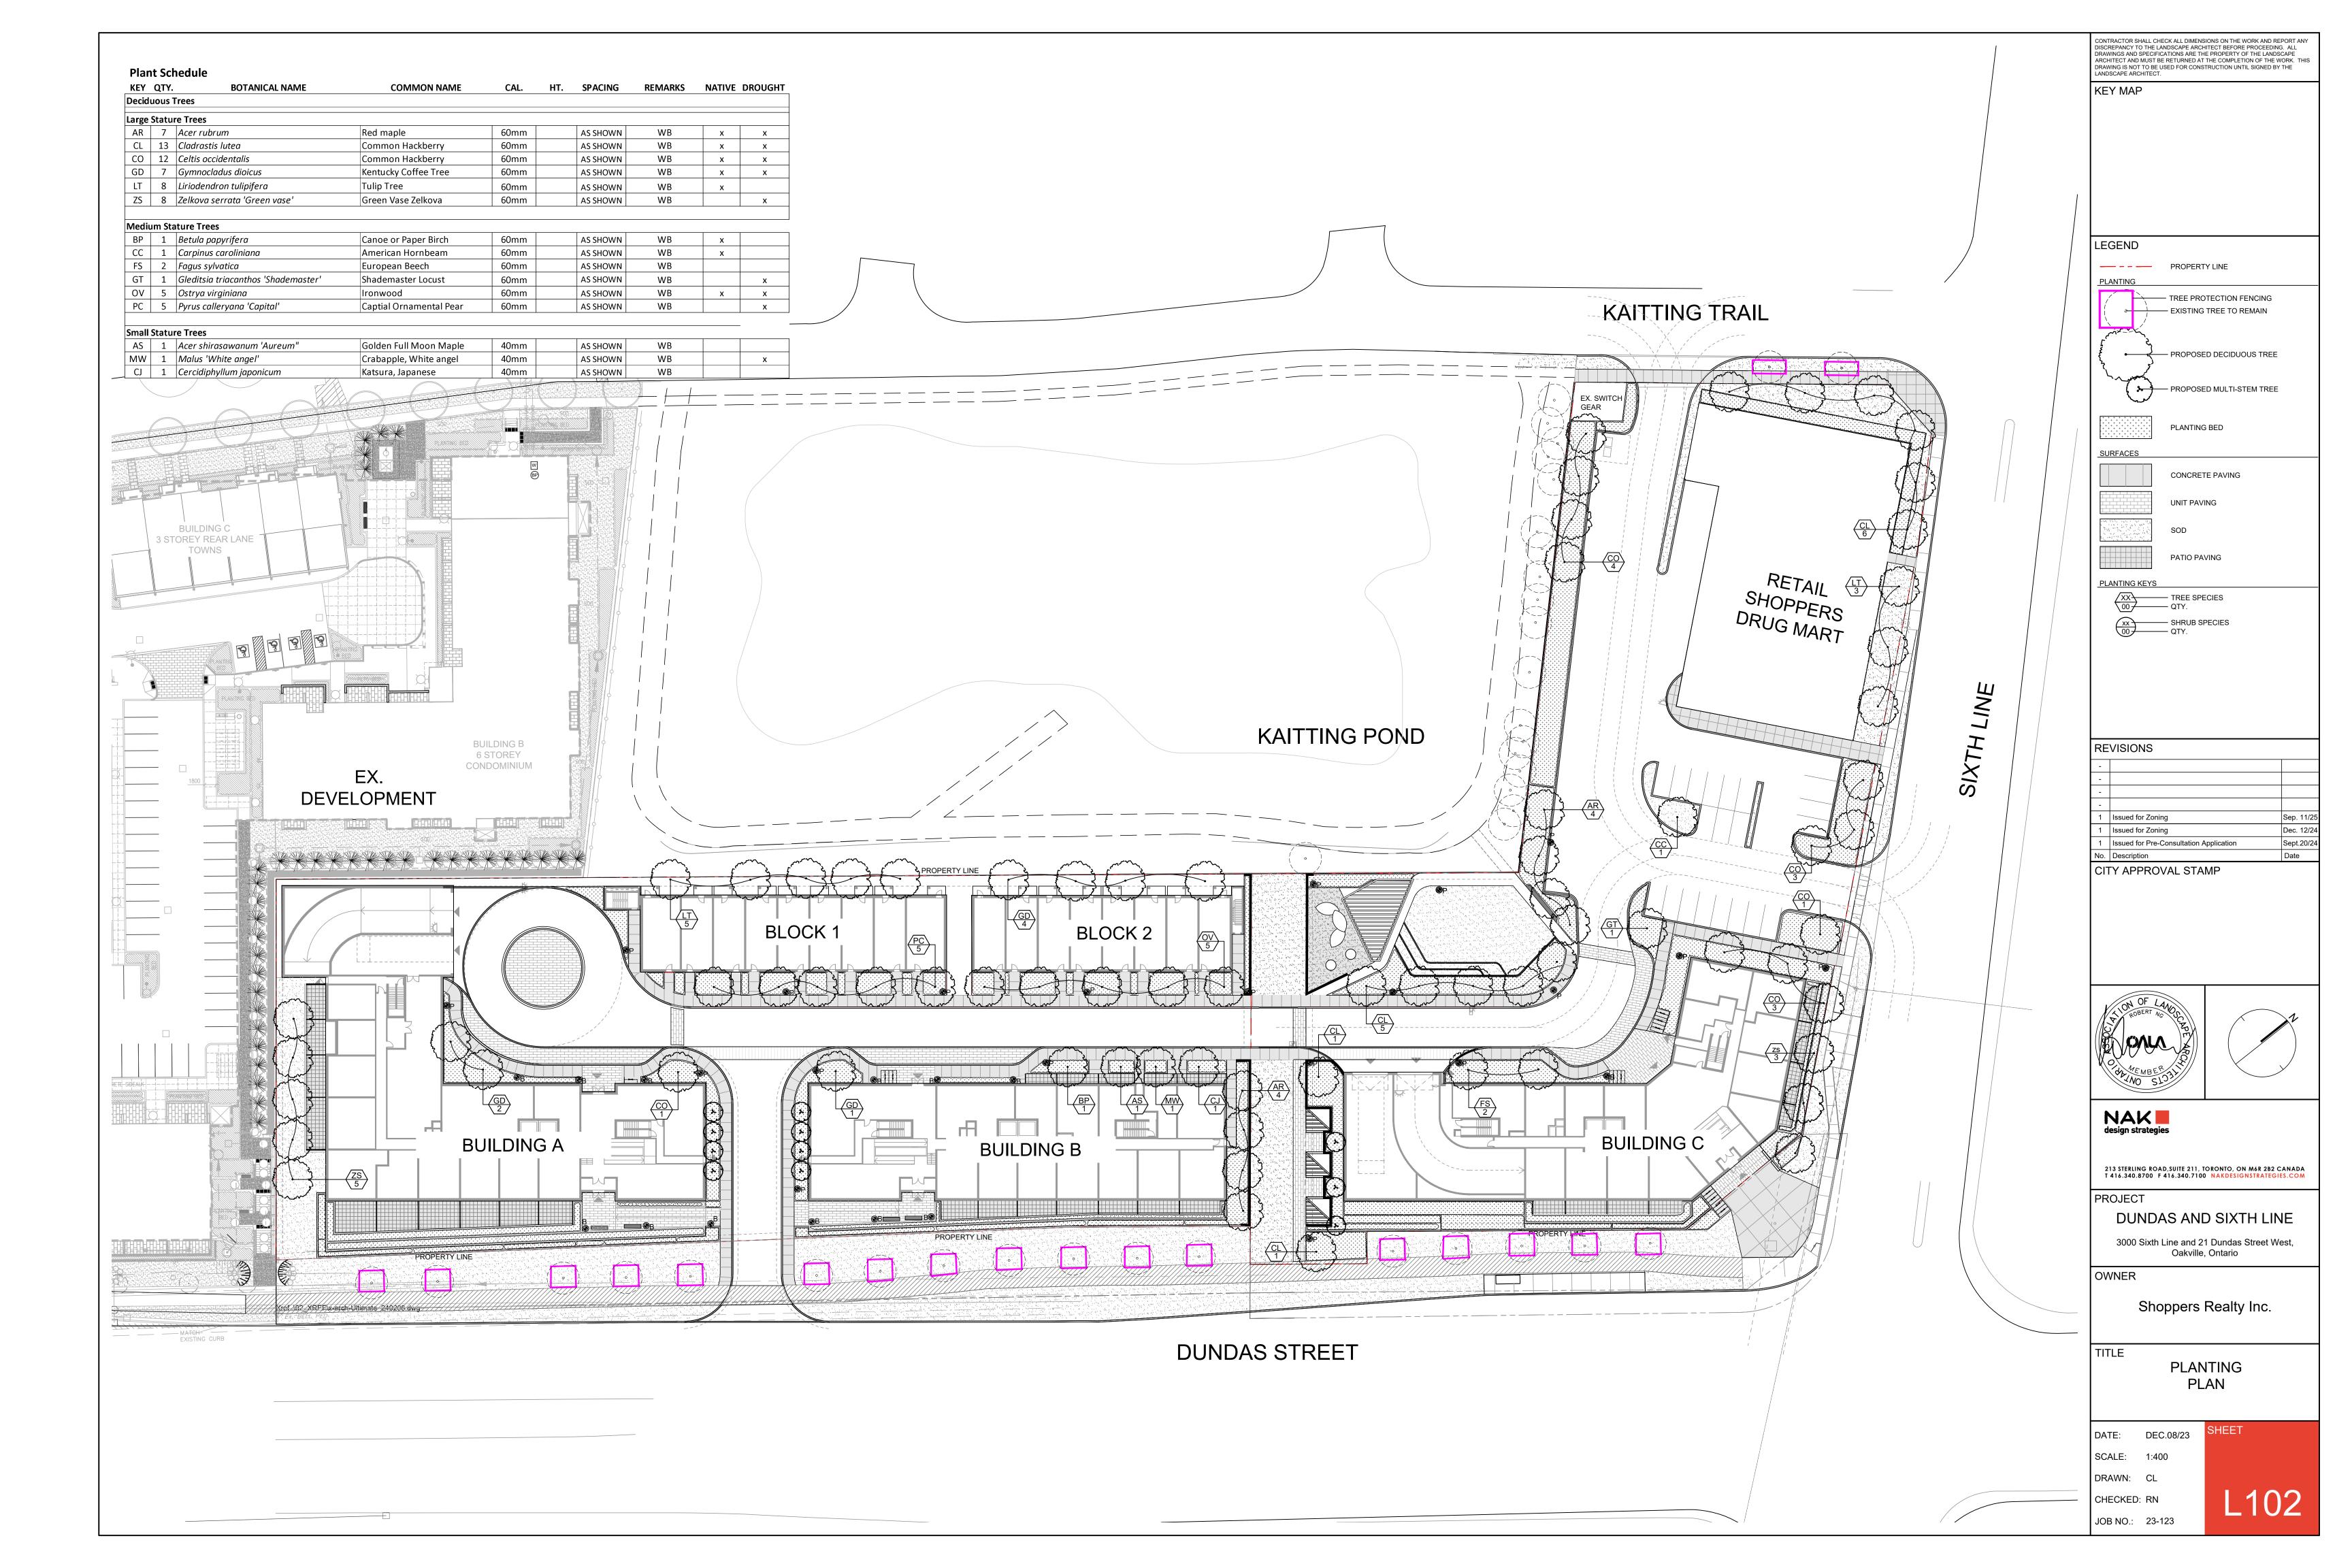


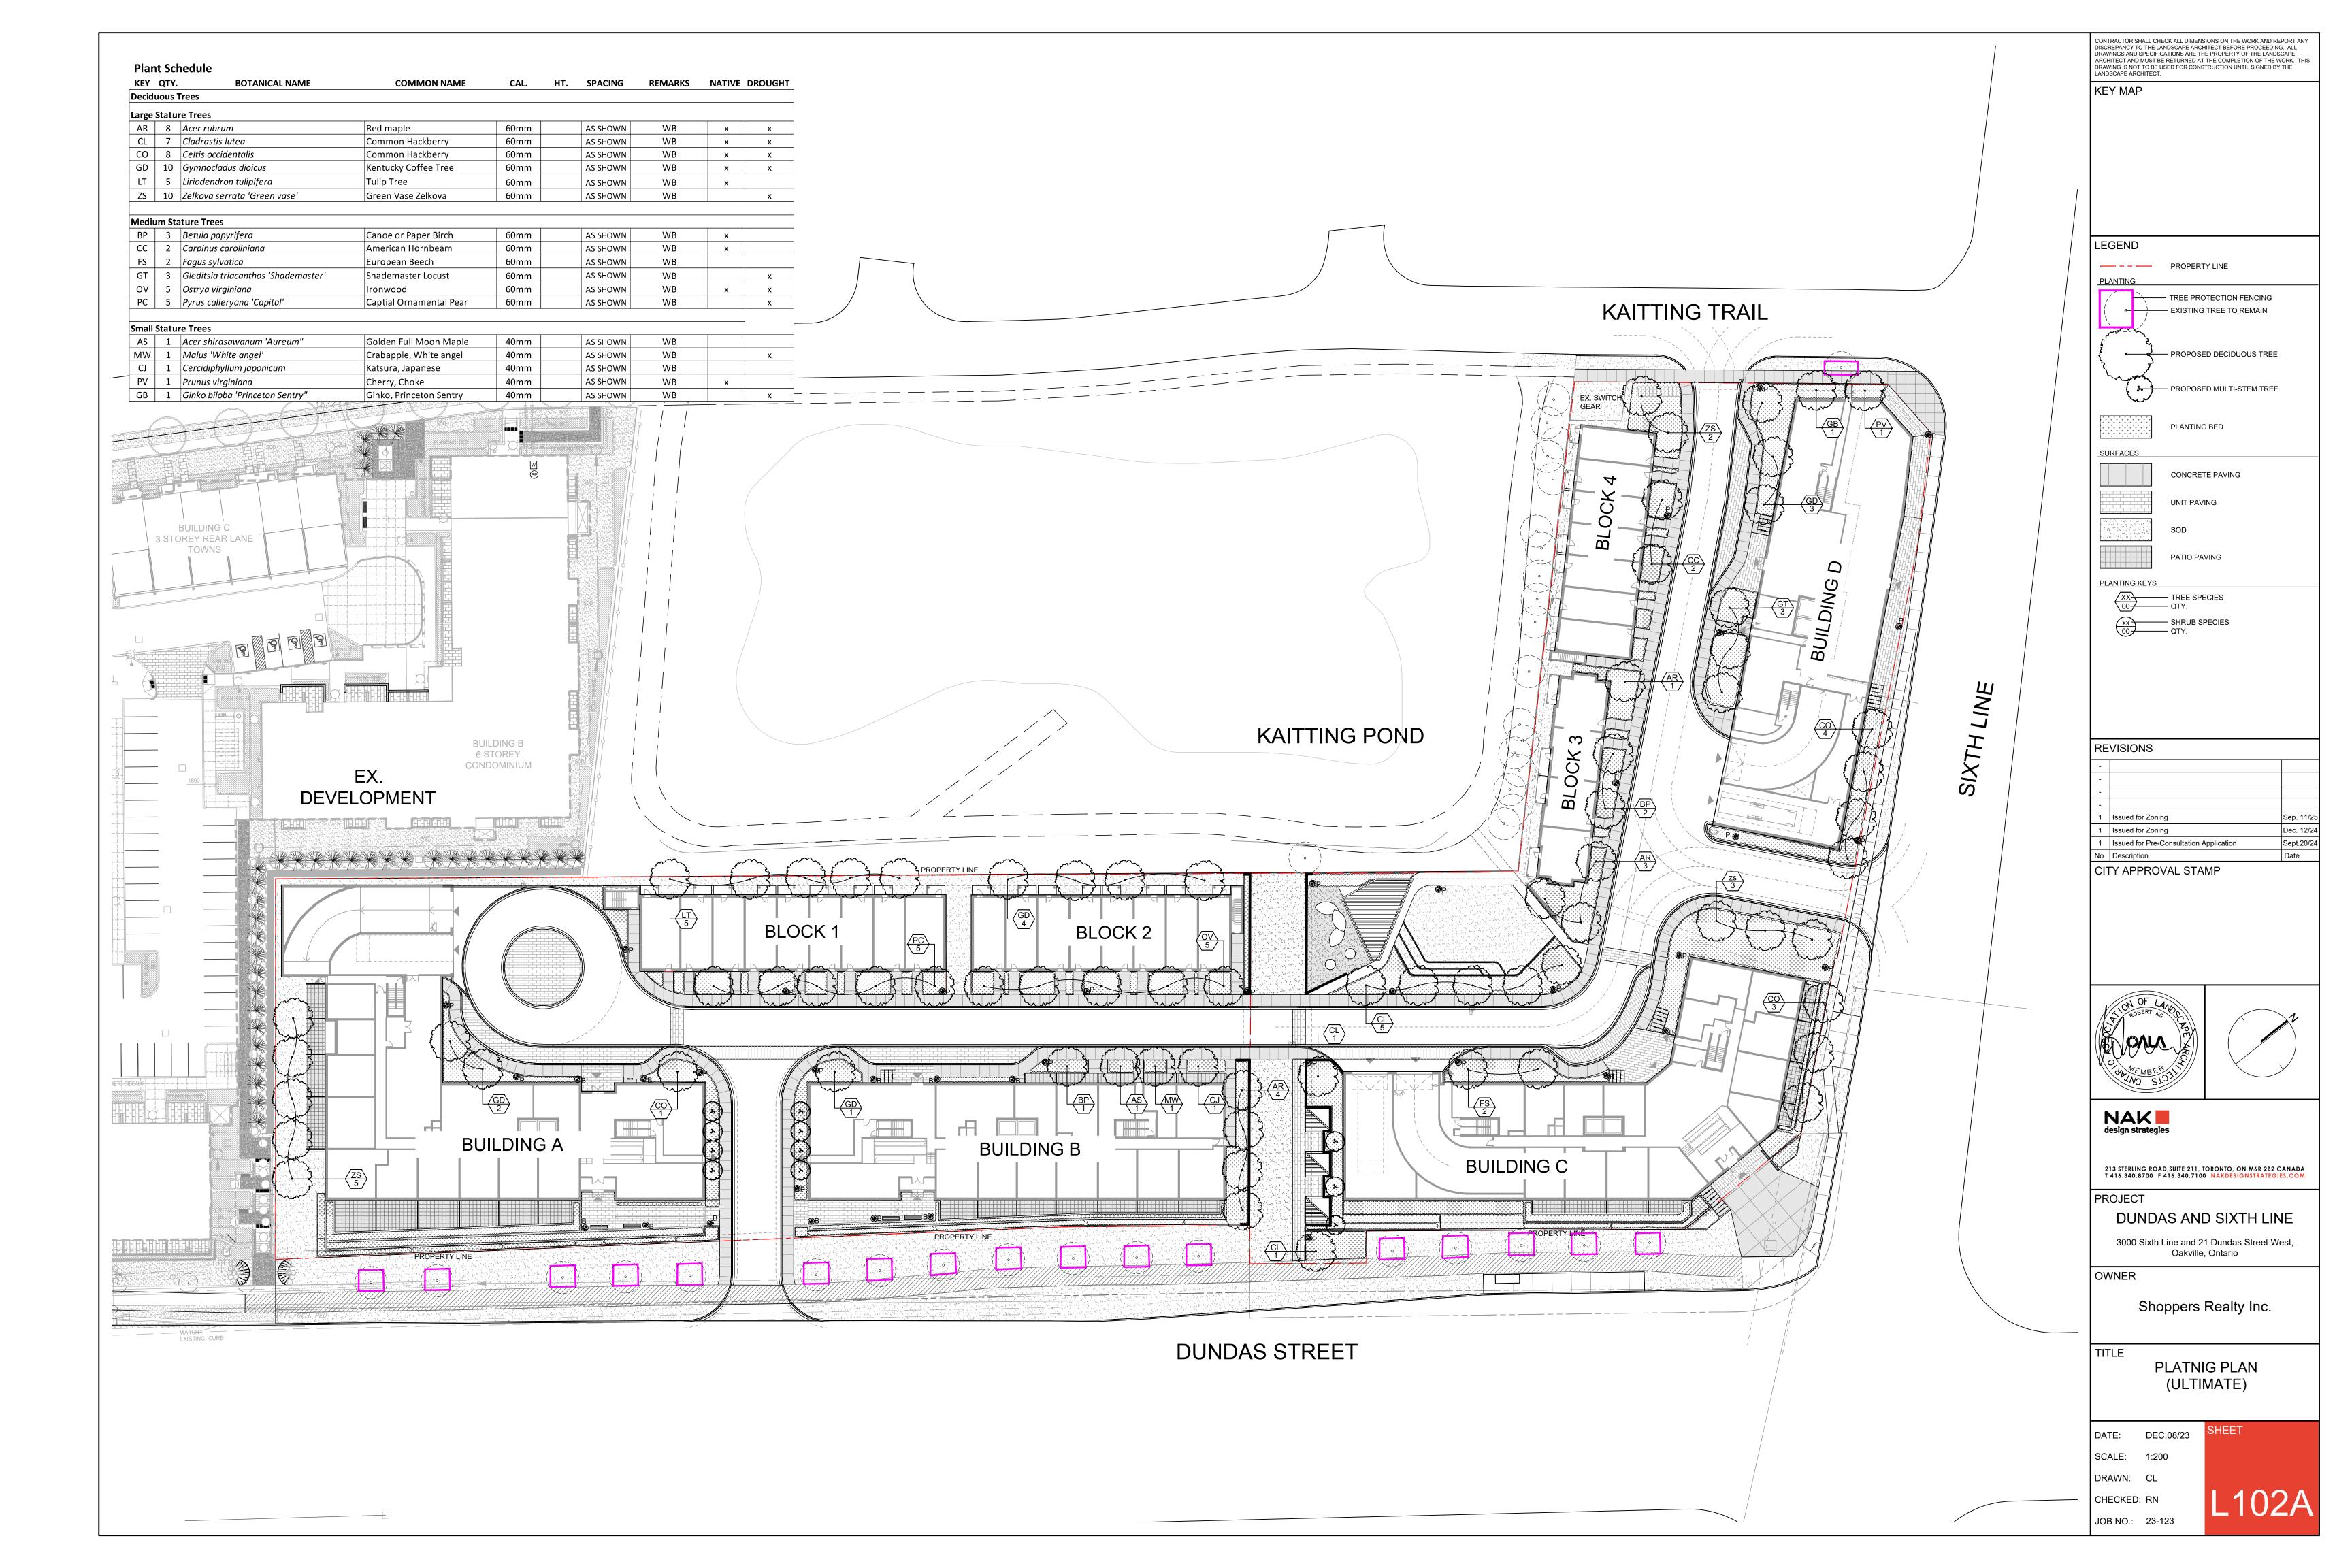


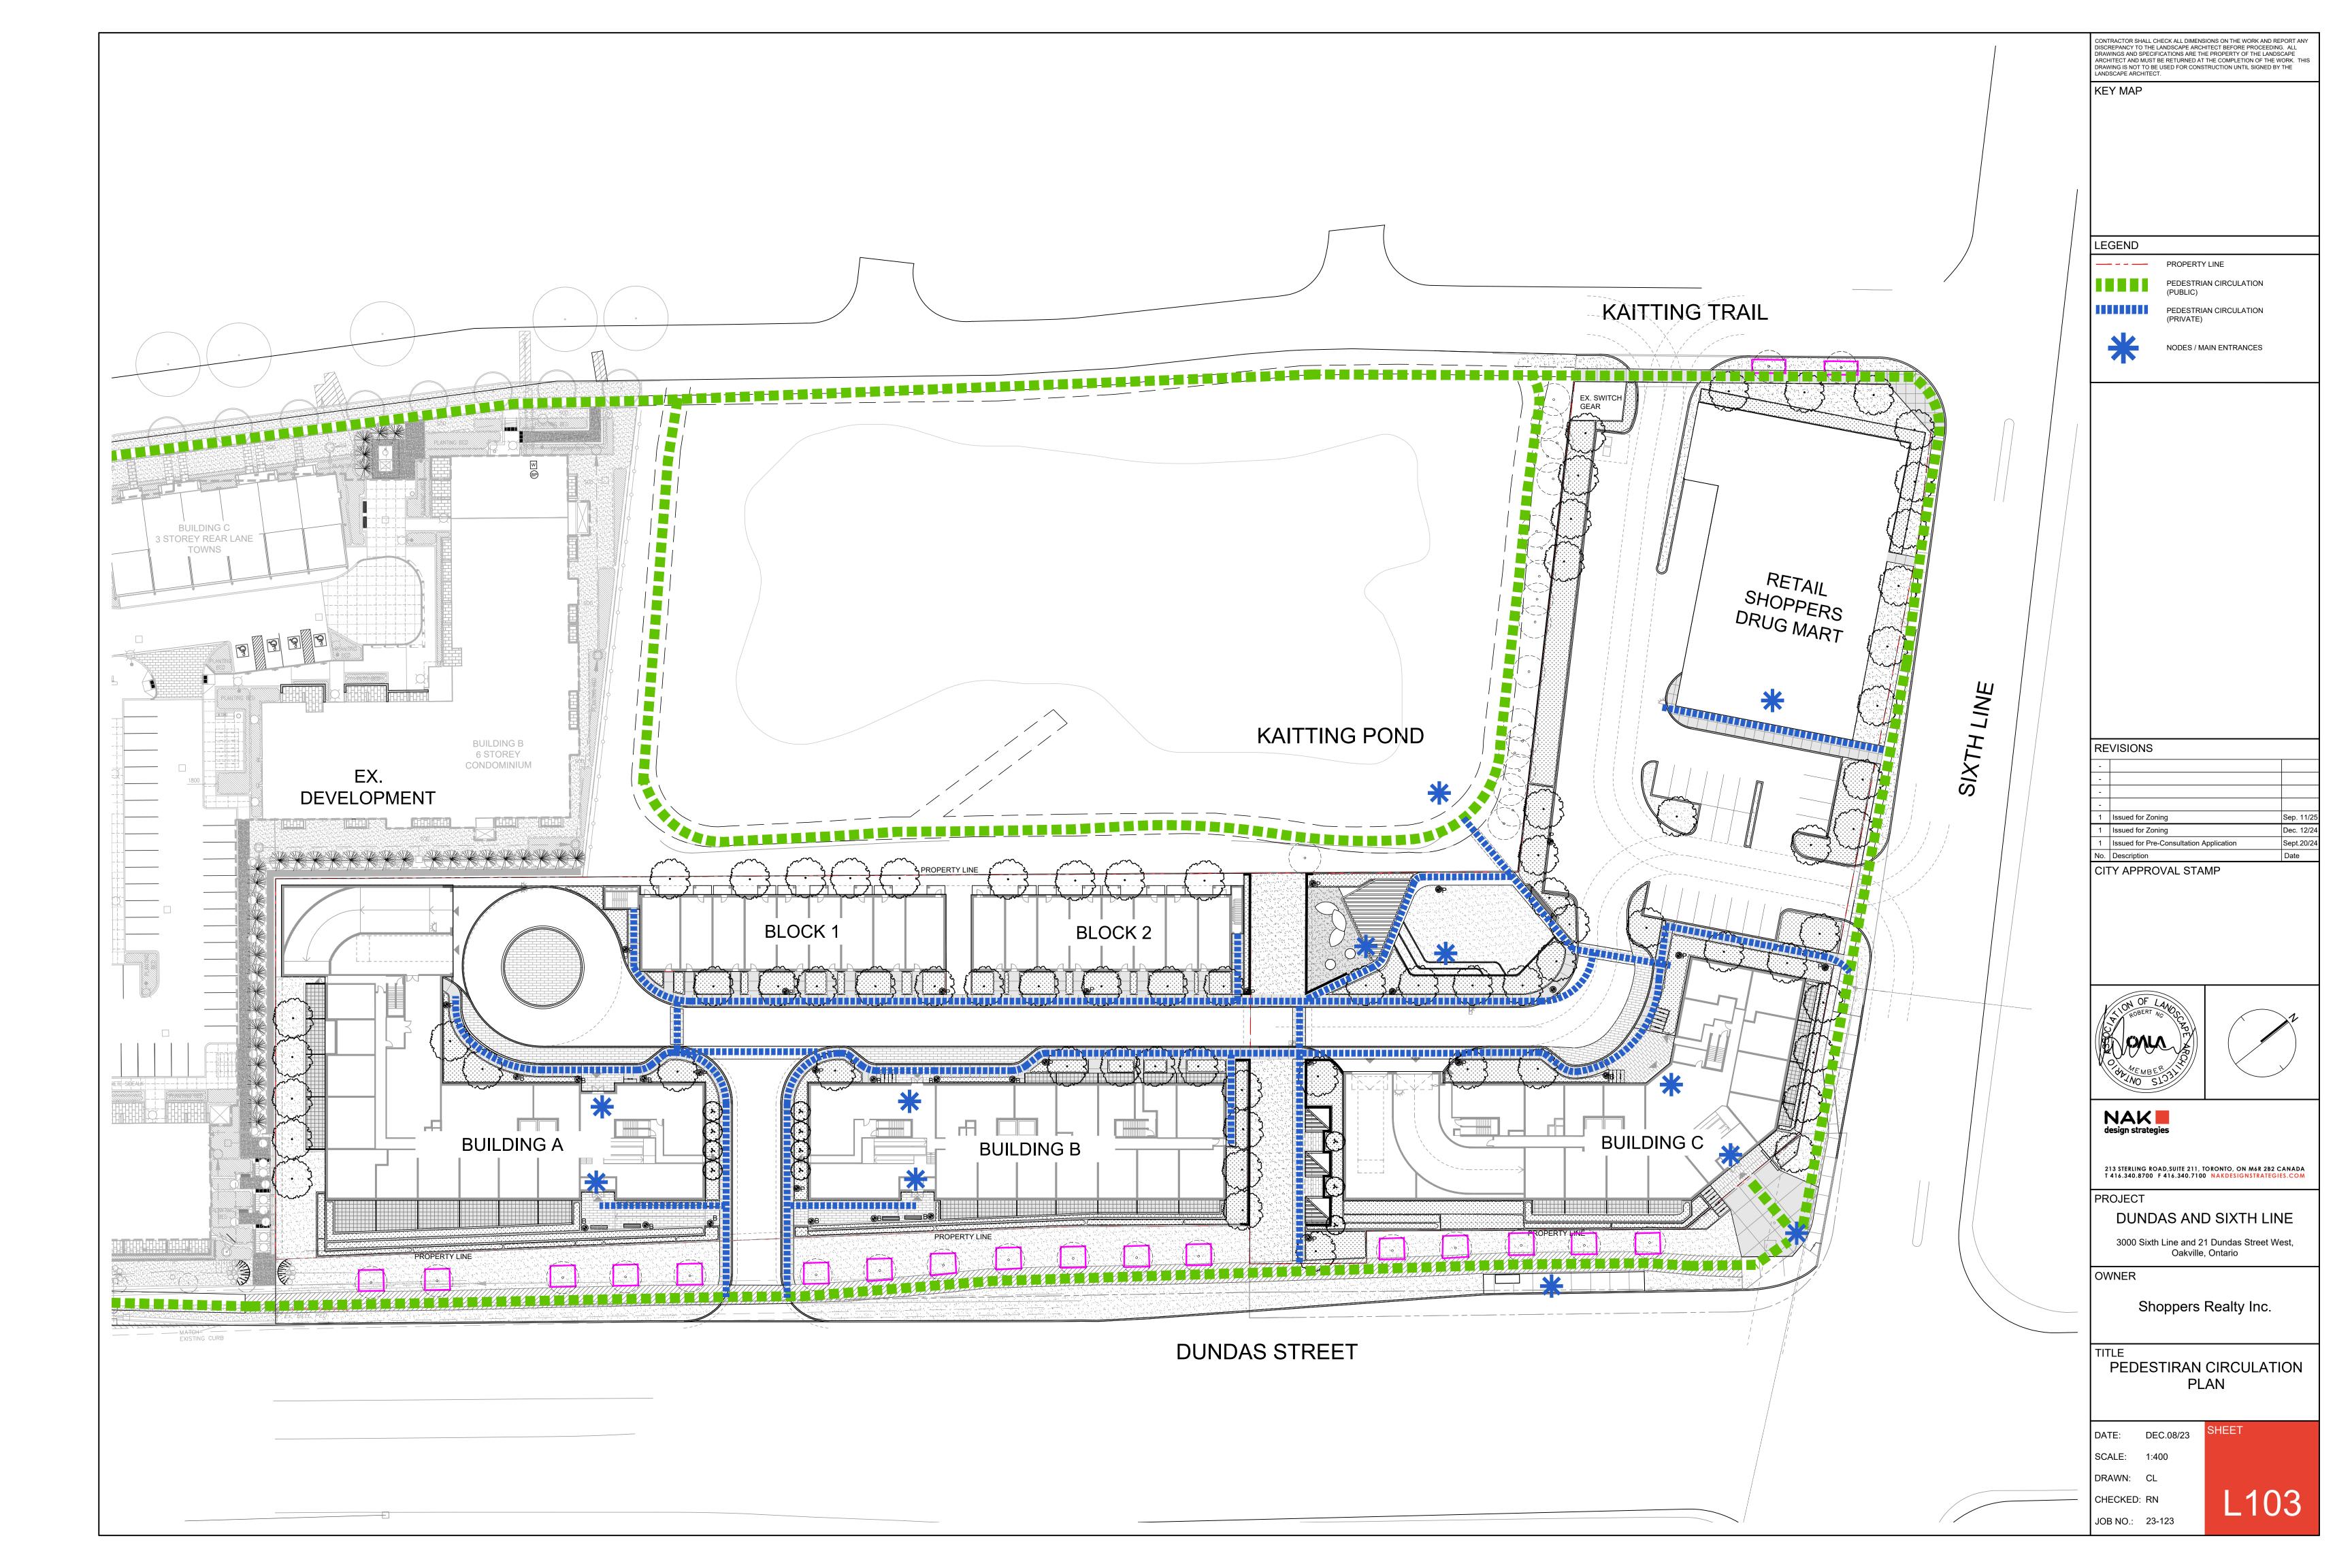


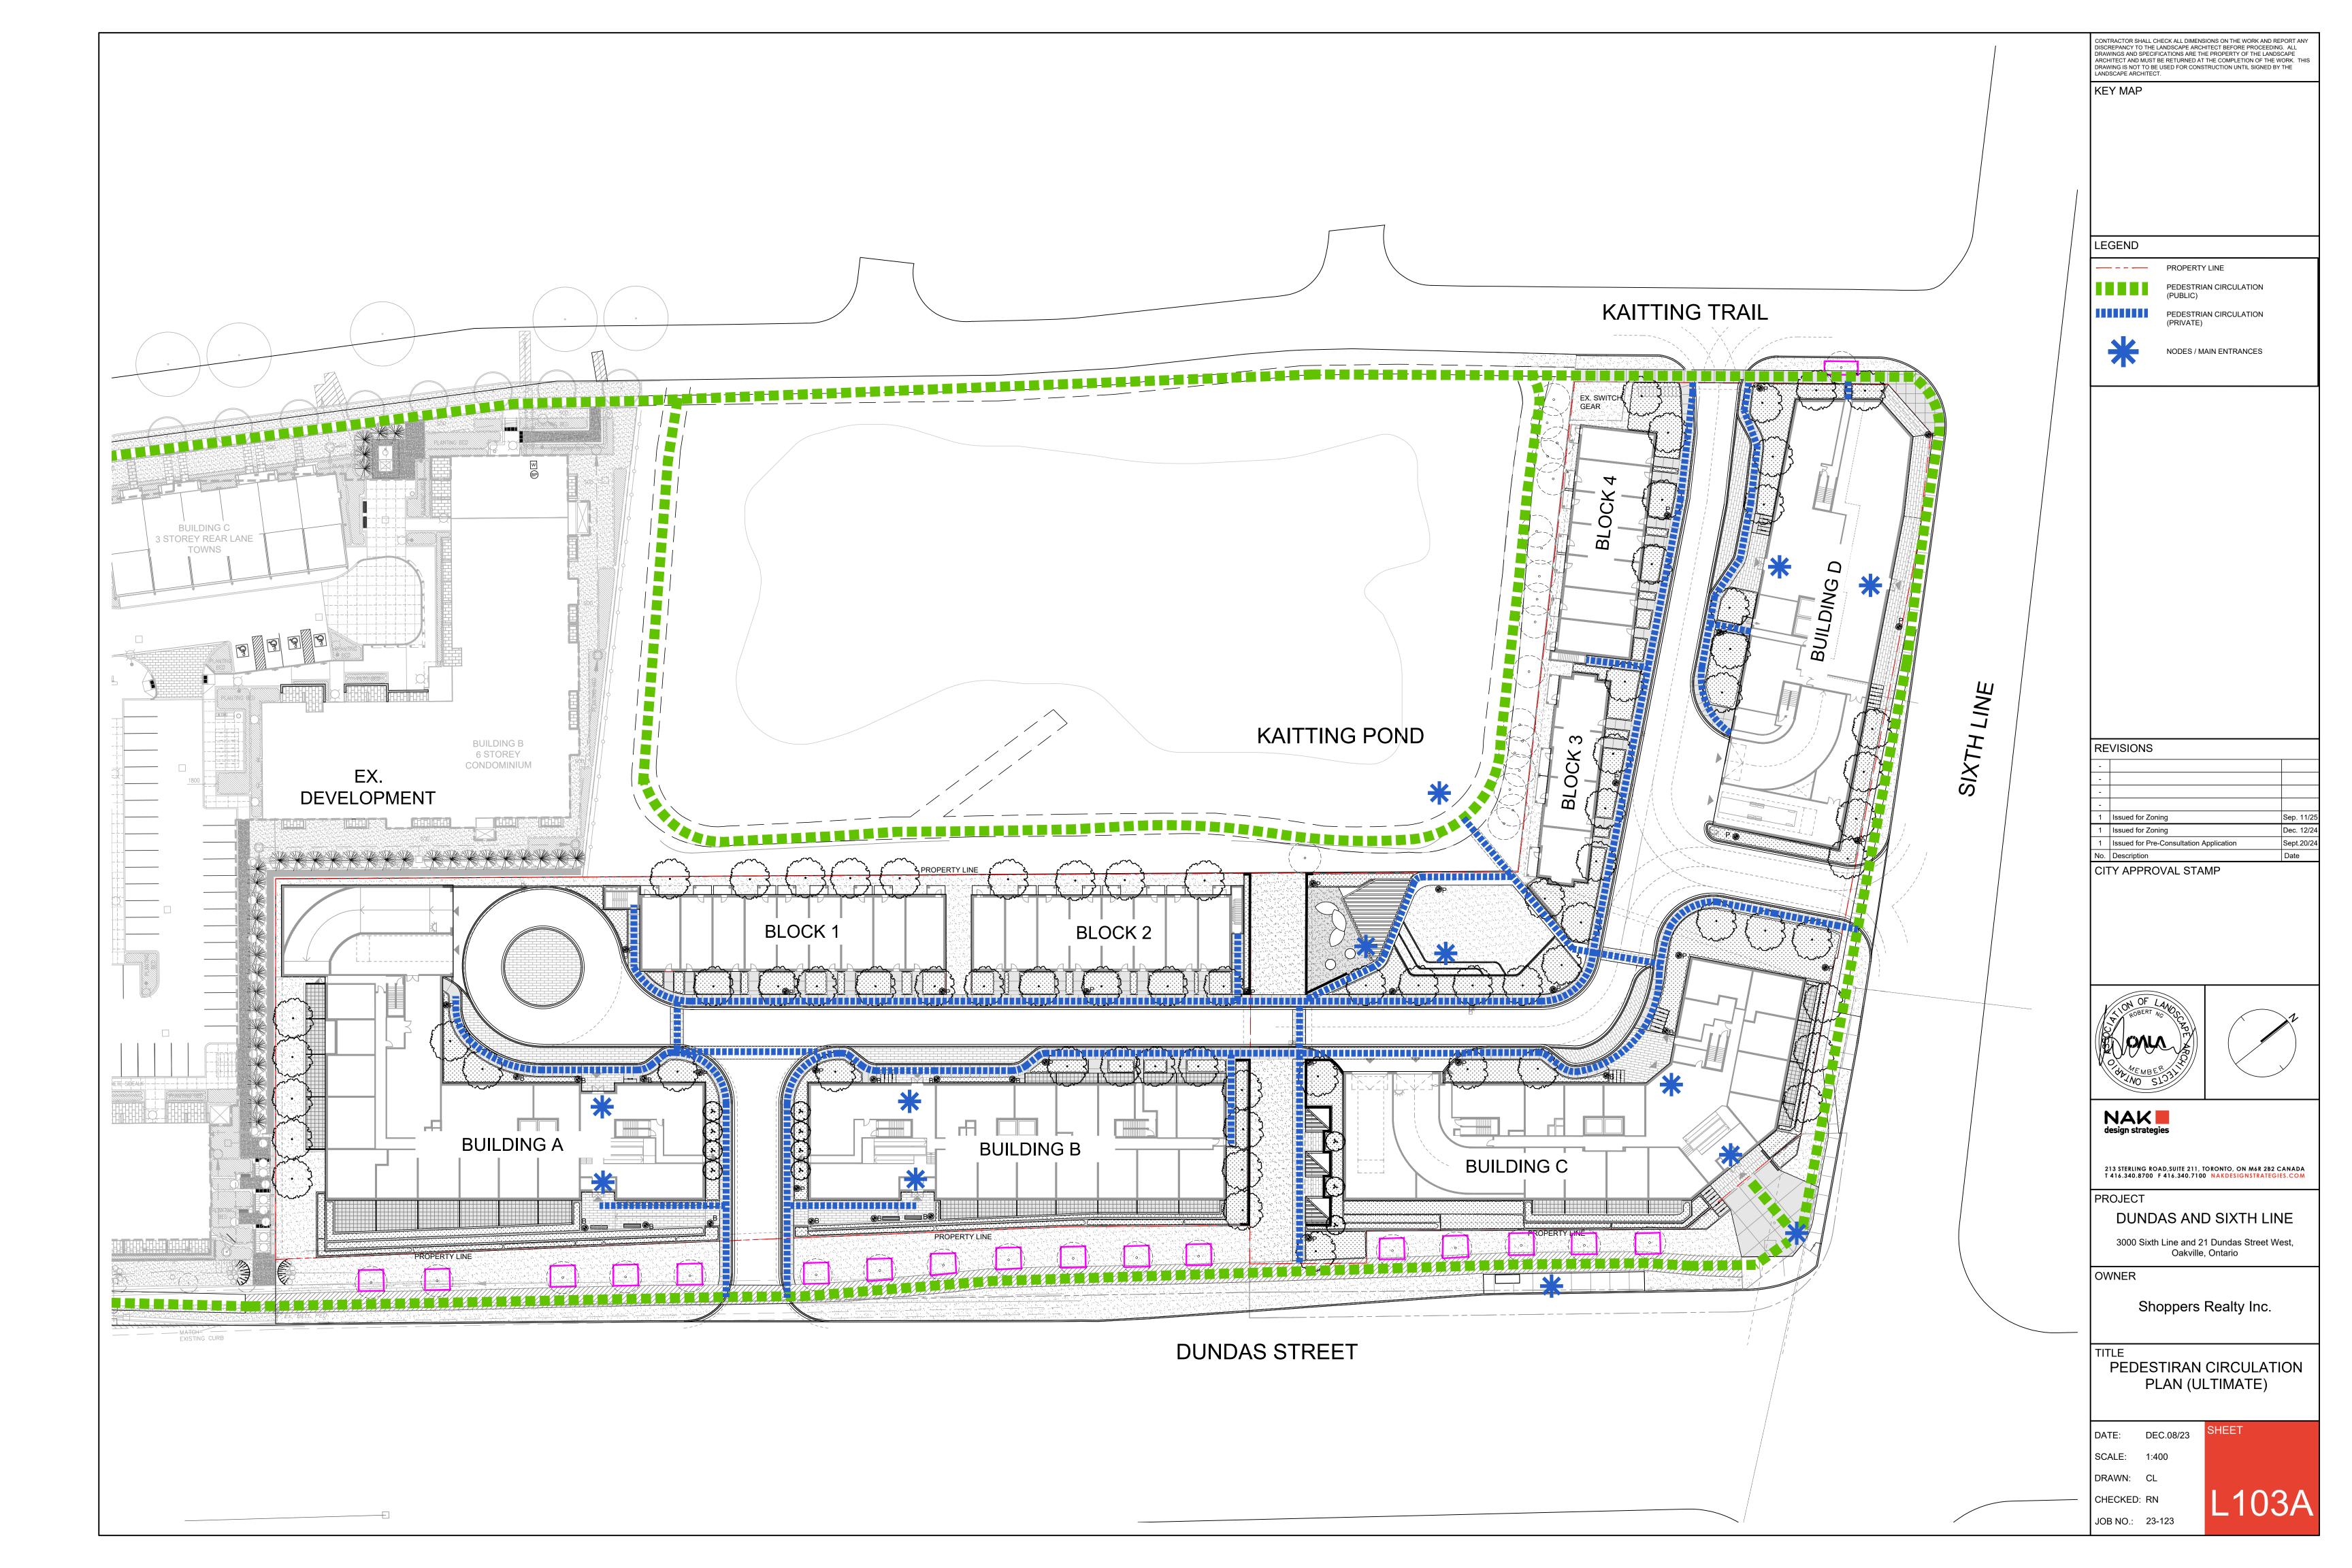


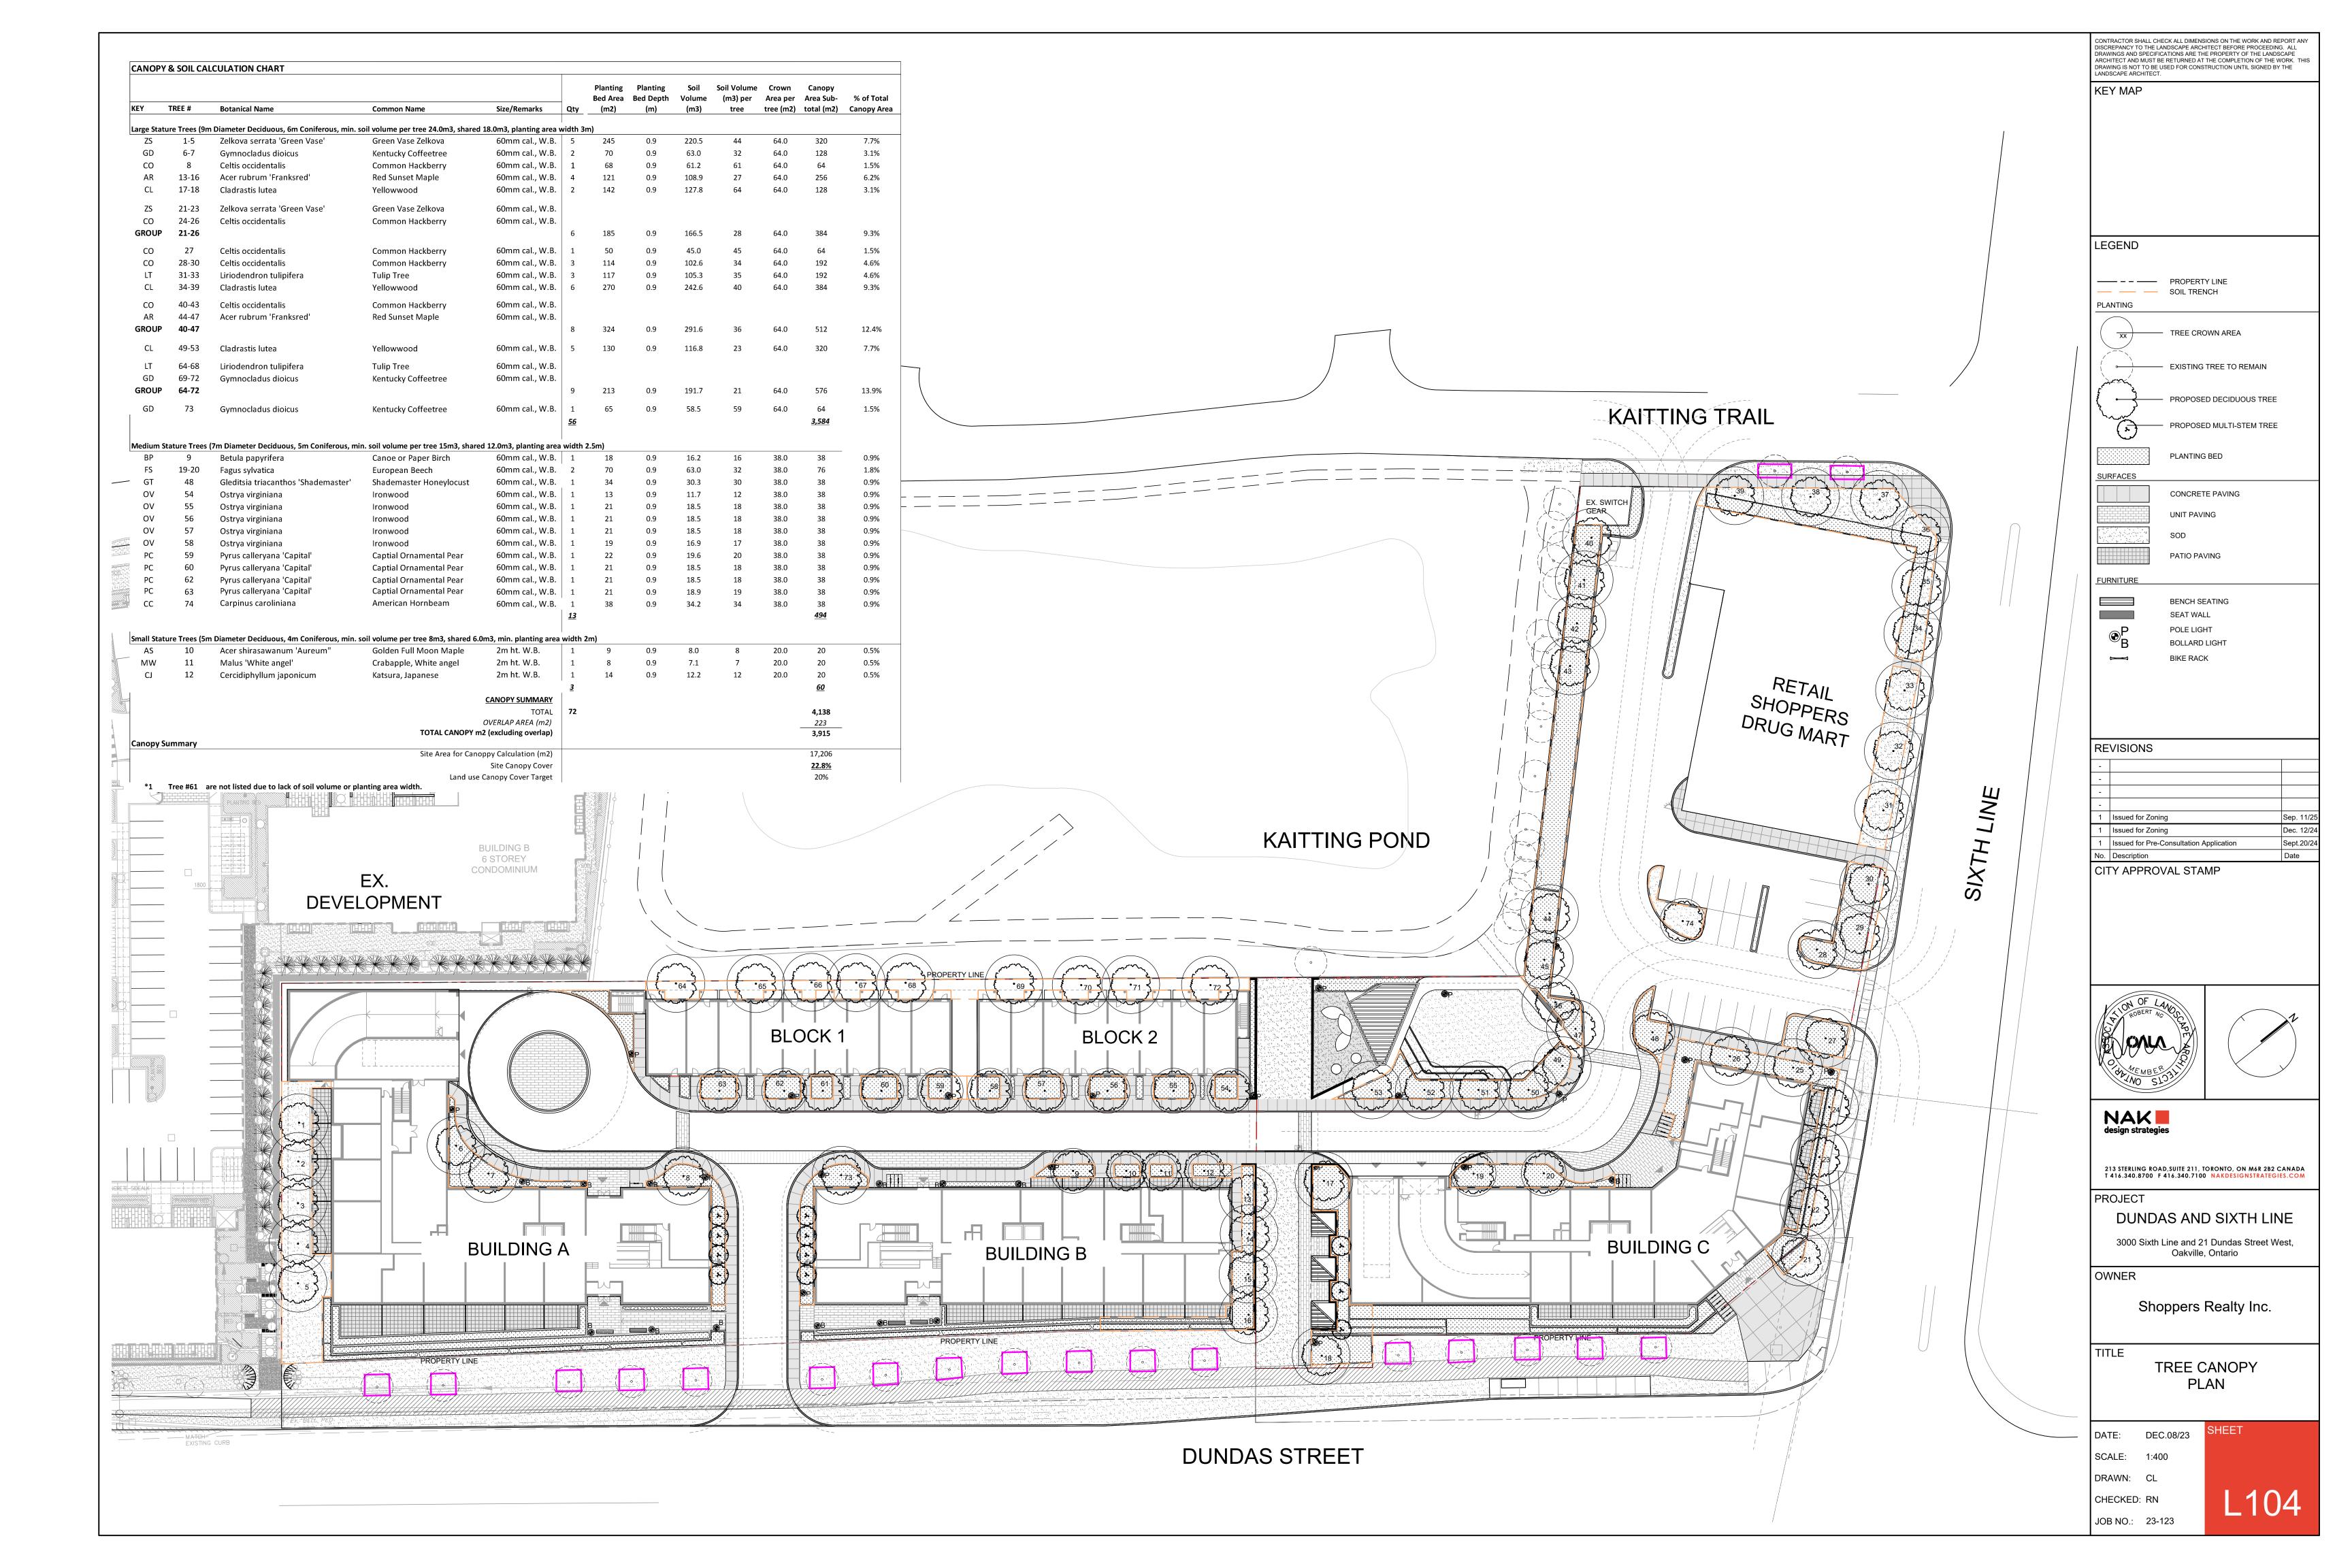


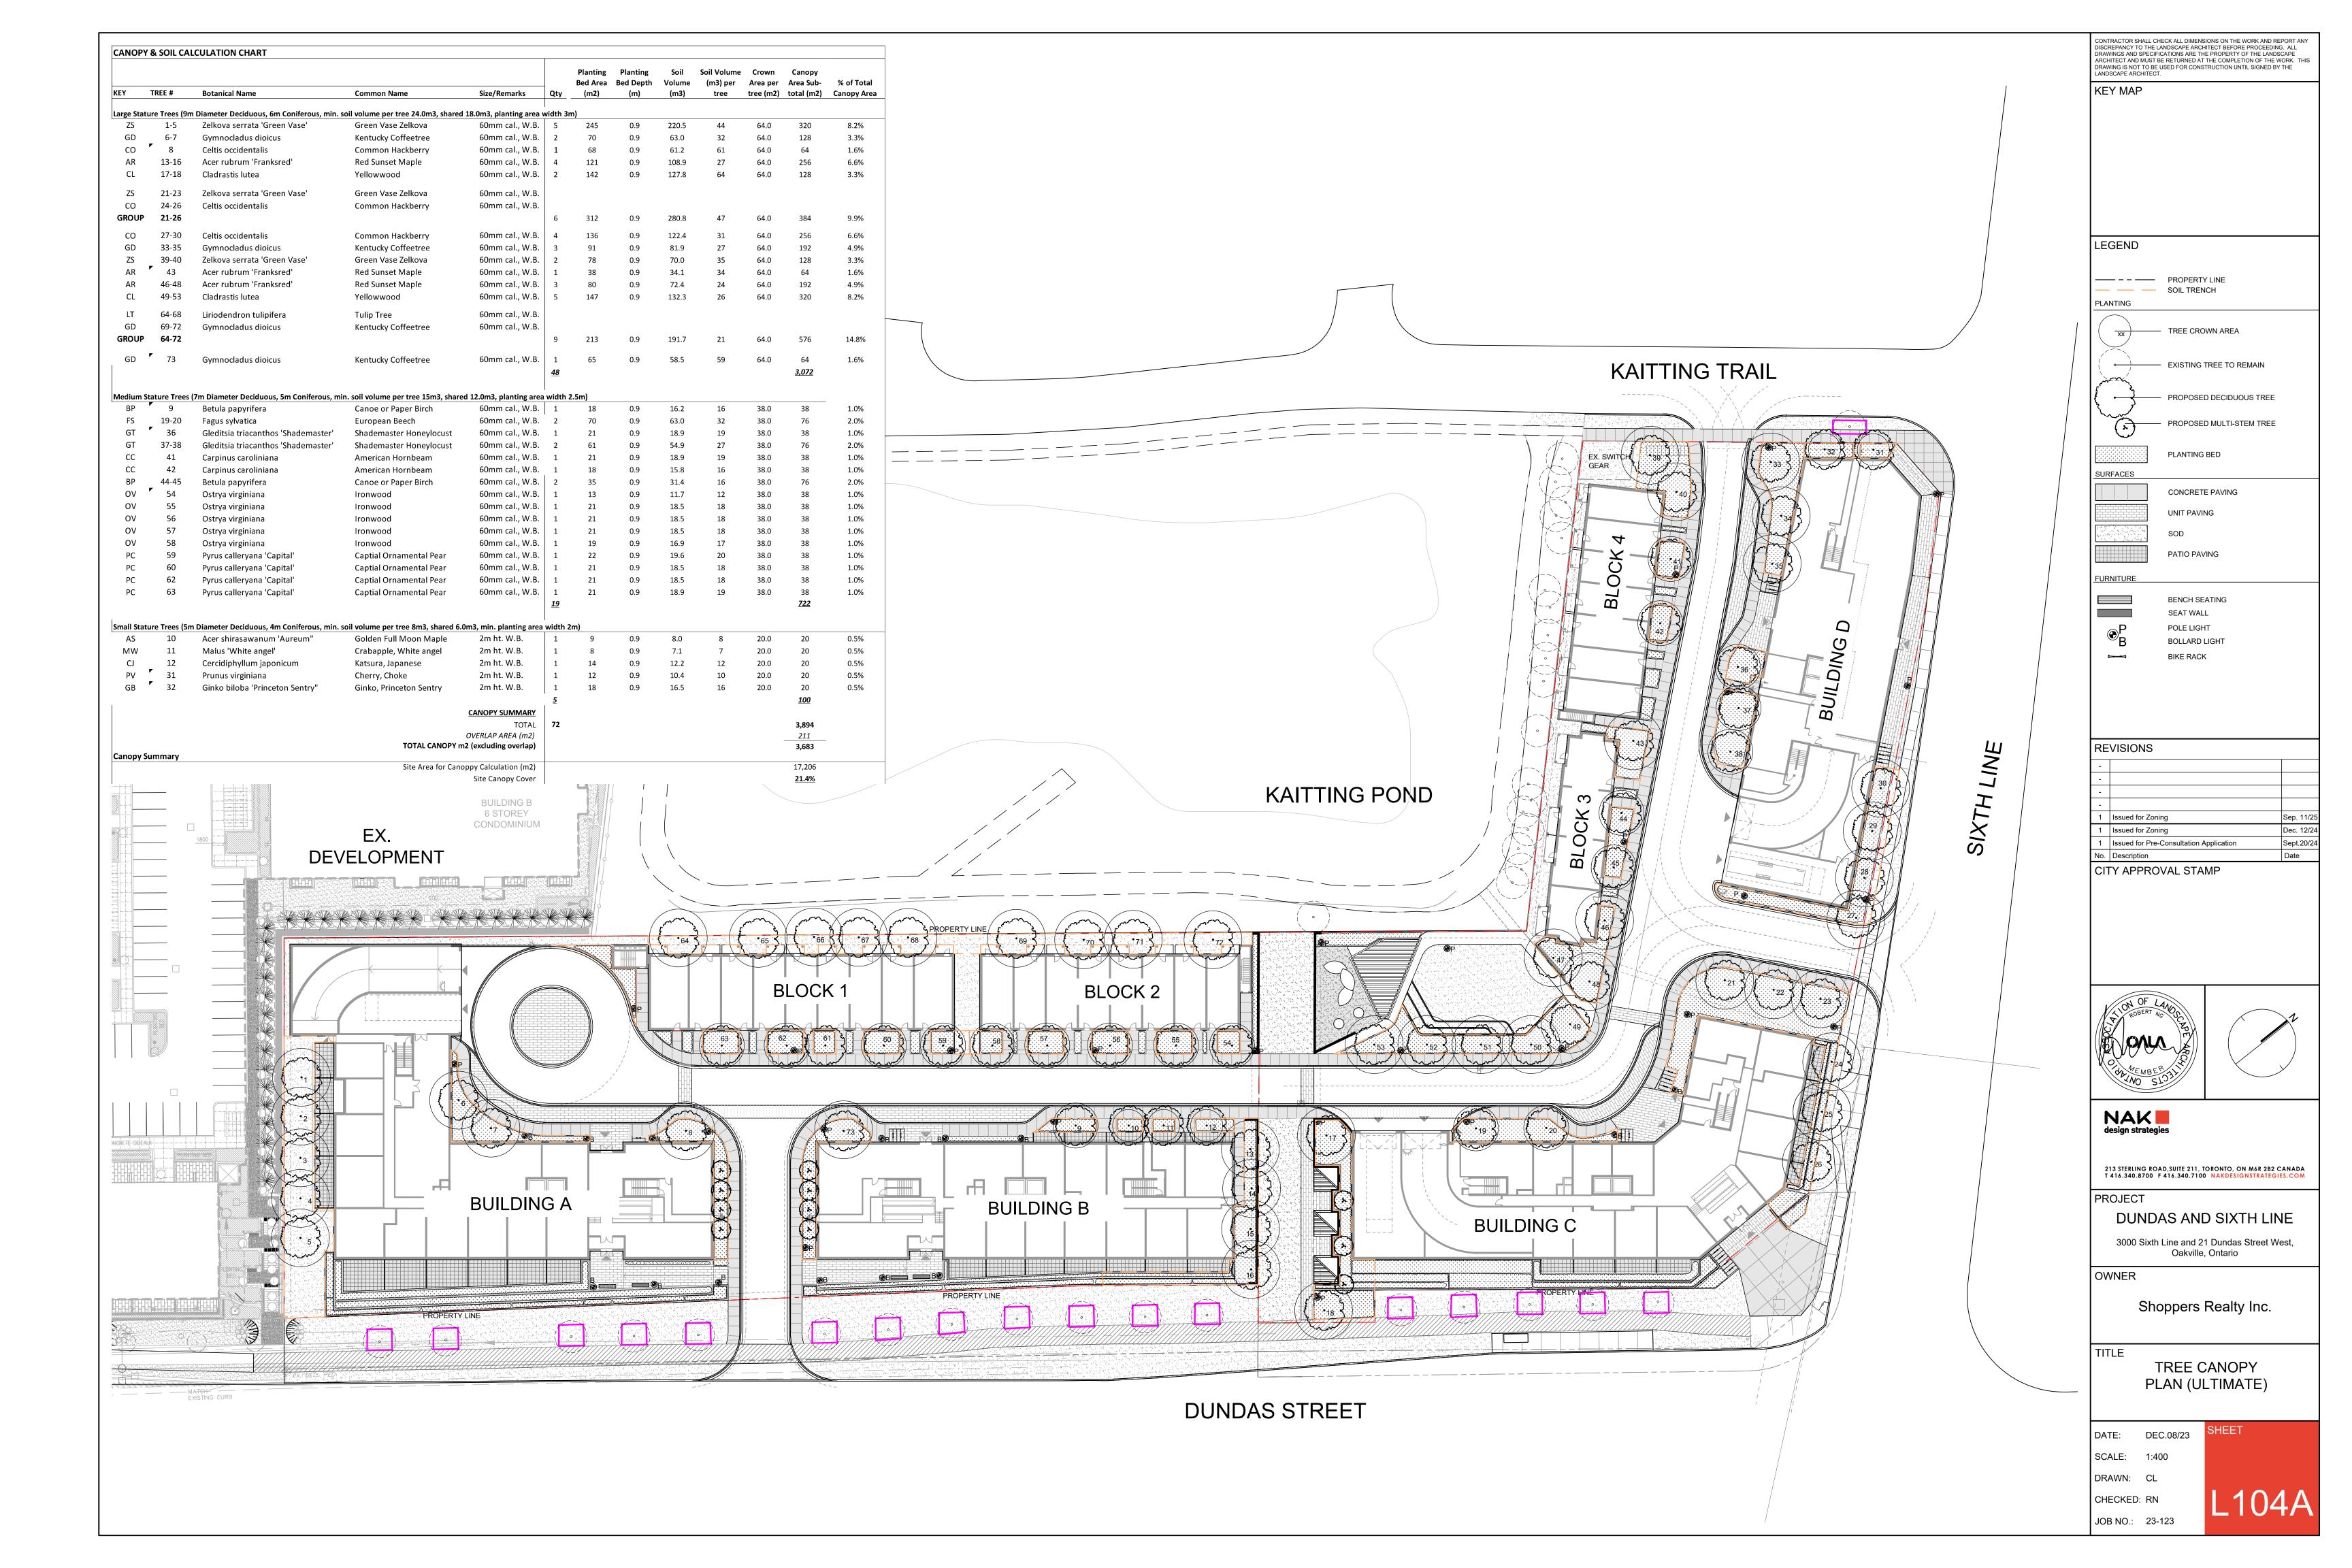

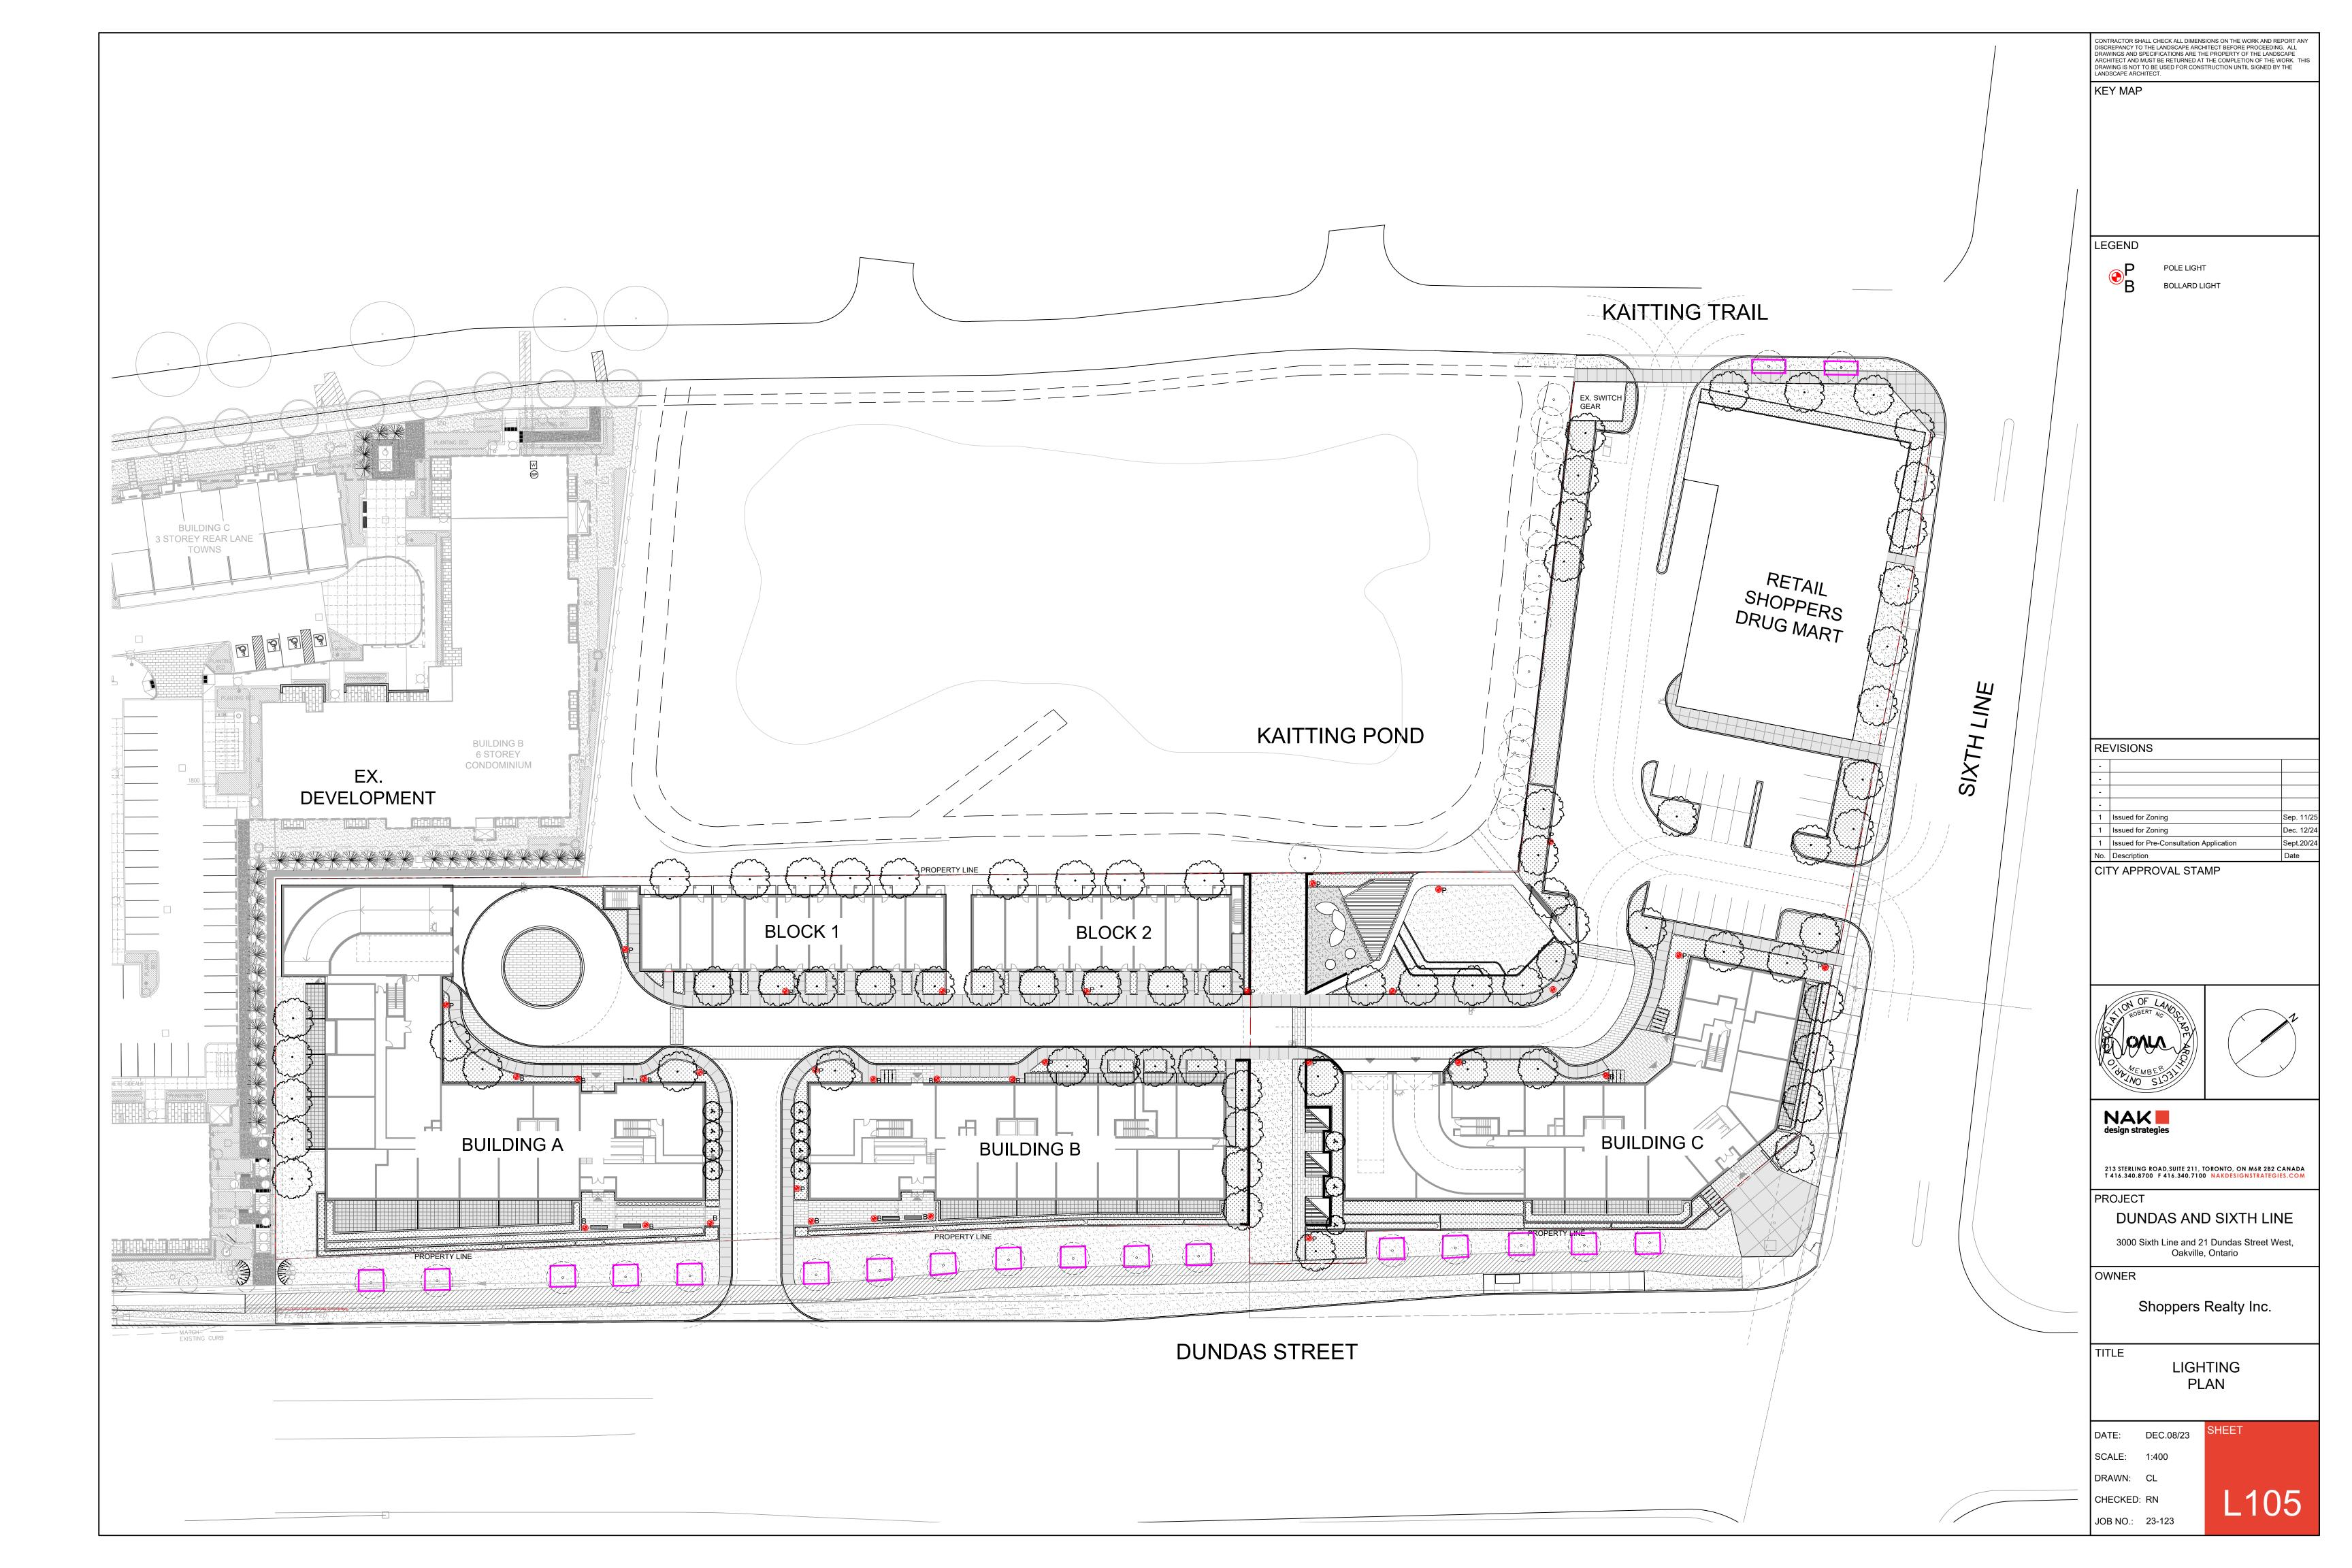

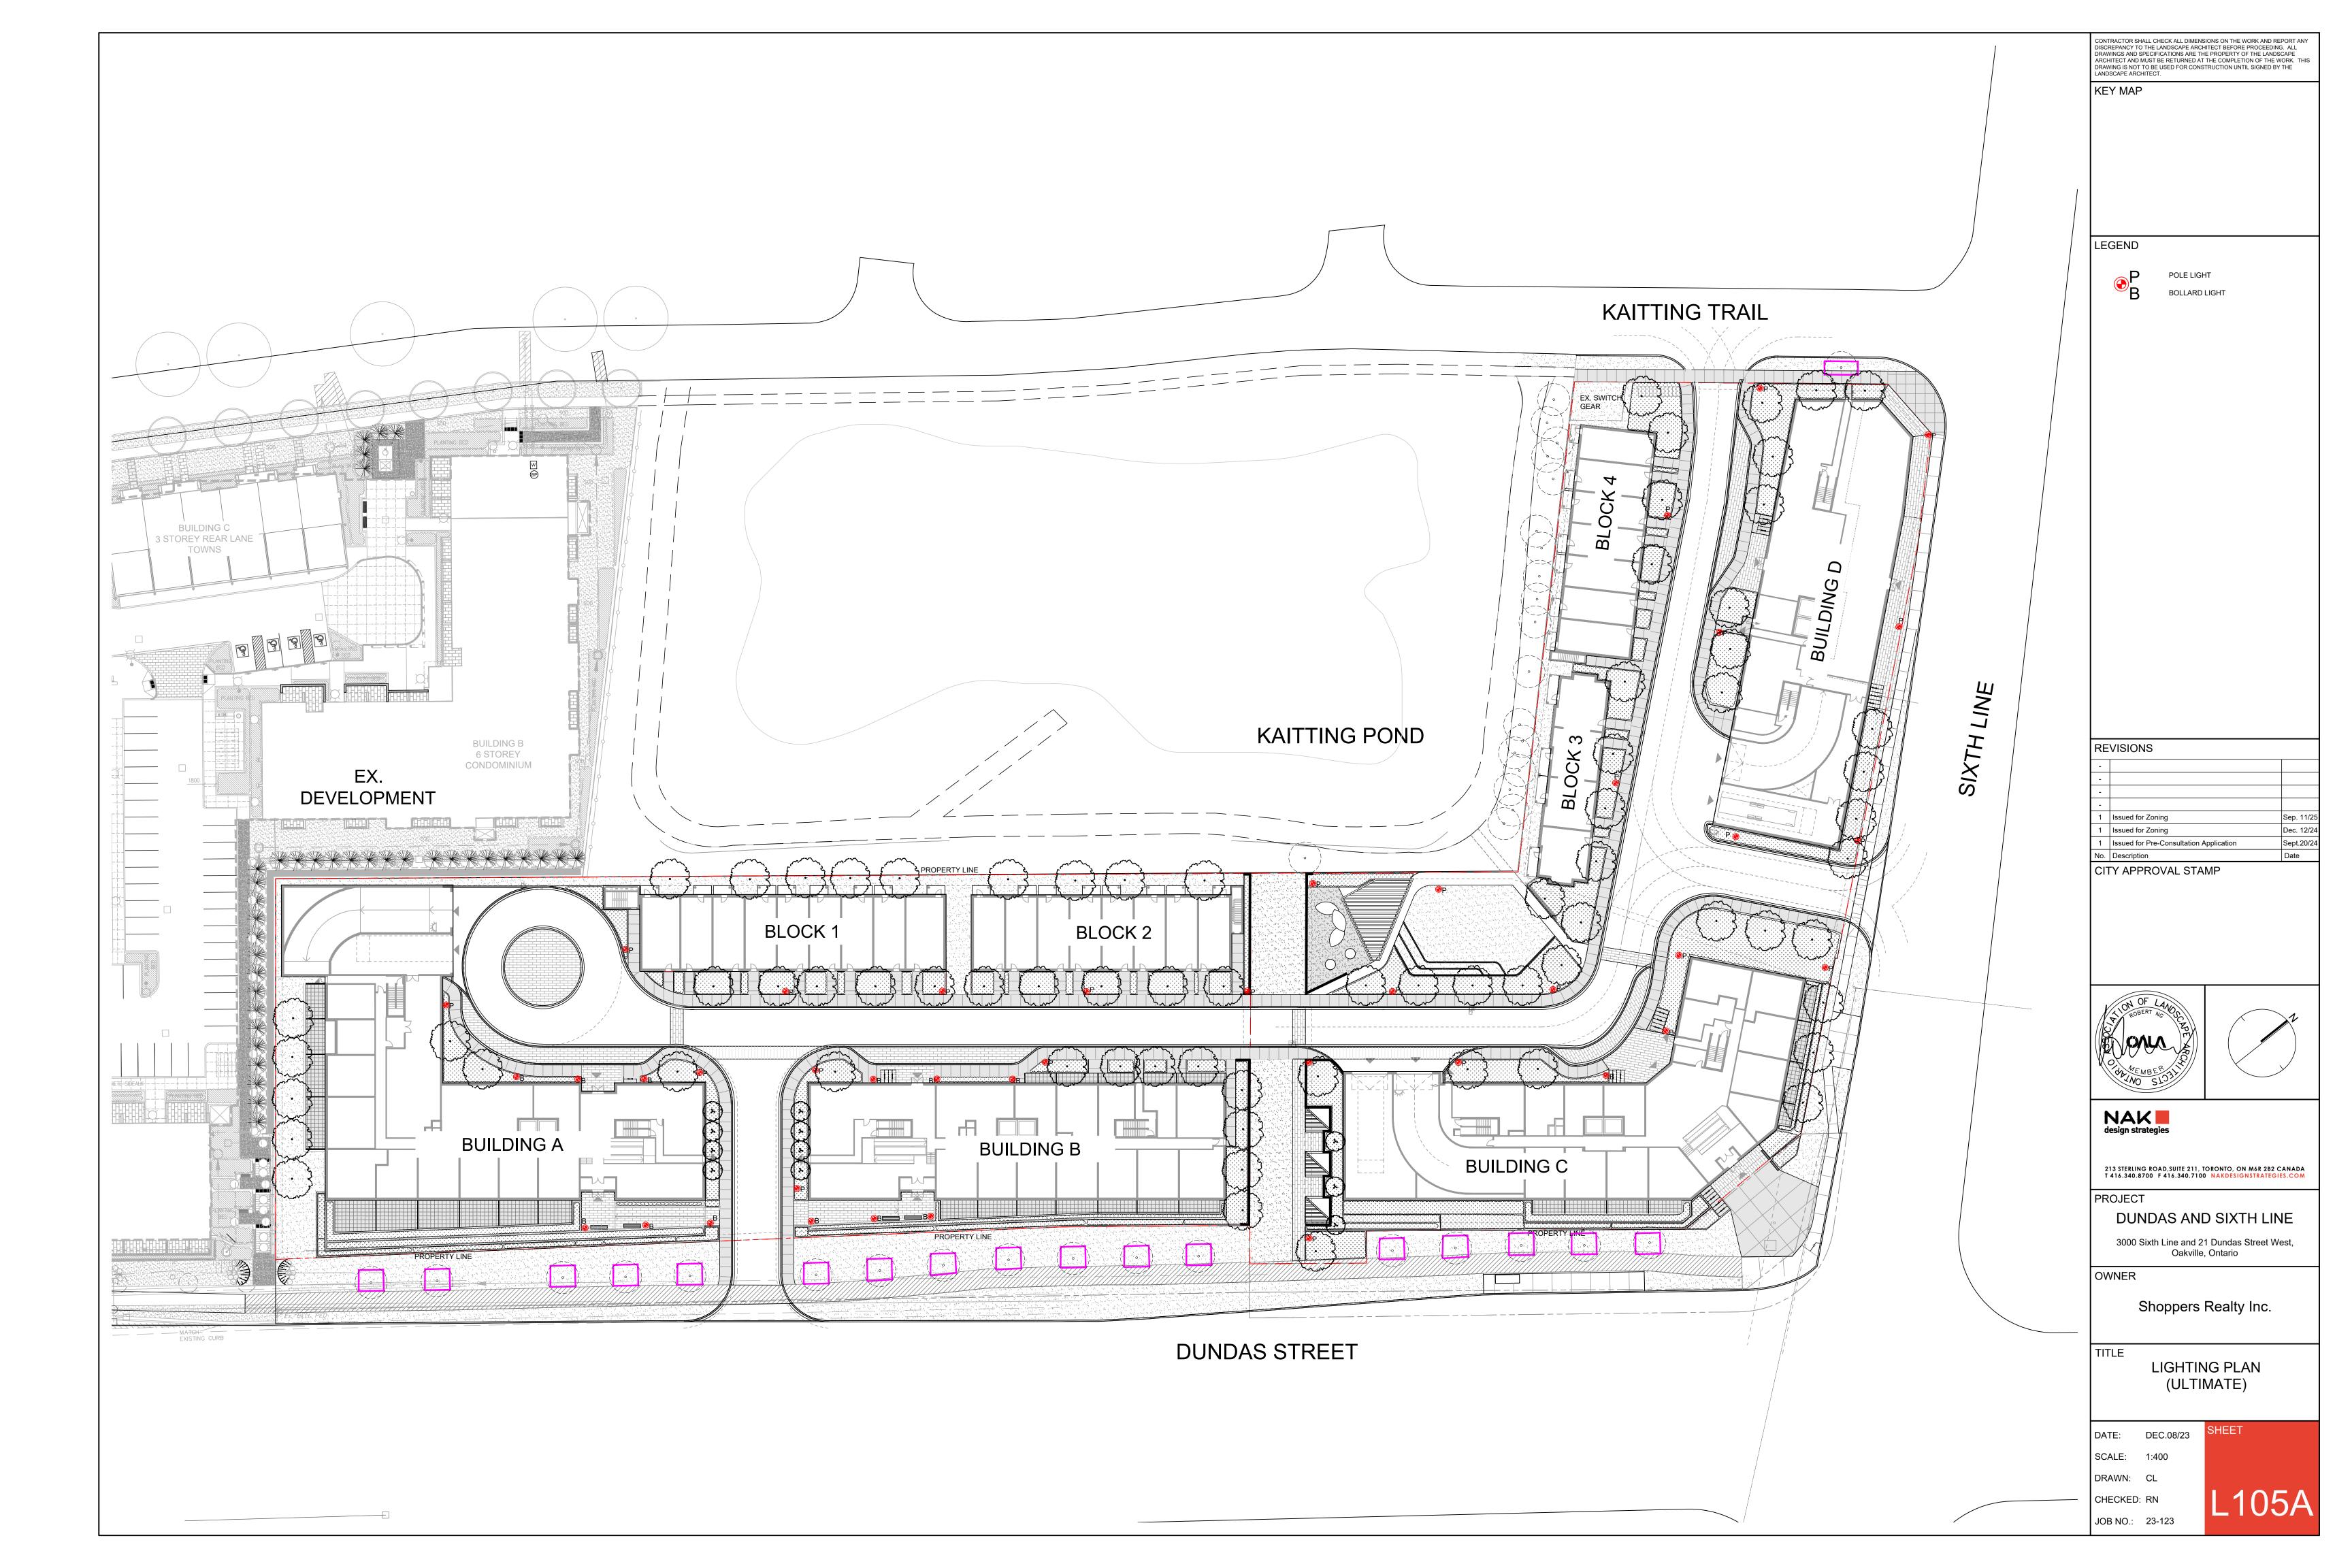

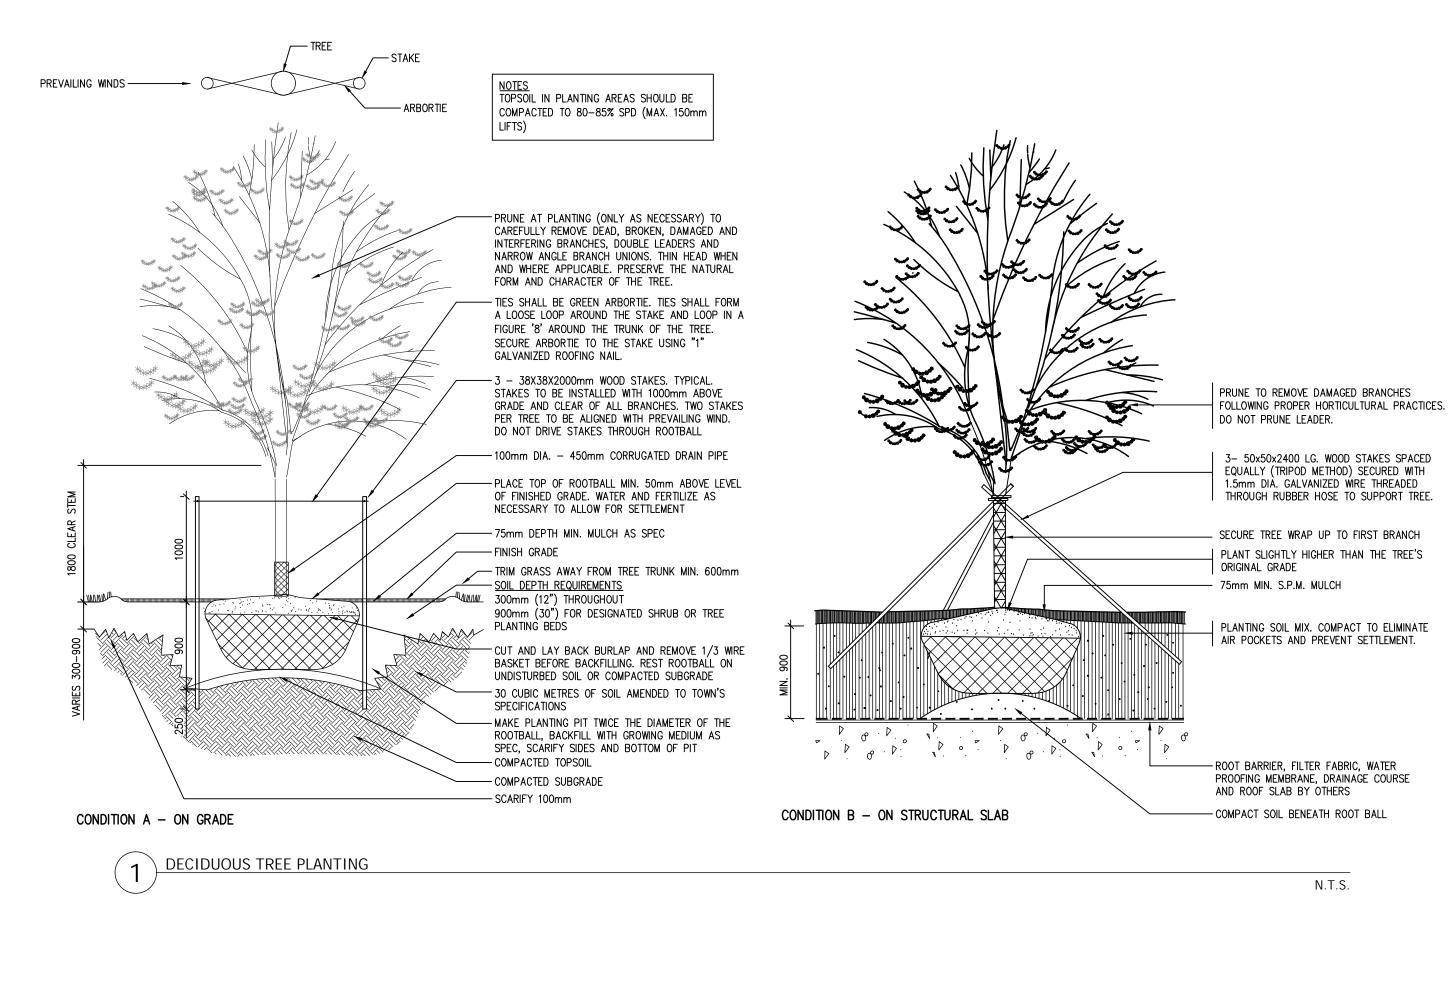

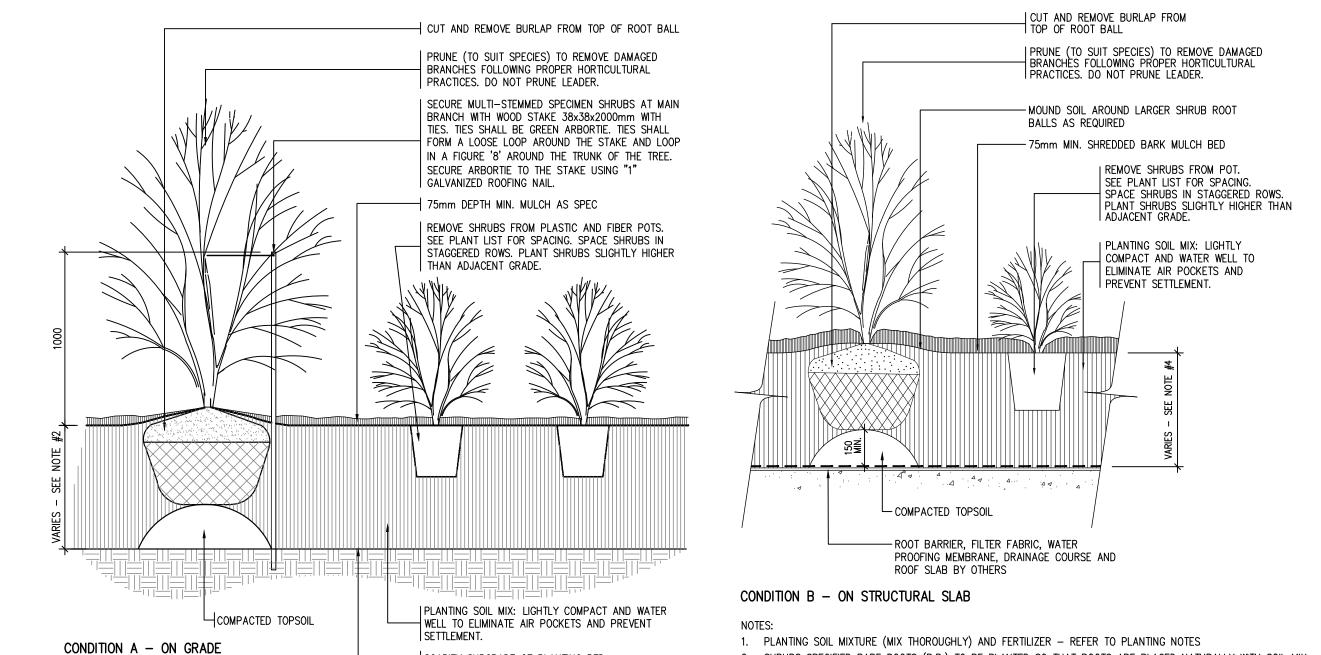

SCARIFY SUBGRADE OF PLANTING BED

- 25mm SETTING BED OF COARSE SHARP

TOPSOIL IN PLANTING AREAS SHOULD BE COMPACTED TO 80-85% SPD (MAX. 150mm LIFTS)

COLOURS TO BE DETERMINED IN CONSULTATION WITH CLIENT AND LANDSCAPE ARCHITECT.

PROVIDE ALUMINUM EDGE RESTRAINT WHEN PAVERS ARE ADJACENT TO SOFT LANDSCAPE

FOR PAVING LOCATIONS AND SPECIFICATIONS REFER TO PLANS AND DETAILS.

CONTRACTOR TO PROVIDE 1M x 1M PAVING SAMPLE. PRIOR TO ORDERING CONFIRM COLOUR.

SHURB PLANTING

DECORATIVE UNIT PAVERS BY UNILOCK OR APPROVED EQUAL.

(PLANTING BEDS OR SOD).

UNIT PAVER AS PER DRAWING ----

FILL JOINTS WITH ----

POLYMERIC JOINTING

PROVIDE 600mm DEPTH FOR LARGE MULTI-STEM SPECIMEN SHRUBS AND 450mm DEPTH FOR ALL OTHER SHRUBS.

SHRUBS SPECIFIED BARE ROOTS (B.R.) TO BE PLANTED SO THAT ROOTS ARE PLACED NATURALLY WITH SOIL MIX

N.T.S.

-FILL JOINTS WITH POLYMERIC JOINTING SAND

3. PROVIDE 150 HIGH EARTH SAUCER AROUND SHRUB BED WITH 100 WIDE SMOOTH BED EDGE TO RETAIN MULCH.


4. PROVIDE 600mm DEPTH FOR LARGE MULTISTEM SPECIMEN SHRUBS AND 450mm DEPTH FOR ALL OTHER SHRUBS.

BACKFILLED CAREFULLY TO PREVENT ROOT DAMAGE.

REMOVE PERENNIALS AND ORNAMENTAL GRASSES FROM POT (I GAL.). SEE PLANT LIST FOR SPACING. PLANT PERENNIALS WITH TOP OF ROOT BALL AT REMOVE PERENNIALS AND ORNAMENTAL GRASSES OR SLIGHTLY BELOW SOIL SURFACE. FROM POT (I GAL.). SEE PLANT LIST FOR SPACING. 75mm MIN. SHREDDED CEDAR BARK MULCH (BY PLANT PERÈNNIALS WITH TOP OF ROOT BALL AT GRO-BARK LTD. OR ALL TREAT FARMS LTD. OR OR SLIGHTLY BELOW SOIL SURFACE. APPROVED ALTERNATE.) REMOVE MULCH FROM AROUND BASE OF PERENNIAL. — 75mm MIN. SHREDDED CEDAR BARK MULCH (BY GRO-BARK LTD. OR ALL TREAT FARMS LTD. OR PLANTING SOIL MIX: LIGHTLY COMPACT AND WATER WELL TO ELIMINATE AIR POCKETS AND PREVENT APPROVED ALTERNATE.) REMOVE MULCH FROM AROUND BASE OF PERENNIAL. SETTLEMENT. - PLANTING SOIL MIX: LIGHTLY COMPACT AND WATER WELL ROOT BARRIER, FILTER FABRIC. TO ELIMINATE AIR POCKETS AND PREVENT SETTLEMENT. WATER PROOFING MEMBRANE, DRAINAGE COURSE AND ROOF — SCARIFY SUBGRADE OF PLANTING BED. SLAB BY OTHERS CONDITION B - ON STRUCTURAL SLAB CONDITION A - ON GRADE 1. PLANTING SOIL MIXTURE (MIX THOROUGHLY) 6-PARTS GOOD QUALITY TOP SOIL, 2-PARTS WELL-ROTTED COW MANURE, 1-PART PEAT MOSS.

- 2. IF PLANT IS ROOT-BOUND AFTER REMOVING FROM POT, BREAK UP ROOT BALL WITH SHARP
- KNIFE. ENSURE ROOT BALL IS MOIST BEFORE PLANTING.
- 3. WEED BARRIER BY TERRAFIX OR APPROVED EQUIVALENT. OVERLAP MAT MIN. 150mm AND CUT AS REQUIRED TO INSTALL PLANTING.

PERENNIAL PLANTING N.T.S.

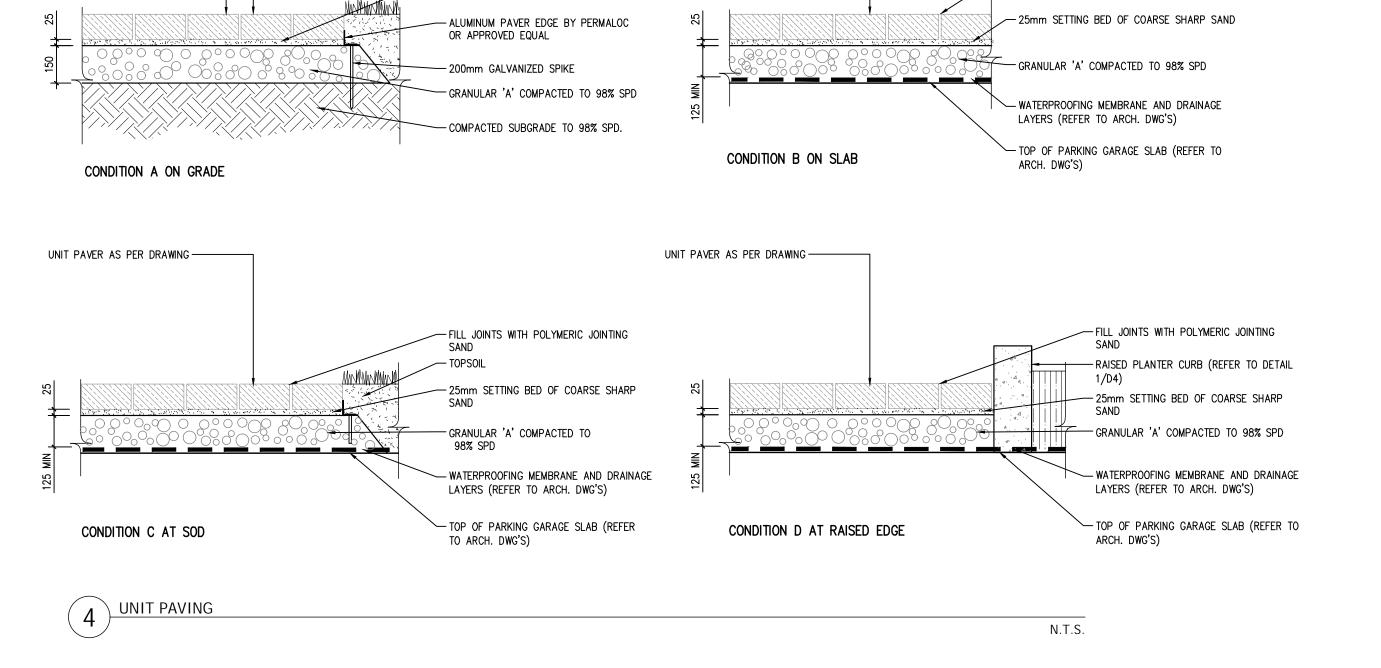

UNIT PAVER AS PER DRAWING ----

ONTRACTOR SHALL CHECK ALL DIMENSIONS ON THE WORK AND REPORT ANY ISCREPANCY TO THE LANDSCAPE ARCHITECT BEFORE PROCEEDING. ALL DRAWINGS AND SPECIFICATIONS ARE THE PROPERTY OF THE LANDSCAPE ARCHITECT AND MUST BE RETURNED AT THE COMPLETION OF THE WORK. THIS DRAWING IS NOT TO BE USED FOR CONSTRUCTION UNTIL SIGNED BY THE LANDSCAPE ARCHITECT.

KEY MAP

LEGEND

REVISIONS


Sept.20/24

CITY APPROVAL STAMP

Issued for Pre-Consultation Application

Issued for Zoning

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NAK design strategies

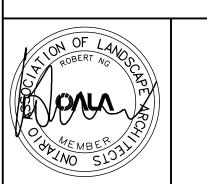213 STERLING ROAD, SUITE 211, TORONTO, ON M6R 2B2 CANADA

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DUNDAS AND SIXTH LINE 3000 Sixth Line and 21 Dundas Street West,

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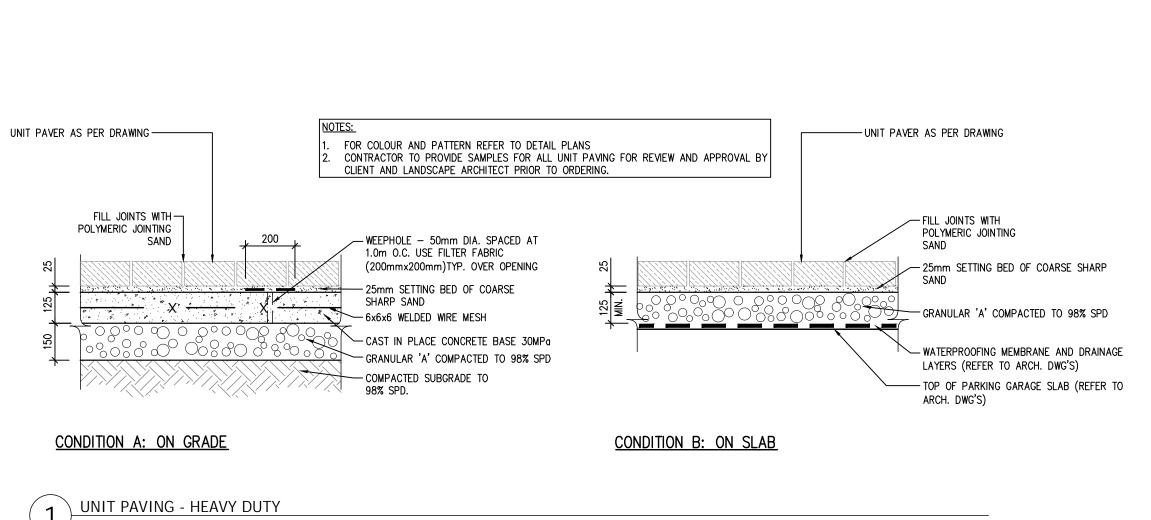
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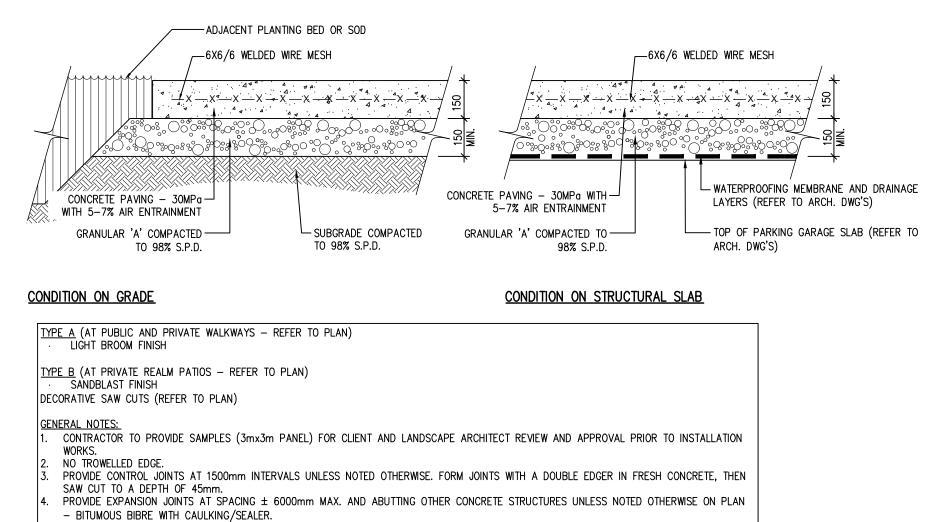
LANDSCAPE **DETAILS**

DATE: DEC.08/23 SCALE: AS SHOWN

DRAWN: CL CHECKED: RN


JOB NO.: 23-123






N.T.S.

CURING MEMBRANE (WHITE PIGMENT) TO BE APPLIED AT THE RATE OF 4 sq.m/L.

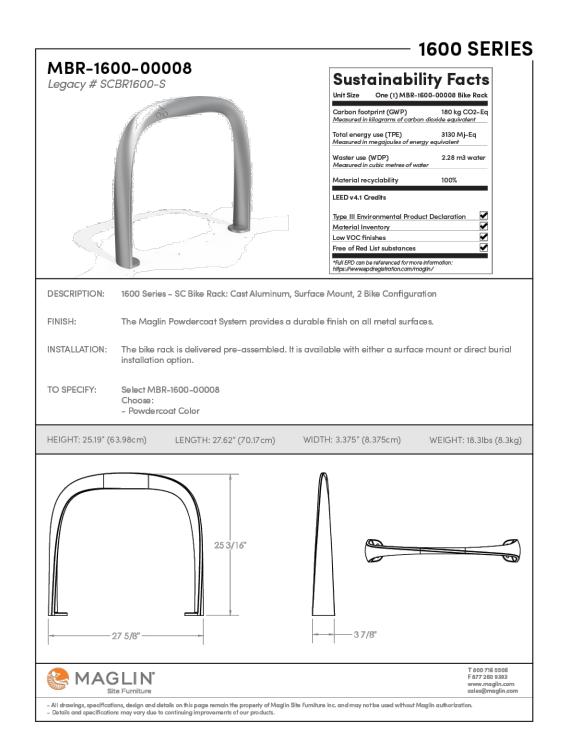

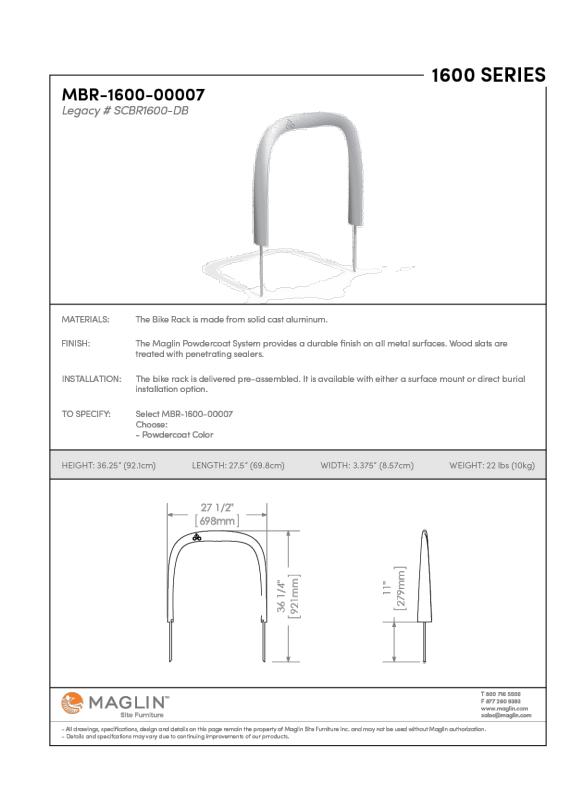

N.T.S.

3 BIKE RACK N.T.S.

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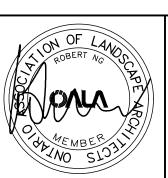
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