

Contractor shall check all dimensions on the work and report any discrepancy to the Landscape Architect before proceeding. All drawings and specifications are the property of the Landscape Architect and must be returned at the completion of the work. This drawing is not to be used for construction until signed by the Landscape Architect.

PROPERTY LINE
LIMIT OF STRUCTURAL SLAB
PHASING LINE
EXTENT OF SOIL CELLS
EXISITING CHAINLINK FENCE
PATIO RAILING BY OTHERS
CANOPY ABOVE
SCREEN BY OTHERS
SURFACING
SOD

UNIT PAVING TYPE B

CONCRETE PAVING

HEAVY DUTY CONCRETE PAVING

CONCRETE PAVING —PRIVATE PATIOS SANDBLAST FINISH WITH DEC. SAWCUTS

DETAIL KEY

UNIT PAVING TYPE A

DETAIL NO.
SHEET NO.

GENERAL NOTES

1) FOR ALL SITE GRADING REFER TO CIVIL DRAWINGS
2) FOR SITE LIGHTING REFER TO LIGHTING CONSULTANT'S DRAWINGS
3) ALL EXTERIOR LIGHTING DEVICES SHALL BE FULL
COLOR TO DIRECT HAMINATION DOWNWARD DARK

CUT-OFF TO DIRECT ILLUMINATION DOWNWARD, DARK SKY COMPLIANT TO REDUCE LIGHT POLLUTION AND SKYGLARE, AND SHALL BE MITIGATED AT THE SOURCE SO THAT NO LIGHT (0.0 FC) WILL BE DIRECTLY PROJECTED ONTO ADJACENT PROPERTIES.


City Approval Stamp

MUNICIPAL
Approved in principle subject to detail construction conforming to town of Oakville standards and specifications

MANAGER OF DEVELOPMENT & ENVIRONMENTAL ENGINEERING

DIRECTOR OF PARKS AND OPEN SPACE



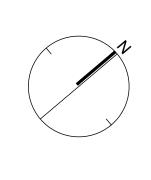



421 RONCESVALLES AVENUE, TORONTO, ON M6R 2N1 CANADA T 416.340.8700 F 416.340.7100 NAKDESIGNSTRATEGIES.COM

Project

MARTILLAC DUC BLOCK B 1359 Dundas St W

CITY FILE N

Drawn jg


Checked tfg
Job No. 22-048

LAYOUT & SURFACE TREATMENT PLAN

 Date
 April 7 2022
 Shed

 Scale
 1:300

L1.0

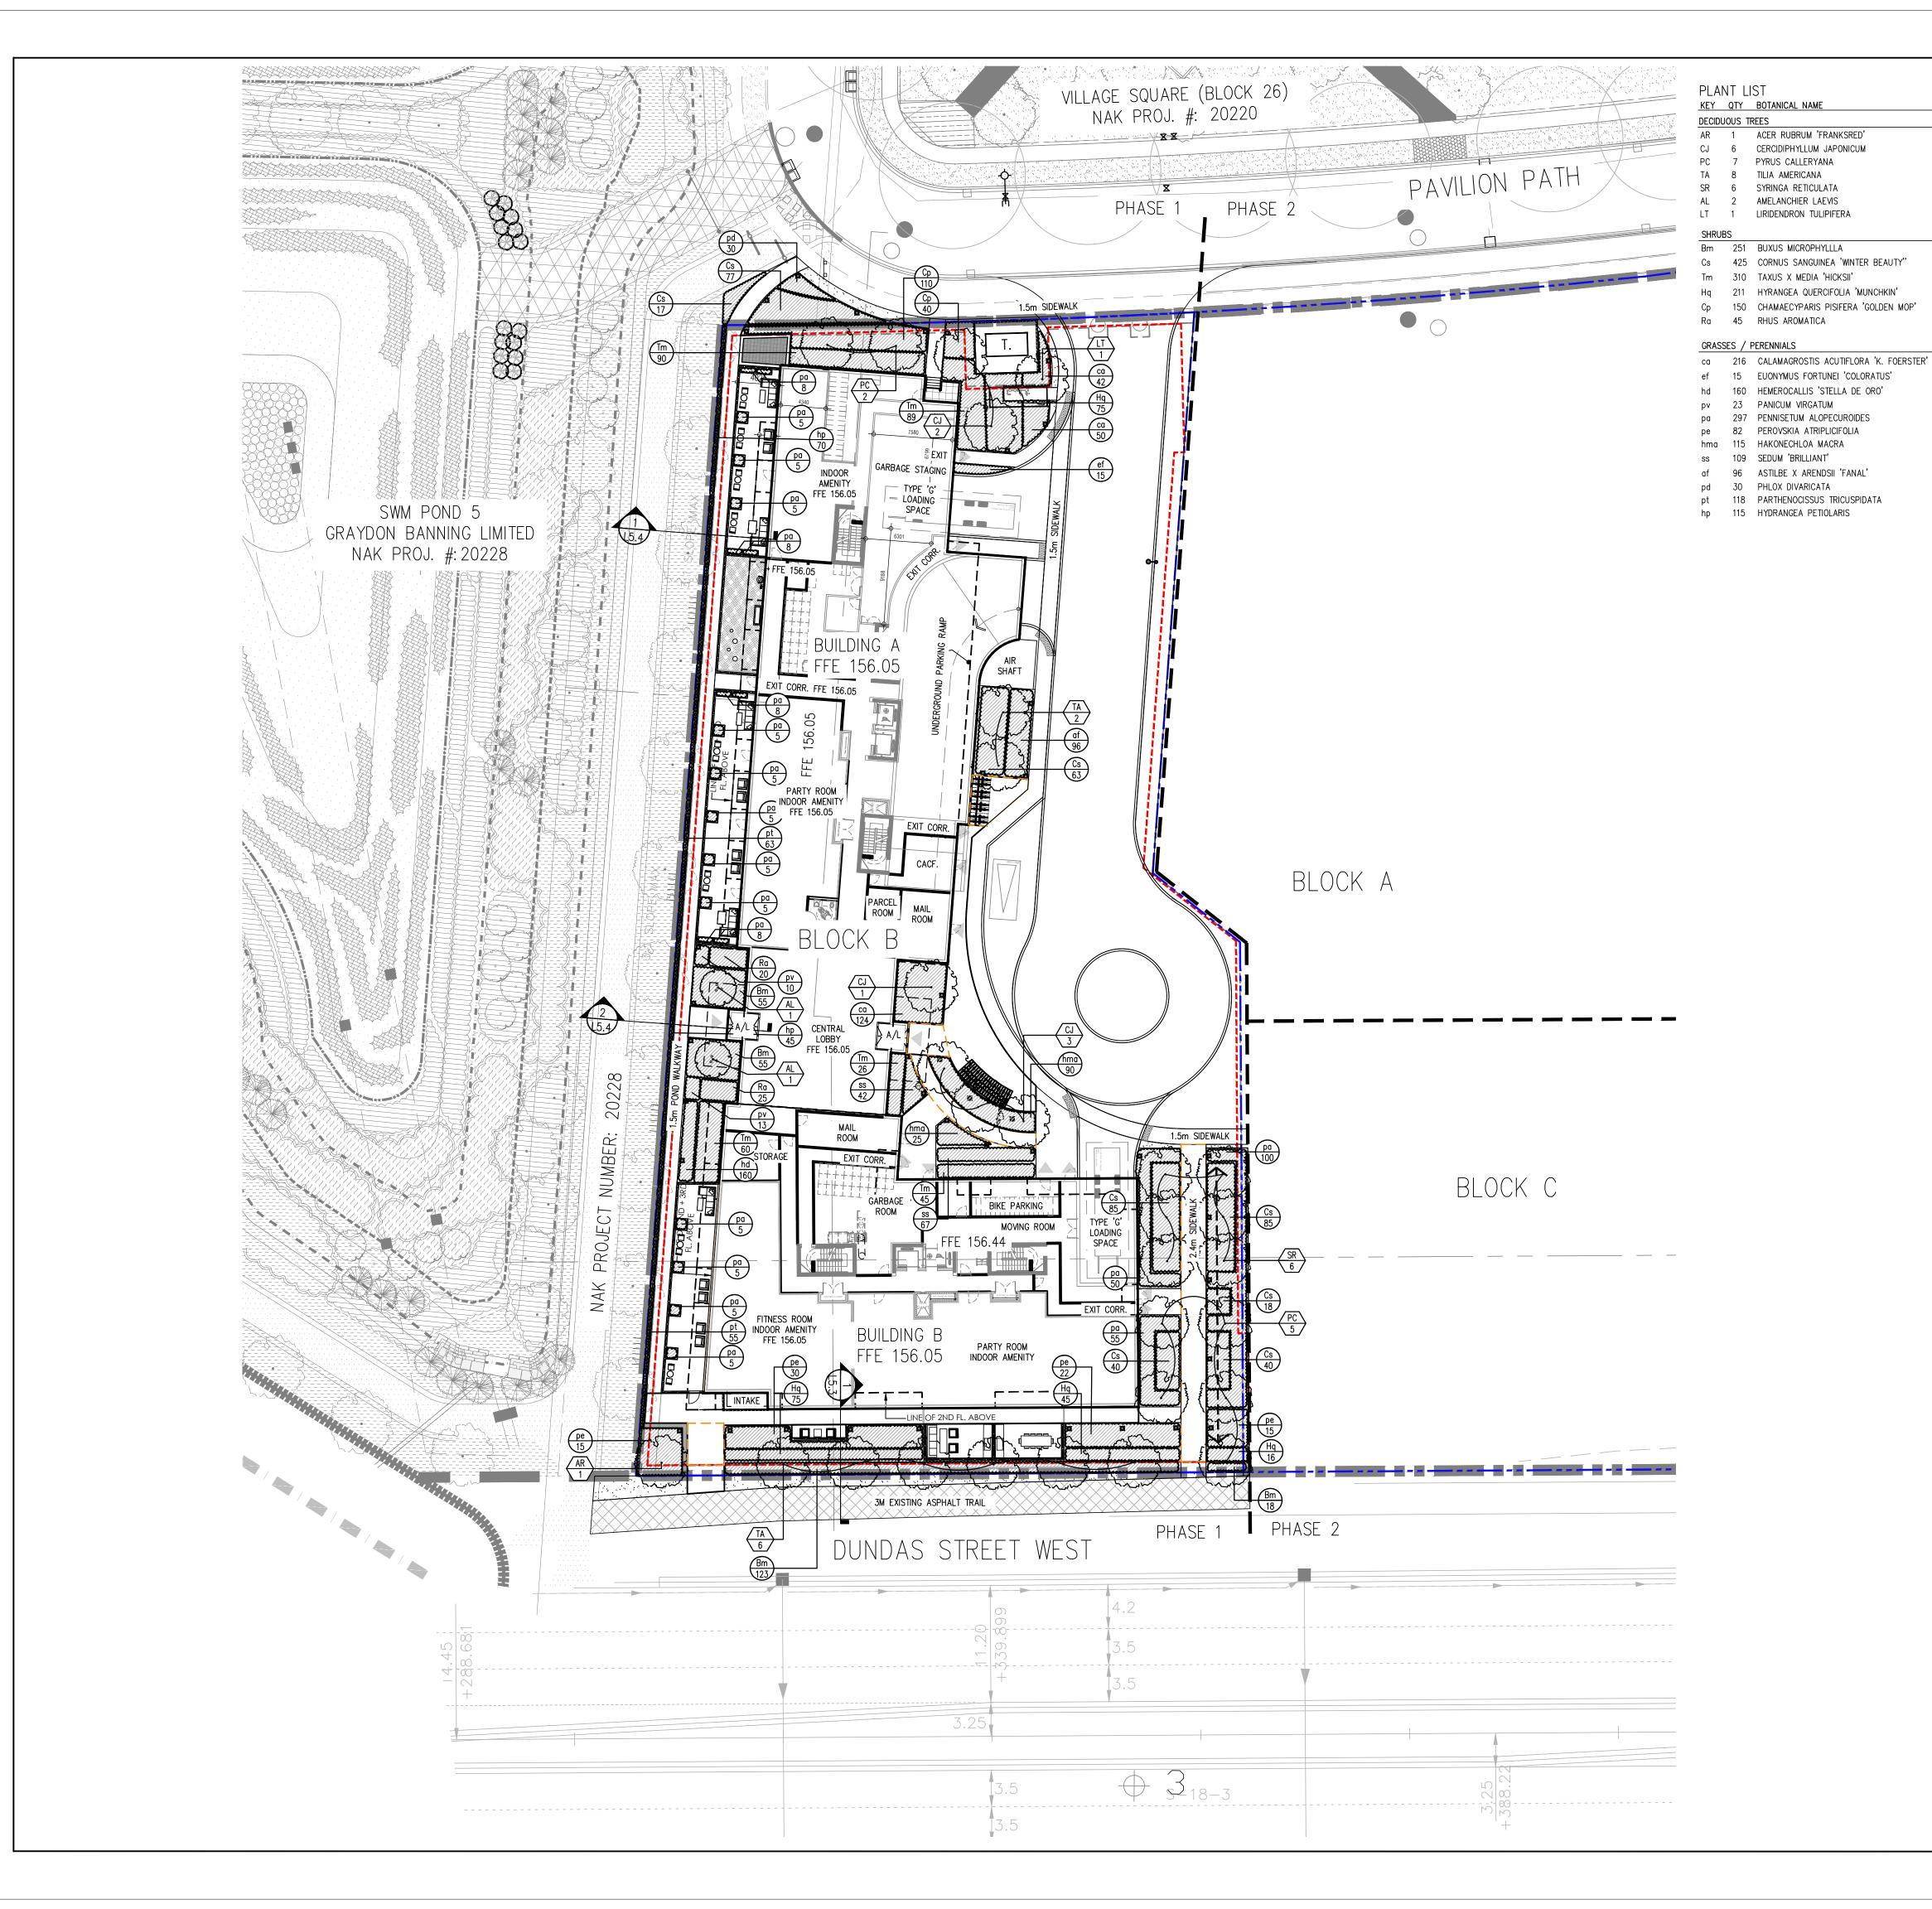

Contractor shall check all dimensions on the work and report any discrepancy to the Landscape Architect before proceeding. All drawings and specifications are the property of the Landscape Architect and must be returned at the completion of the work. This drawing is not to be used for construction until signed by the Landscape Architect.

(cm)

AS SHOWN

60cm

60cm

60cm

60cm

90cm

30cm

60cm

90cm

120cm

60cm

50cm

50cm 30cm

50cm

50cm

HEIGHT CALIPER CONDITION

60

60

W.B

W.B.

W.B

W.B

3 GAL. POTTED

3 GAL. POTTED

3 GAL. POTTED

2 GAL. POTTED

3 GAL. POTTED

3 GAL. POTTED

3 GAL. POTTED

1 GAL. POTTED

1 GAL. POTTED

3 GAL. POTTED

2 GAL. POTTED

3 GAL. POTTED

2 GAL. POTTED

2 GAL. POTTED

3 GAL. POTTED

1 GAL. POTTED

1 GAL. POTTED

1 GAL. POTTED

M.S B.B

(cm) (mm)

60 cm

60 cm

60 cm

60 cm

90cm

60cm

COMMON NAME

KATSURA TREE

CALLERY PEAR

TULIP TREE

RED SUNSET MAPLE

AMERICAN BASSWOOD

ALLEGHENY SERVICEBERRY

LITTLE LEAF BOXWOOD

OAKLEAF HYDRANGEA

FRAGRANT SUMAC

WINTER BEAUTY DOGWOOD

PURPLELEAF WINTER CREEPER

STELLA D'ORO DAYLILY

SWITCH GRASS

FOUNTAIN GRASS

RUSSIAN SAGE

HAKONE GRASS

FANAL ASTILBE

BOSTON IVY

WOODLAND PHLOX

BRILLIANT STONECROP


CLIMBING HYDRANGEA

GOLDEN MOP THREADLEAF FALSECYPRESS 60 cm

KARL FOERSTER FEATHER REED GRASS 90cm


IVORY SILK LILAC

HICK'S YEW

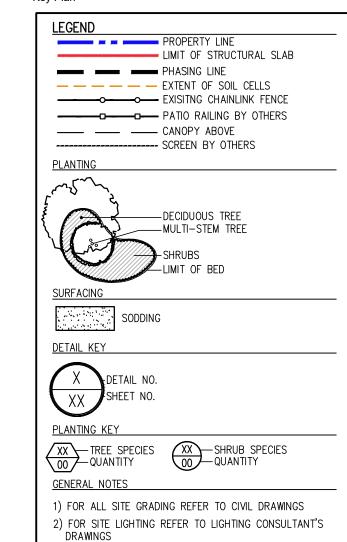

3) ALL LIGHTING DEVICES SHALL BE FULL CUT OFF AND NIGHT SKY FRIENDLY, AND SHALL BE MIGRATED AT THE SOURCE SO THAT NO LIGHT (0.0 FC) WILL BE DIRECTLY

PROJECTED ONTO ADJACENT PROPERTIES.

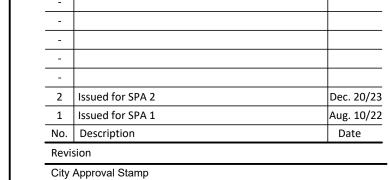


MUNICIPAL

Approved in principle subject to detail construction conforming to town of Oakville standards and specifications

MANAGER OF DEVELOPMENT & ENVIRONMENTAL ENGINEERING

DIRECTOR OF PARKS AND OPEN SPACE



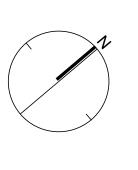




421 RONCESVALLES AVENUE, TORONTO, ON M6R 2N1 CANADA T 416.340.8700 F 416.340.7100 NAKDESIGNSTRATEGIES.COM

MARTILLAC DUC **BLOCK B** 1359 Dundas St W

PLANTING PLAN

1:300 Drawn Checked tfg Job No. 22-048

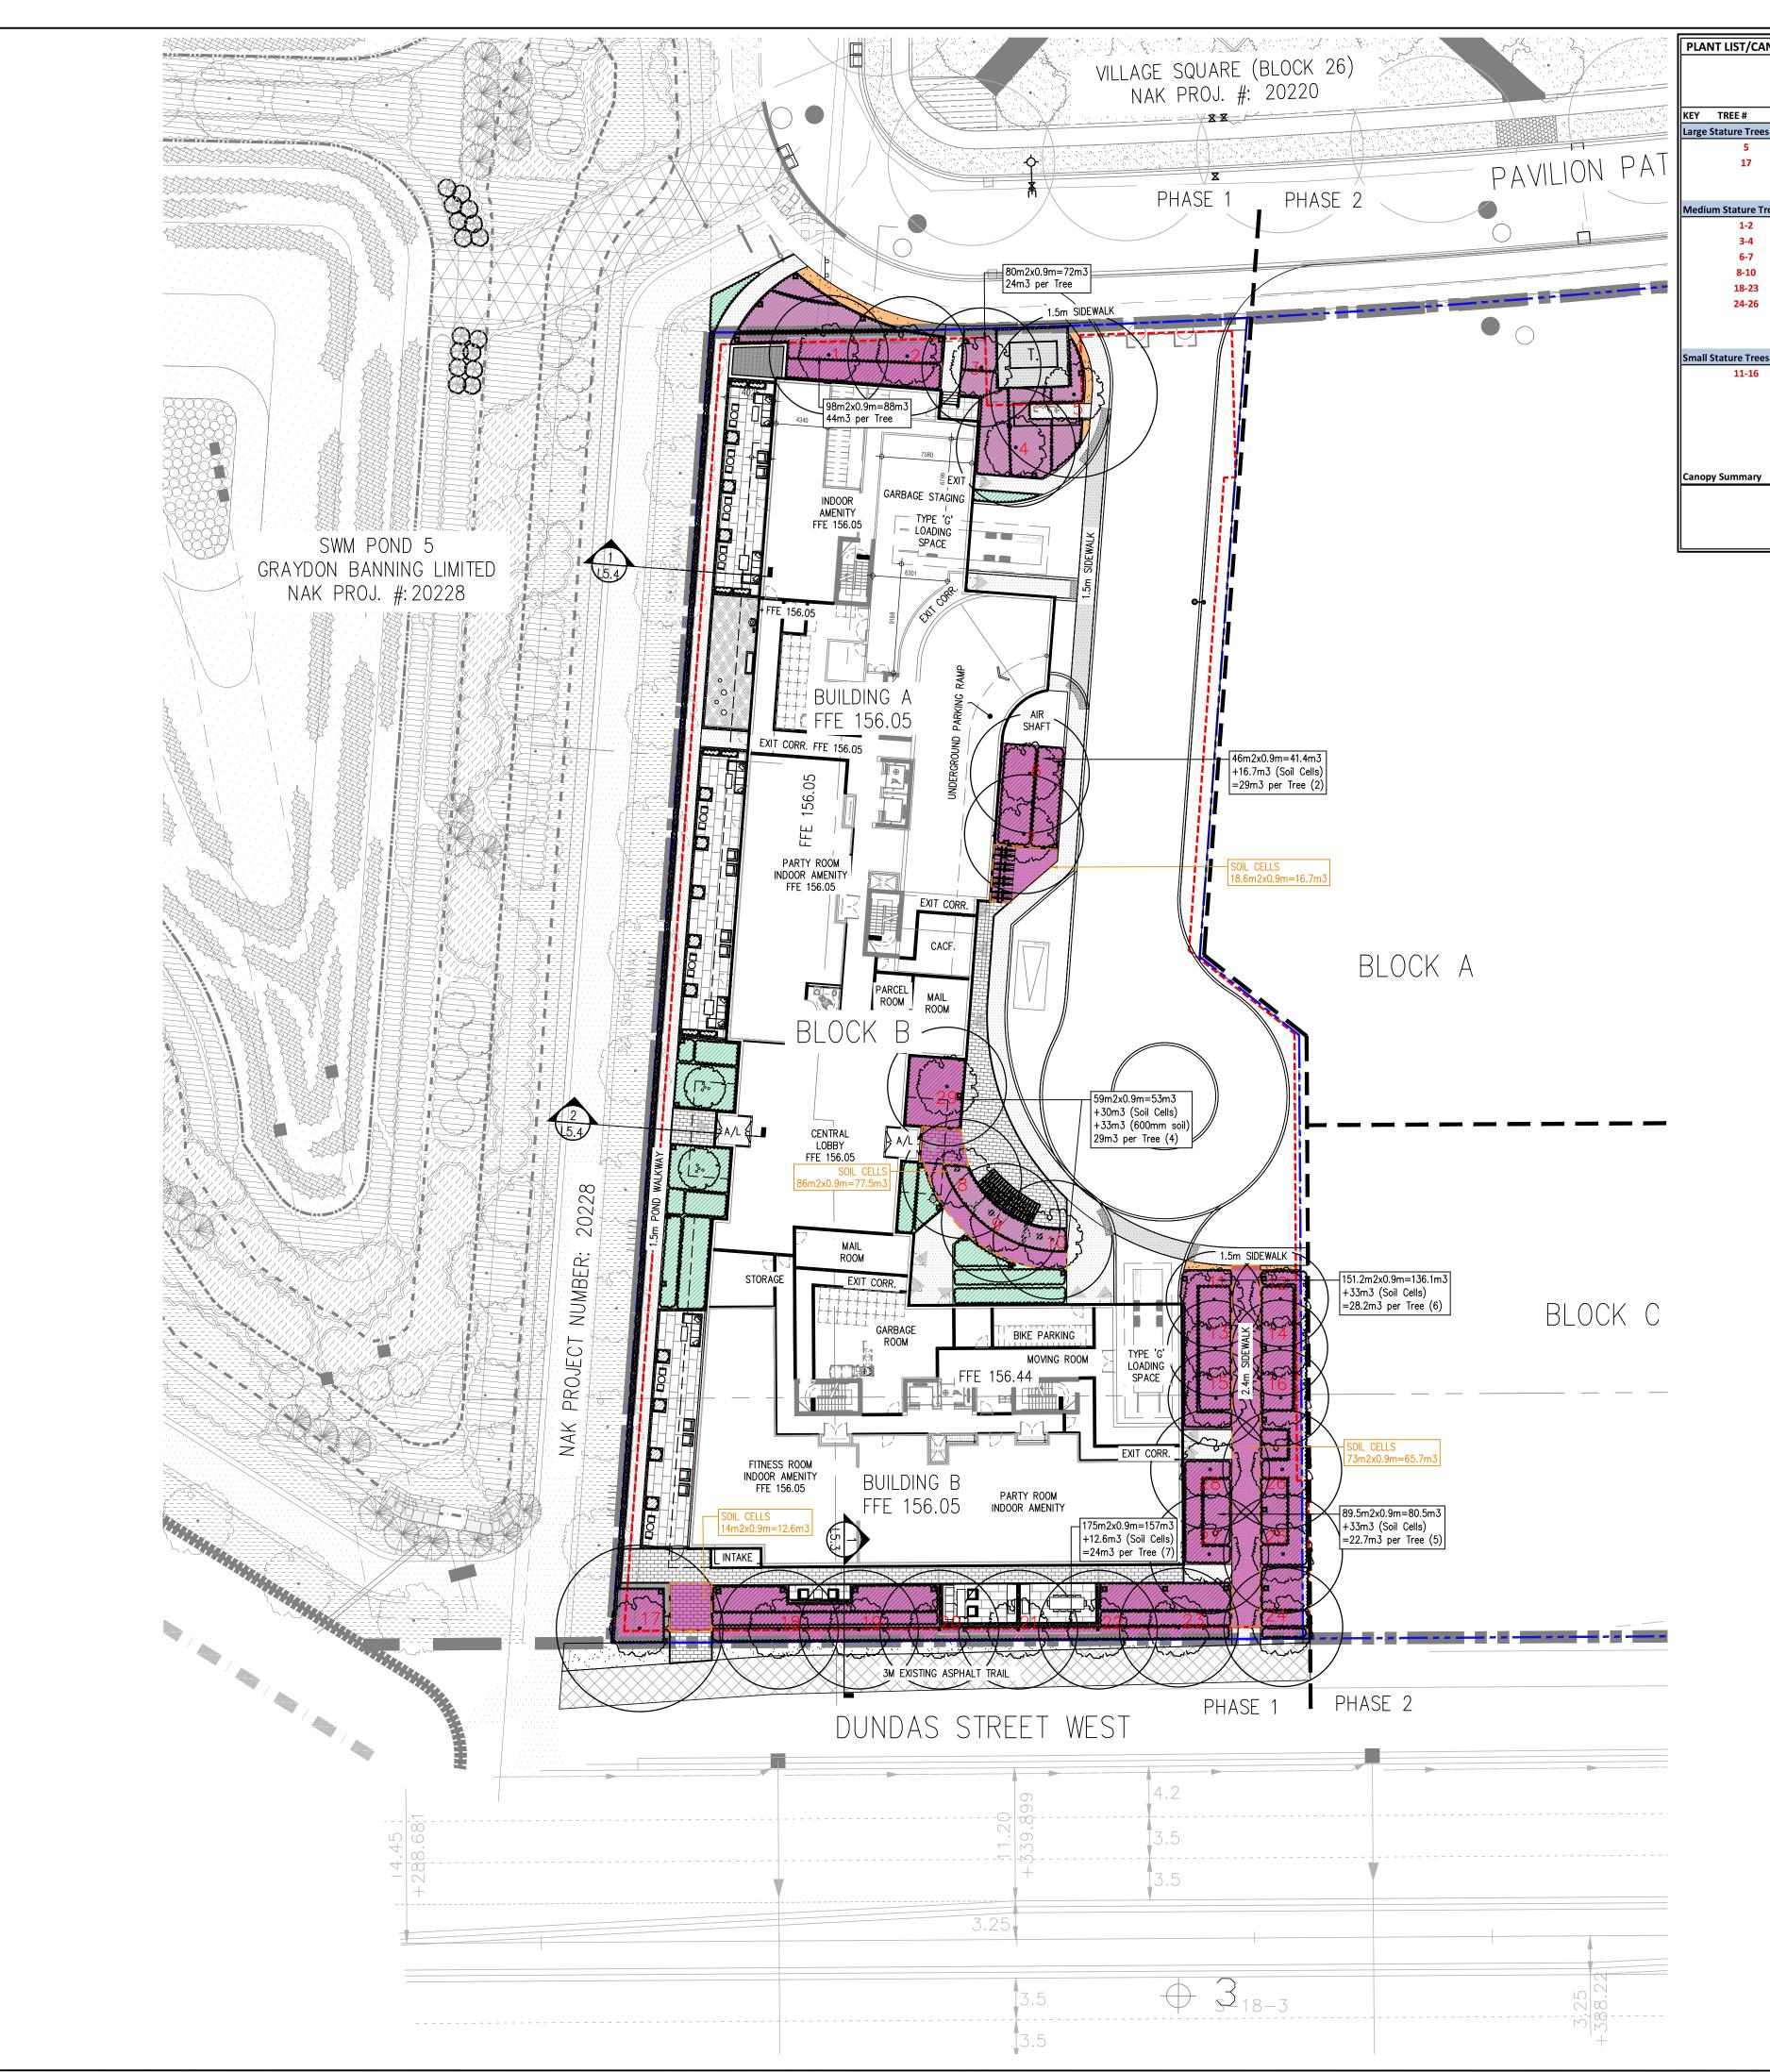

PLANT LIST/CANOPY CALCULATION CHART (22-048) Soil Volume Crown Canopy Volume (m3) per Area per Area Sub- % of Total KEY TREE # Botanical Name Qty (m3) tree tree (m2) total (m2) Canopy Area Common Name Size/Remarks Large Stature Trees (14+ m spread) LIRIDENDRON TULIPIFERA TULIP TREE 60mm cal., W.B. ACER RUBRUM 'FRANKSRED' **RED SUNSET MAPLE** 60mm cal., W.B. **20.0** 20.0 154.0 64 5.7% 14.2% 22.0 154.0 160 Medium Stature Trees (10-13m spread) **PYRUS CALLERYANA CALLERY PEAR** 60mm cal., W.B. CERCIDIPHYLLUM JAPONICUM **KATSURA TREE** 60mm cal., W.B. 110 9.8% TILIA CORDATA LITTLE LEAF LINDEN 111 9.8% CERCIDIPHYLLUM JAPONICUM KATSURA TREE 170 15.1% TILIA CORDATA LITTLE LEAF LINDEN 60mm cal., W.B. **6 120.0** 20.0 50.0 202 17.9% **PYRUS CALLERYANA CALLERY PEAR** 60mm cal., W.B. **3 60.0** 20.0 78.5 144 12.8% **18 488.2** 27.1 78.5 812 72.0% Small Stature Trees (3-9m spread) 11-16 SYRINGA RETICULATA IVORY SILK LILAC 60mm cal., W.B. **6 150.0** 25.0 50.0 156 13.8% **150.0** 25.0 50.0 156 13.8% **CANOPY SUMMARY** TOTAL 26 682.2 26.2385 1,128 OVERLAP AREA (m2) 1,128 TOTAL CANOPY m2 (excl. overlap) 5,573

Site Canopy Cover

Land use Canopy Cover Target


Contractor shall check all dimensions on the work and report any discrepancy to the Landscape Architect before proceeding. All drawings and specifications are the property of the Landscape Architect and must be returned at the completion of the work. This drawing is not to be used for construction until signed by the


Key Pla

<u>20.2%</u>

20%

Landscape Architect.

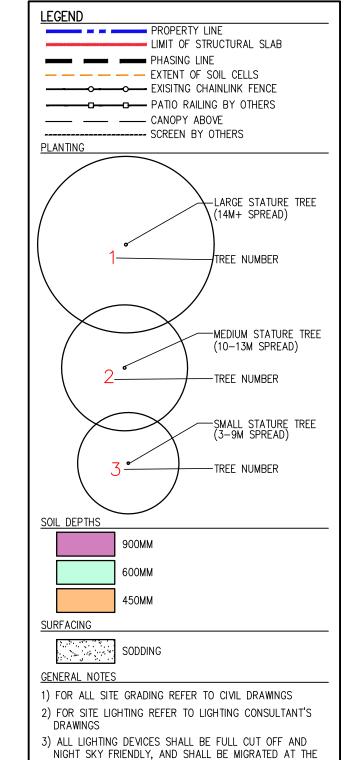

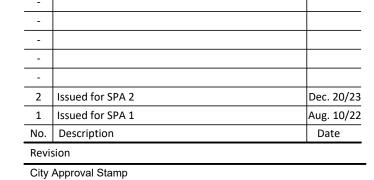

SOURCE SO THAT NO LIGHT (0.0 FC) WILL BE DIRECTLY


PROJECTED ONTO ADJACENT PROPERTIES.


City Approval Stan

MUNICIPAL
Approved in principle subject to detail construction conforming to

town of Oakville standards and specifications

MANAGER OF DEVELOPMENT & ENVIRONMENTAL ENGINEERING

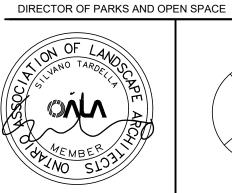

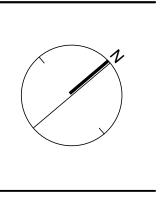



421 RONCESVALLES AVENUE, TORONTO, ON M6R 2N1 CANADA T 416.340.8700 F 416.340.7100 NAKDESIGNSTRATEGIES.COM

Project

MARTILLAC DUC BLOCK B 1359 Dundas St W


CITY FILE NO.

Job No. 22-048

TREE CANOPY COVERAGE PLAN


Date	April 7 2022	SI
Scale	1:300	
Drawn	jg	
Checked	tfg	


L1.2

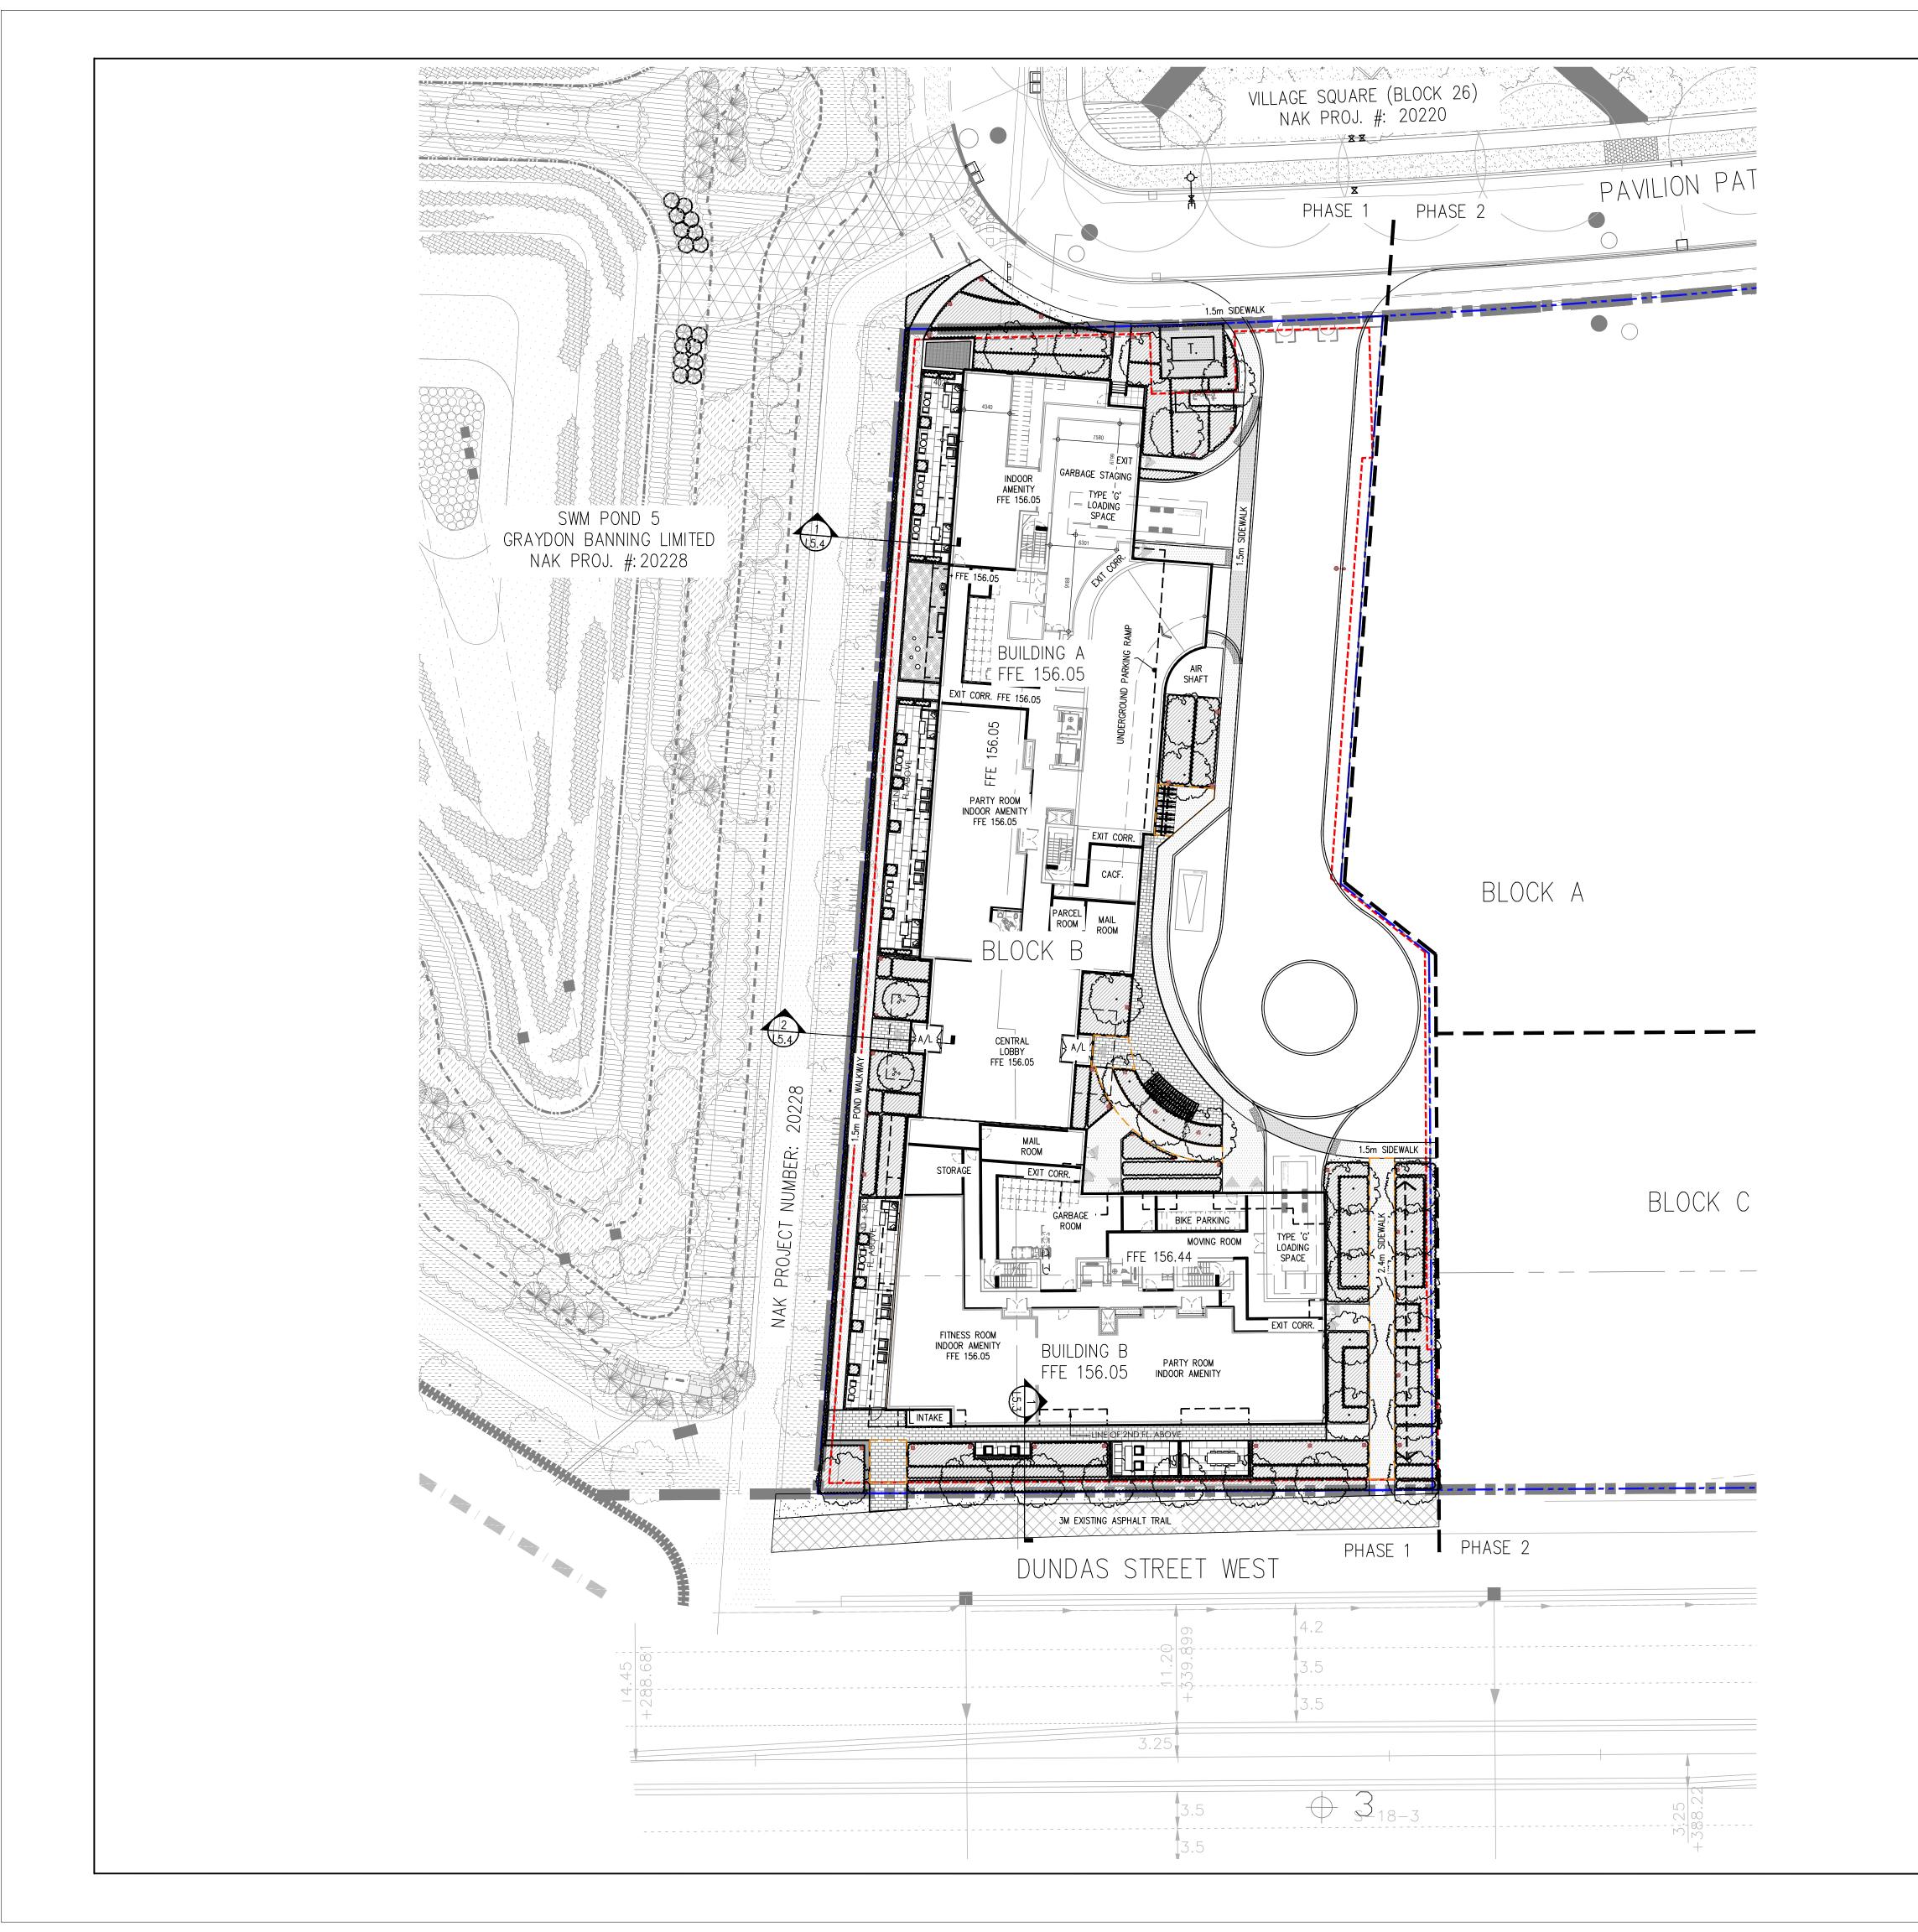

Contractor shall check all dimensions on the work and report any discrepancy to the Landscape Architect before proceeding. All drawings and specifications are the property of the Landscape Architect and must be returned at the completion of the work. This drawing is not to be used for construction until signed by the Landscape Architect.

Key Plan

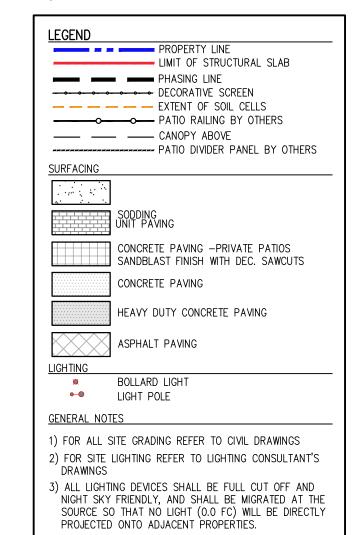

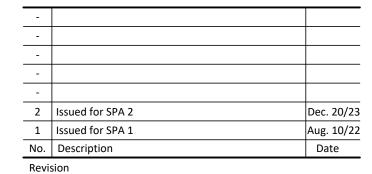

City Approval Stamp


MUNICIPAL

Approved in principle subject to detail construction conforming to town of Oakville standards and specifications

MANAGER OF DEVELOPMENT & ENVIRONMENTAL ENGINEERING

DIRECTOR OF PARKS AND OPEN SPACE



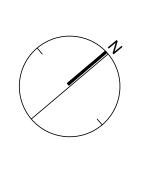



421 RONCESVALLES AVENUE, TORONTO, ON M6R 2N1 CANADA T 416.340.8700 F 416.340.7100 NAKDESIGNSTRATEGIES.COM

Project


MARTILLAC DUC BLOCK B 1359 Dundas St W

CITY FILE NO.

LIGHTING PLAN

Date April 7 20
Scale 1:300
Drawn jg
Checked tfg
Job No. 22-048


L1.3

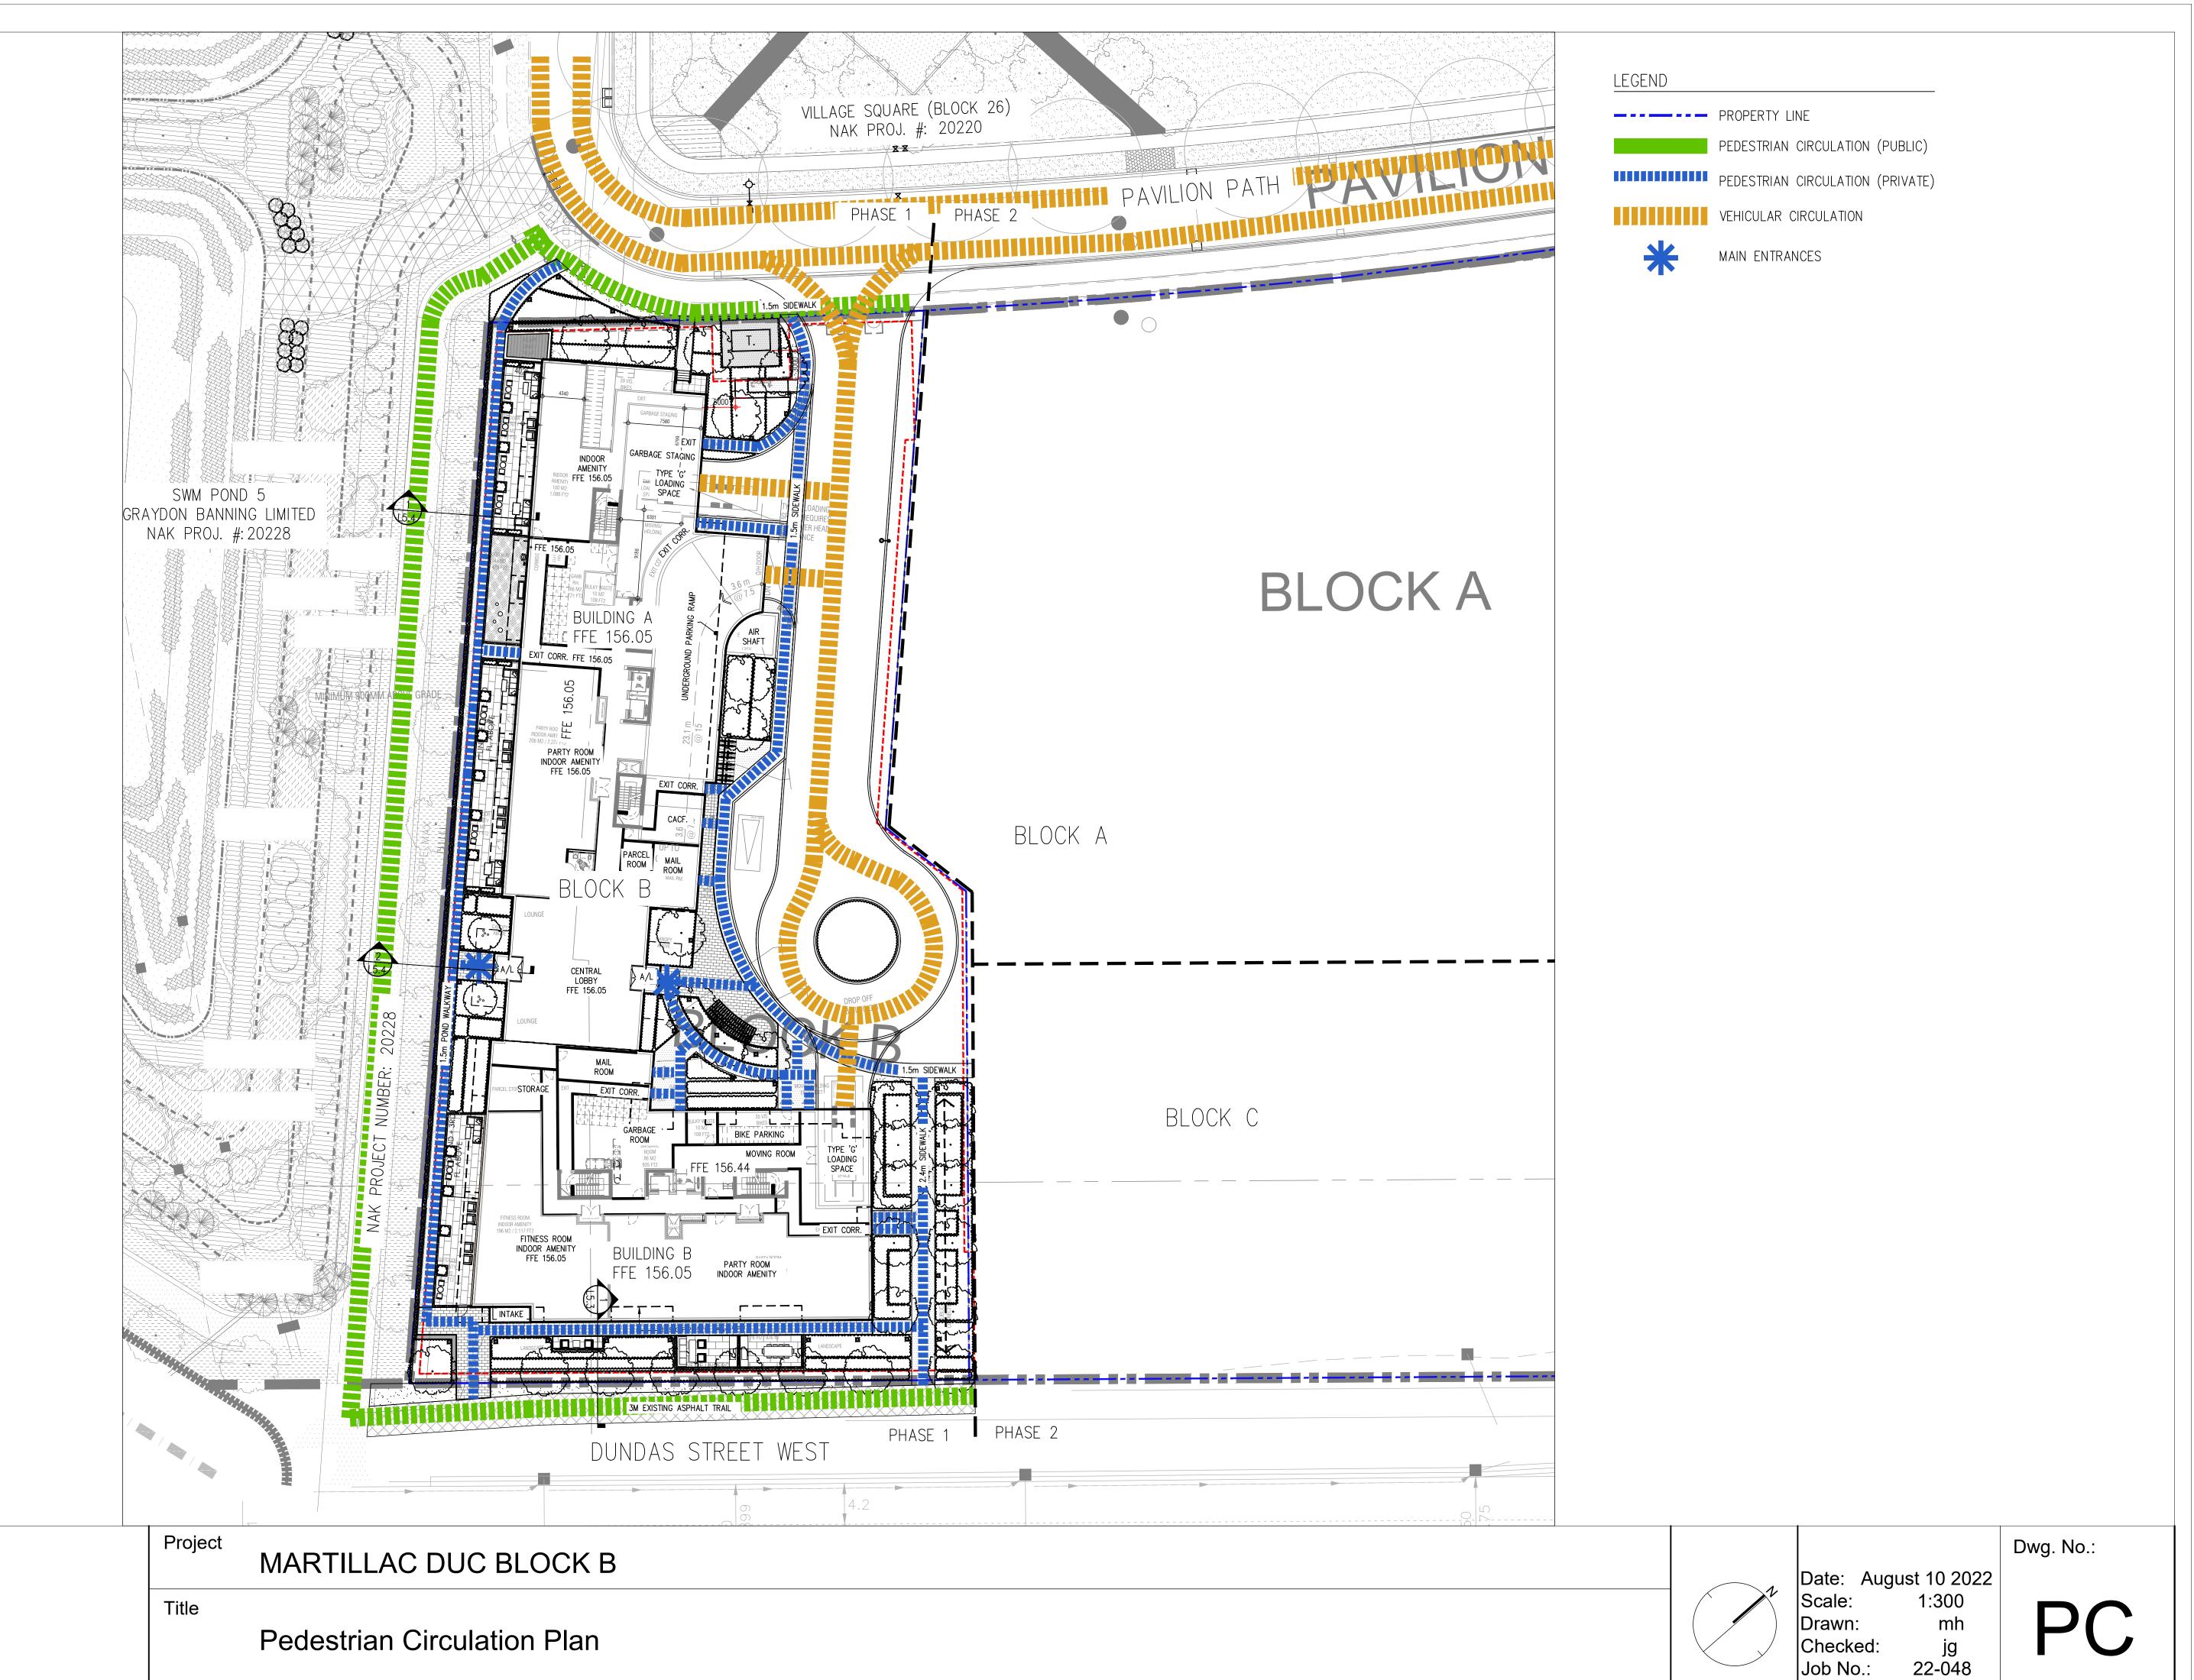

421 RONCESVALLES AVENUE, TORONTO, ON M6R 2N1 CANADA T 416.340.8700 F 416.340.7100 NAKDESIGNSTRATEGIES.COM

NAK

design strategies

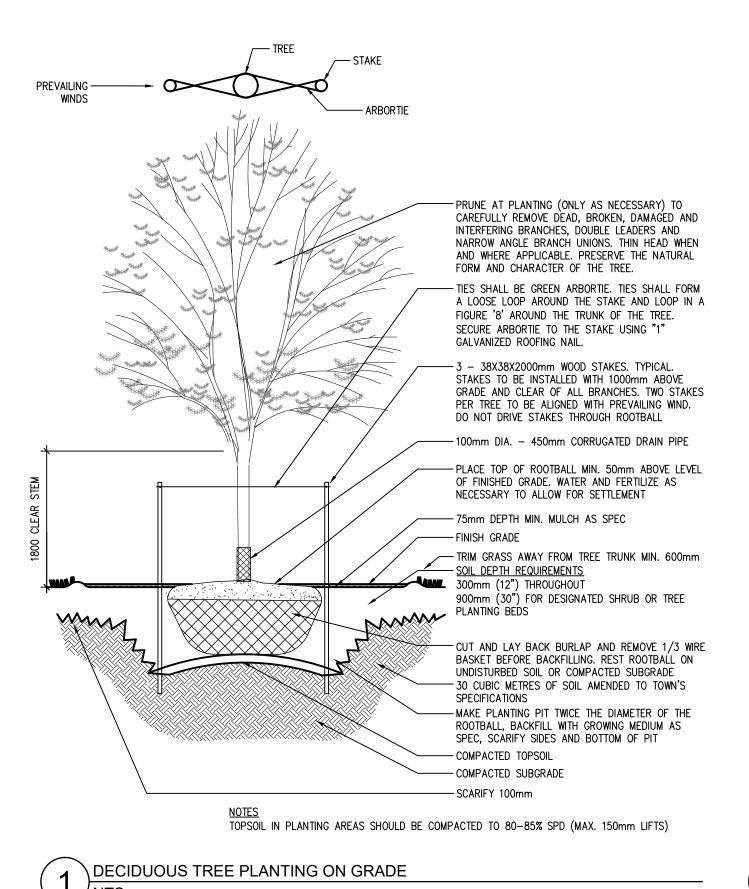


PRUNE TO REMOVE DAMAGED BRANCHES FOLLOWING PROPER HORTICULTURAL PRACTICES. DO NOT PRUNE LEADER. 3- 50x50x2400 LG. WOOD STAKES SPACED EQUALLY (TRIPOD METHOD) SECURED WITH 1.5mm DIA. GALVANIZED WIRE THREADED THROUGH RUBBER HOSE TO SUPPORT TREE. SECURE TREE WRAP UP TO FIRST BRANCH PLANT SLIGHTLY HIGHER THAN THE TREE'S ORIGINAL GRADE 75mm MIN. S.P.M. MULCH PLANTING SOIL MIX. COMPACT TO ELIMINATE AIR POCKETS AND PREVENT SETTLEMENT. - ROOT BARRIER, FILTER FABRIC, WATER PROOFING MEMBRANE, DRAINAGE COURSE AND ROOF SLAB BY OTHERS -COMPACT SOIL BENEATH ROOT (2) DECIDUOUS TREE PLANTING ON SLAB

CUT AND REMOVE BURLAP FROM TOP OF ROOT BALL I PRUNE (TO SUIT SPECIES) TO REMOVE DAMAGED BRANCHÈS FOLLOWING PROPER HORTICULTURAL PRACTICES. DO NOT PRUNE LEADER. SECURE MULTI-STEMMED SPECIMEN SHRUBS AT MAIN BRANCH WITH WOOD STAKE 38x38x2000mm WITH TIES. TIES SHALL BE GREEN ARBORTIE. TIES SHALL FORM A LOOSE LOOP AROUND THE STAKE AND LOOP IN A FIGURE '8' AROUND THE TRUNK OF THE TREE. SECURE ARBORTIE TO THE STAKE USING "1" GALVANIZED ROOFING NAIL. 75mm DEPTH MIN. MULCH AS SPEC I REMOVE SHRUBS FROM PLASTIC AND FIBER POTS. SEE PLANT LIST FOR SPACING. SPACE SHRUBS IN STAGGERED ROWS. PLANT SHRUBS SLIGHTLY HIGHER THAN ADJACENT PLANTING SOIL MIX: LIGHTLY COMPACT AND WATER WELL TO ELIMINATE AIR POCKETS AND PREVENT SETTLEMENT. COMPACTED TOPSOIL SCARIFY SUBGRADE OF PLANTING BED

TOPSOIL IN PLANTING AREAS SHOULD BE COMPACTED TO 80-85% SPD (MAX. 150mm LIFTS) PROVIDE 600mm DEPTH FOR LARGE MULTISTEM SPECIMEN SHRUBS AND 450mm DEPTH FOR ALL OTHER

SHRUB PLANTING ON GRADE

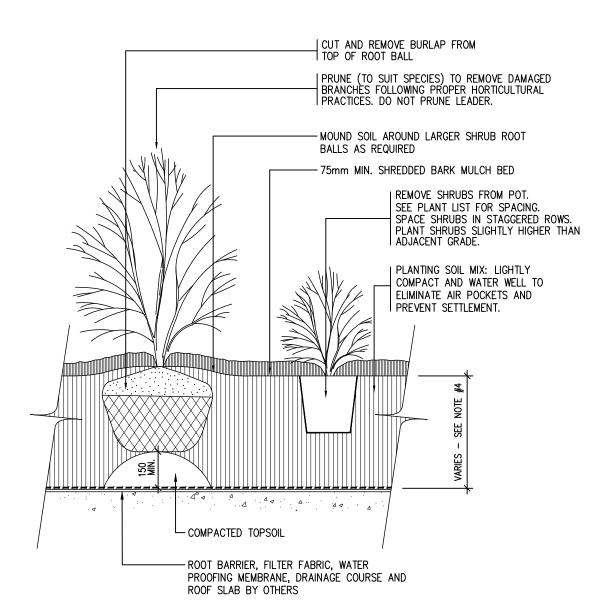

CONDITION ON SLAB WITH MIRADRAIN

- 1. PLANTING SOIL MIXTURE (MIX THOROUGHLY) AND FERTILIZER REFER TO PLANTING NOTES
- 2. SHRUBS SPECIFIED BARE ROOTS (B.R.) TO BE PLANTED SO THAT ROOTS ARE PLACED NATURALLY WITH SOIL MIX BACKFILLED CAREFULLY TO PREVENT ROOT DAMAGE.
- 3. PROVIDE 150 HIGH EARTH SAUCER AROUND SHRUB BED WITH 100 WIDE SMOOTH BED EDGE TO 4. PROVIDE 600mm DEPTH FOR LARGE MULTISTEM SPECIMEN SHRUBS AND 450mm DEPTH FOR

ALL OTHER SHRUBS.



2 Issued for SPA 2 Dec.20/23 Aug. 10/22 1 Issued for SPA 1

Date

Contractor shall check all dimensions on the work and report any discrepancy to the Landscape Architect before proceeding. All

drawings and specifications are the property of the Landscape Architect and must be returned at the completion of the work. This drawing is not to be used for construction until signed by the


Landscape Architect.

Revision City Approval Stamp

No. Description

Revision

City Approval Stamp

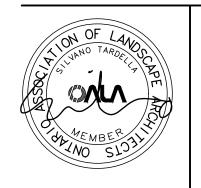

NAK design strategies


Job No. 22-048


421 RONCESVALLES AVENUE, TORONTO, ON M6R 2N1 CANADA T 416.340.8700 F 416.340.7100 NAKDESIGNSTRATEGIES.COM

MARTILLAC DUC **BLOCK B** 1359 Dundas St W

SOFTSCAPE DETAILS

Date April 2022 Scale As Noted Drawn jg Checked tfg

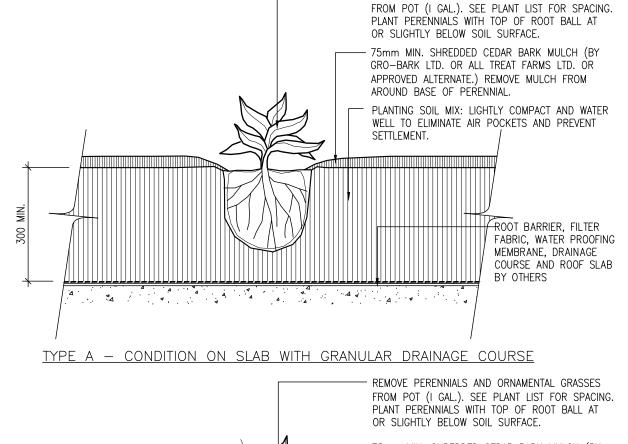

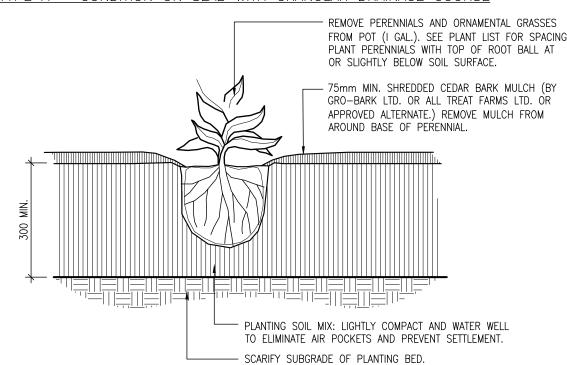

TYPE B - CONDITION ON GRADE


1. PLANTING SOIL MIXTURE (MIX THOROUGHLY) 6-PARTS GOOD QUALITY TOP SOIL, 2-PARTS

2. IF PLANT IS ROOT-BOUND AFTER REMOVING FROM POT, BREAK UP ROOT BALL WITH SHARP KNIFE. ENSURE ROOT BALL IS MOIST BEFORE PLANTING.

CUT AS REQUIRED TO INSTALL PLANTING.


(5) PERENNIAL PLANTING NTS


REMOVE PERENNIALS AND ORNAMENTAL GRASSES

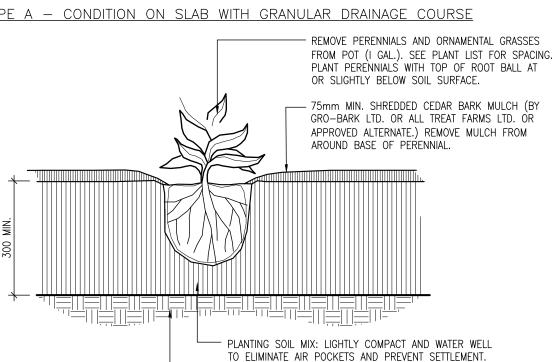

WELL-ROTTED COW MANURE, 1-PART PEAT MOSS.

3. WEED BARRIER BY TERRAFIX OR APPROVED EQUIVALENT. OVERLAP MAT MIN. 150mm AND

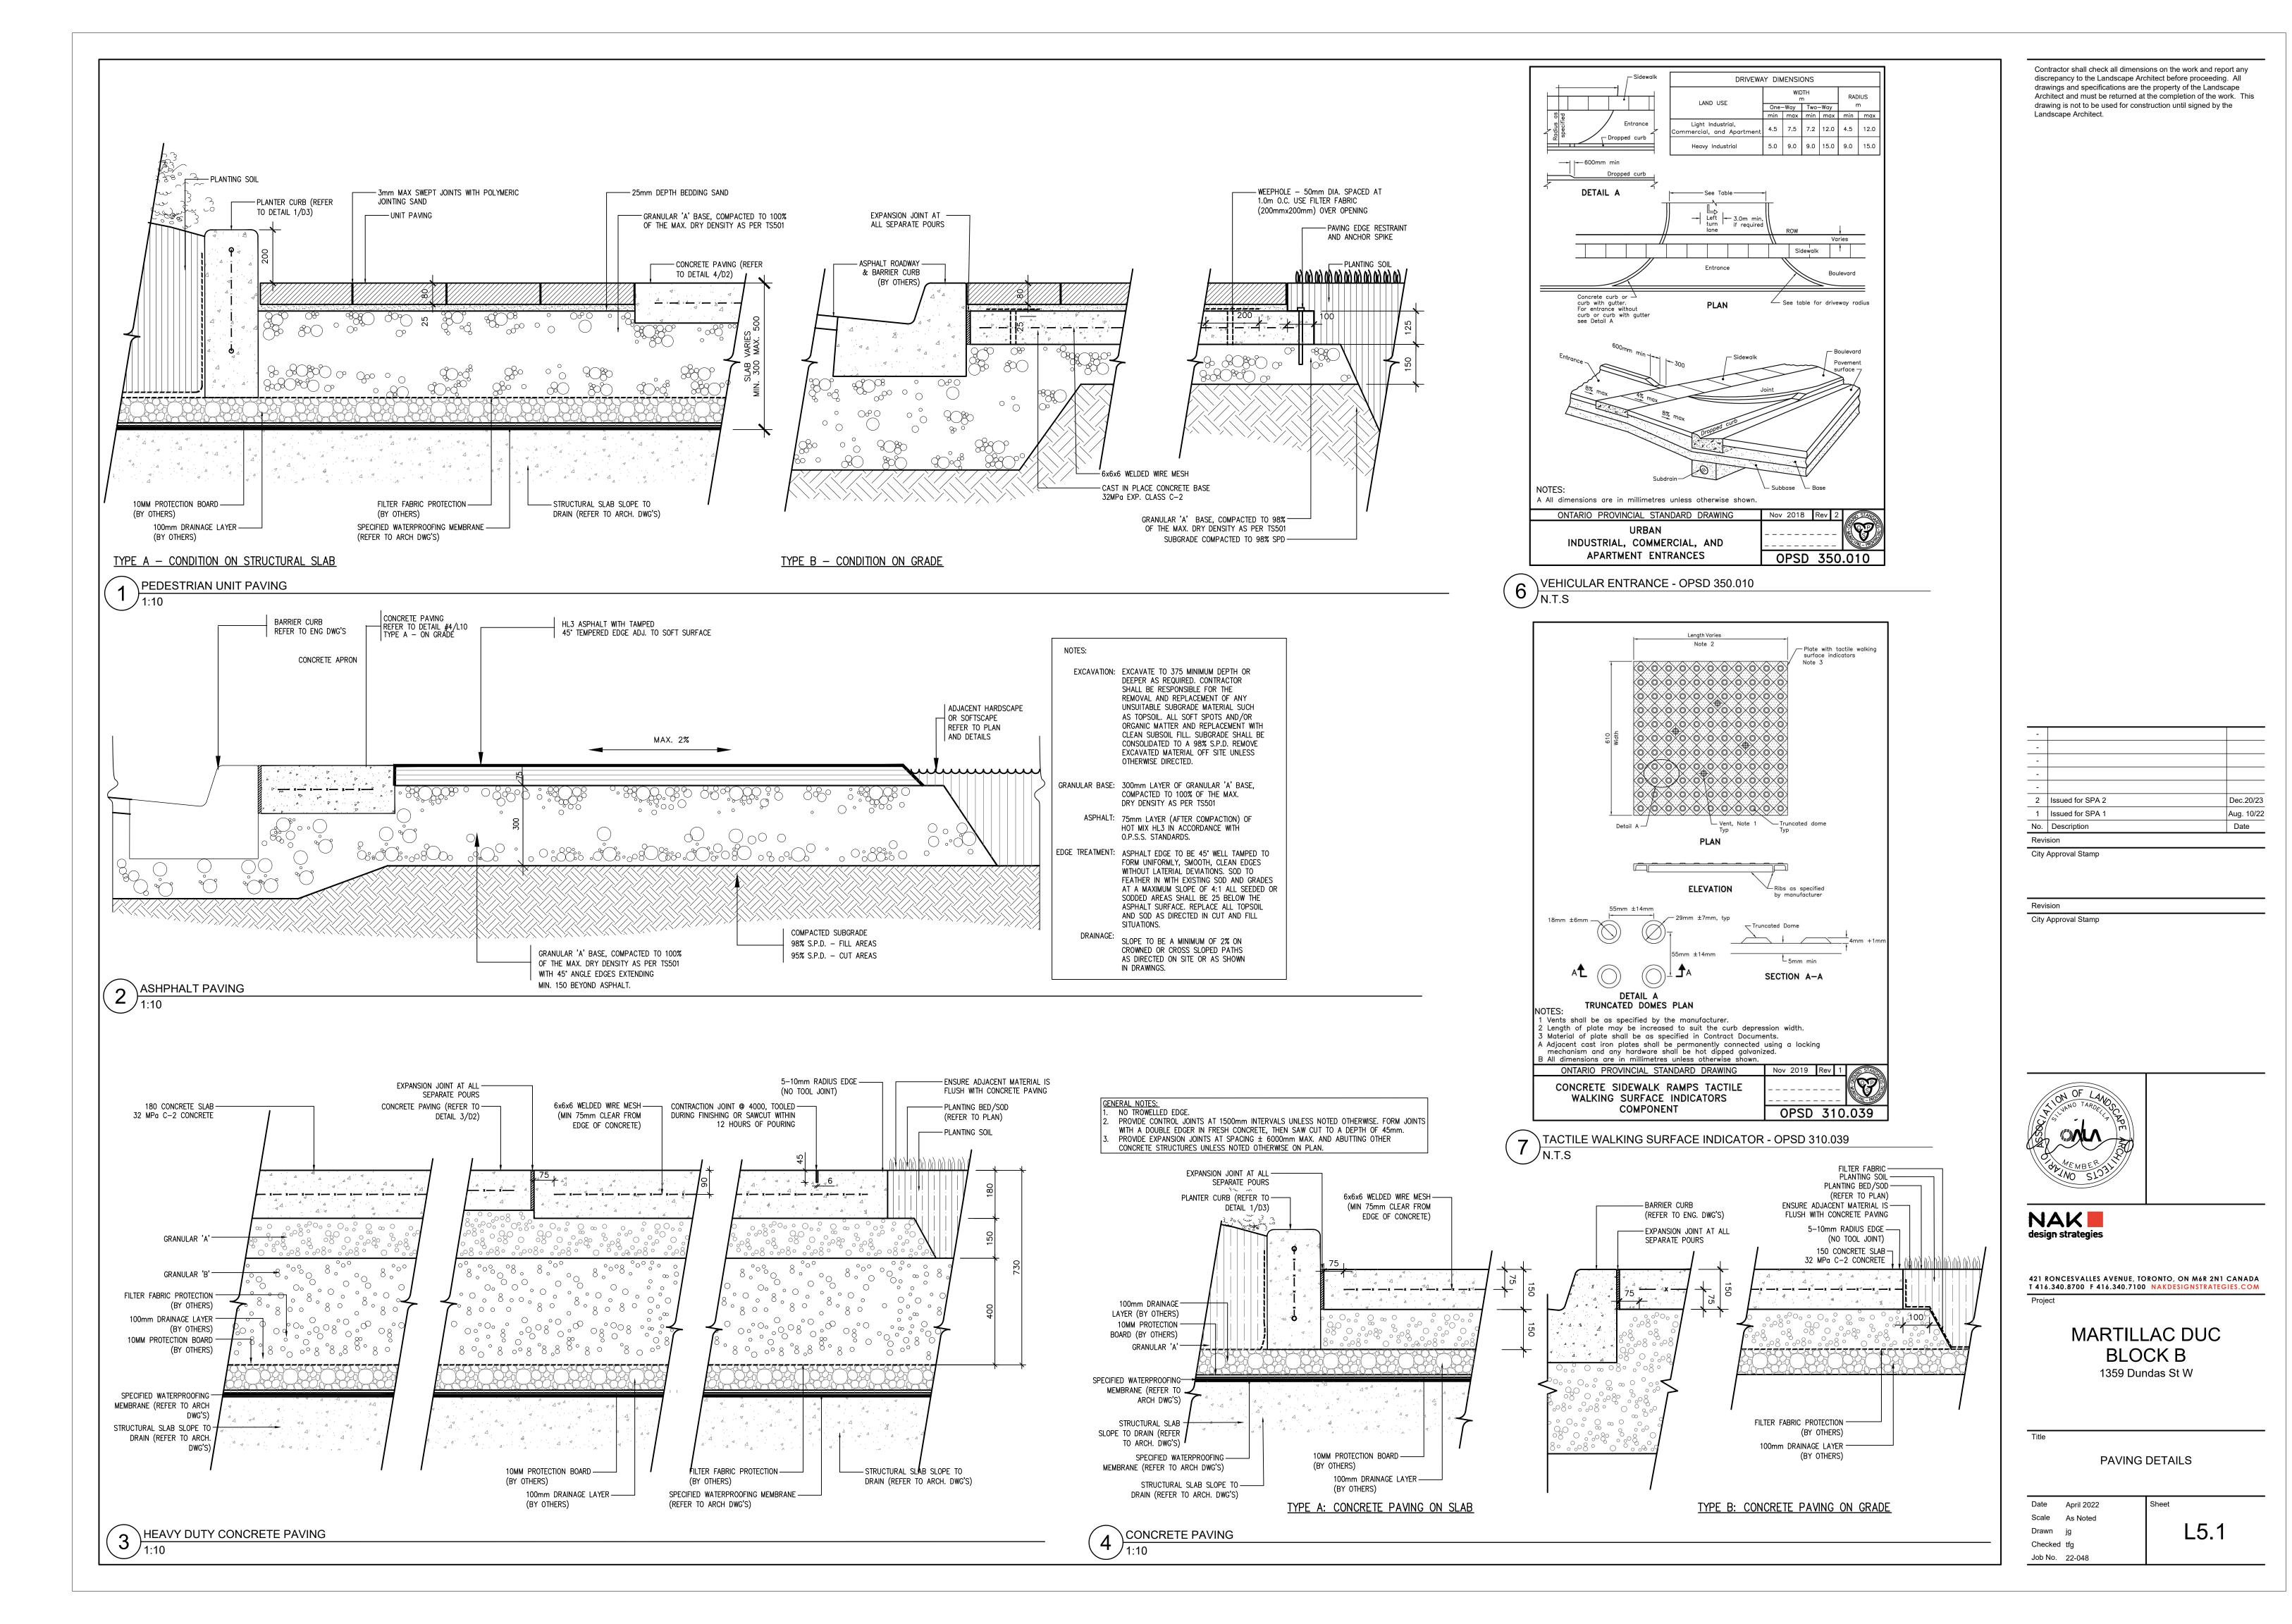

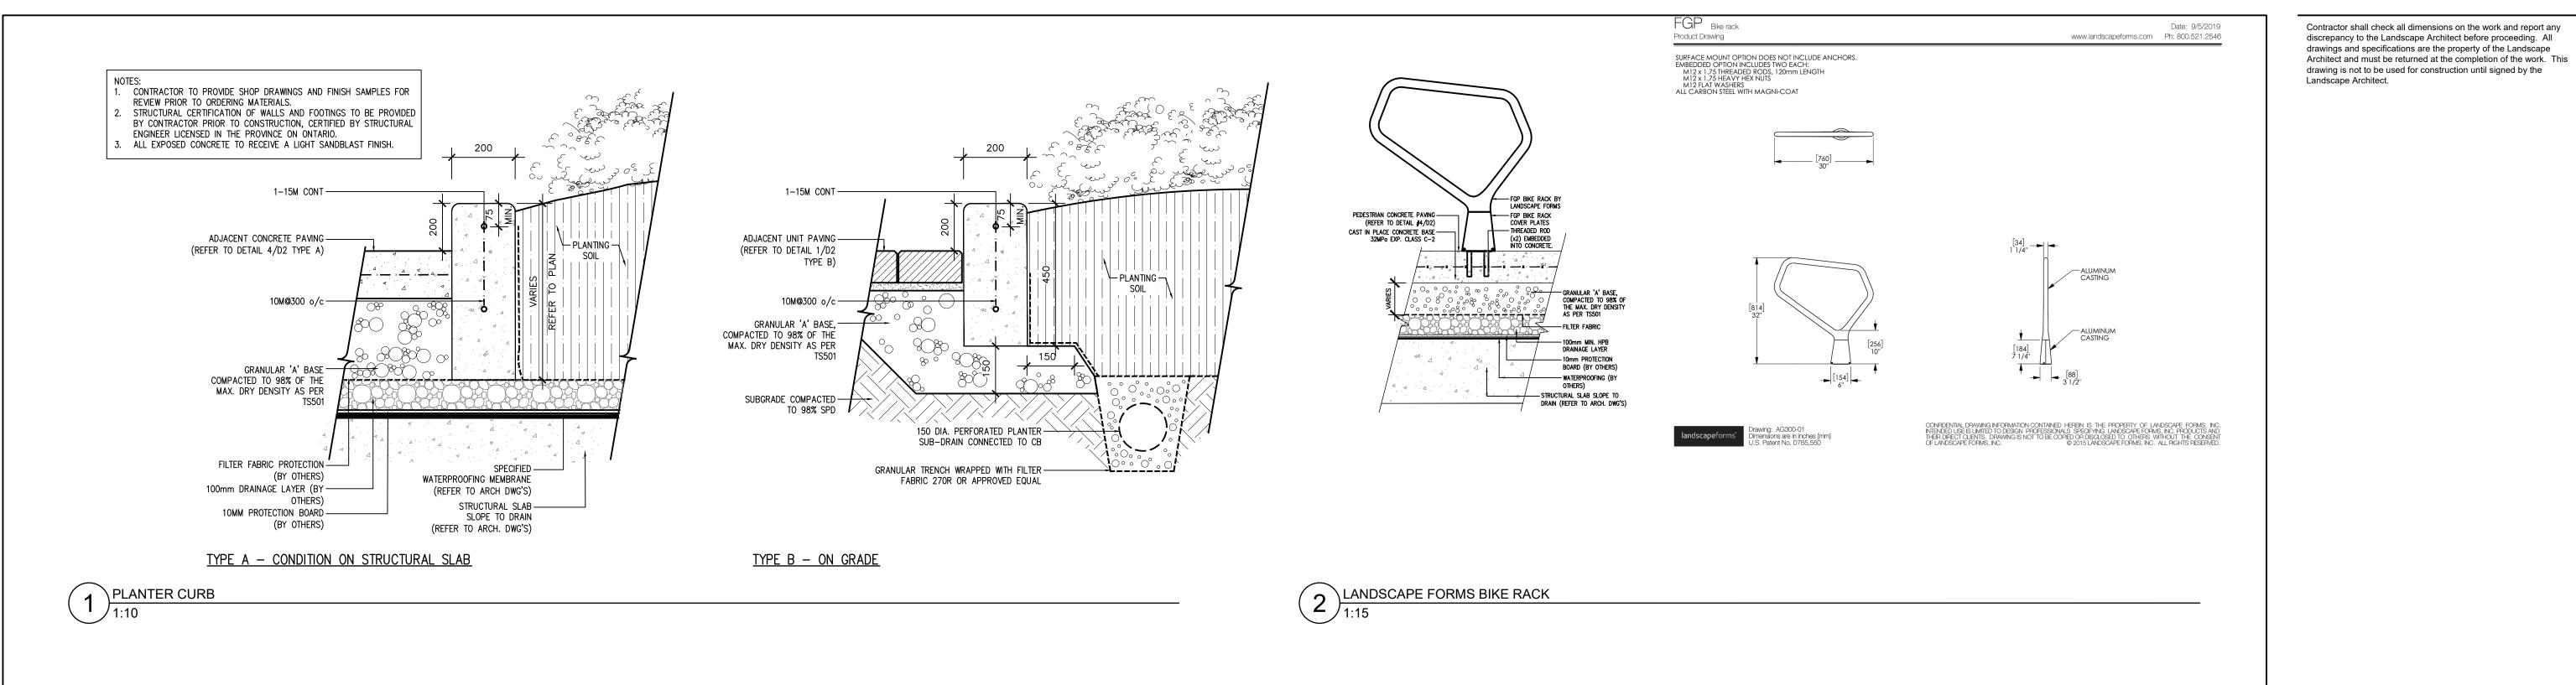

FOR WHATEVER THE WORLD THROWS AT US: VUMEKO_® THE LITTER AND RECYCLING BIN SPECIALISTS

ARCONAS

DATA SHEET

KENDO floor-standing bin 65211 with dog waste bag dispenser

Volume: 60 litres **(15.85 Gal)**

galvanised steel plate, powder coated in DB702, Casing material:

inc. "Wipe, and it's gone"

2.0 - 4.0 mm (0.08 – 0.16 in) Casing material thickness: galvanised steel plate Inner container material:

470mm (18.5 in) Width:

320mm (12.6 in) Depth: 900mm (35.4 in) Height:





Copyright declaration: All sketches, drawings and electronic information are the property of AUWEKO GmbH in Neu-Isenburg. The use of these documents, hard copies or information is permitted for internal purposes only. Forwarding to third parties is not authorised. Subject to technical alteration. © AUWEKO GmbH, 63263 Neu-Isenburg






DETAIL


LOG STEPPER SPACING

Clearance






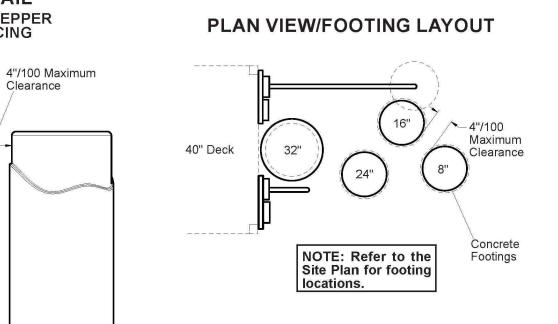


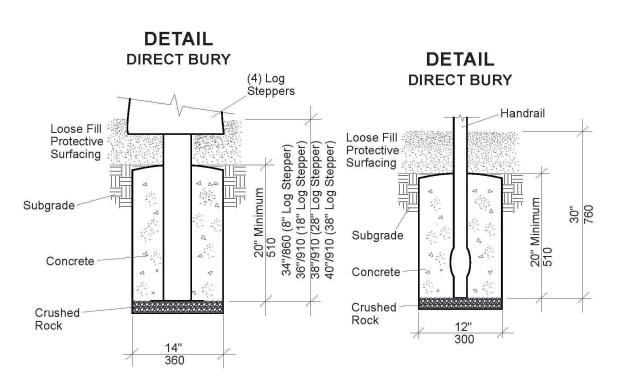

PlayShaper® 185861 Log Steppers, 40" Sheet 2 of 2
601 7TH STREET SOUTH, DELANO, MINNESOTA 55328-8605 888-574-4678 LSI Install Help 888-438-6574 LSI Direct 763-972-5200 Int. FAX (763) 972-3185



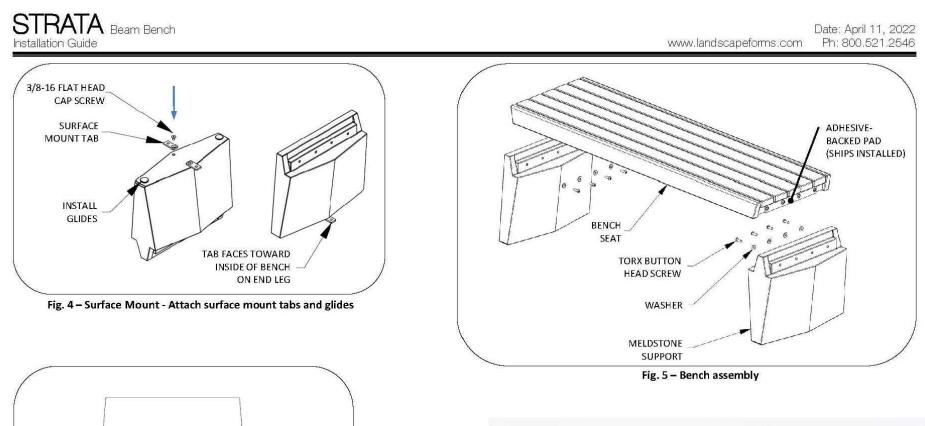

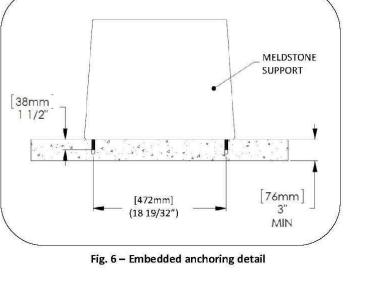




5 STRATA BENCH BY LANDSCAPE FORMS NTS

-		
-		
2	Issued for SPA 2	Dec.20/23
1	Issued for SPA 1	Aug. 10/22
No.	Description	Date
Revis	sion	<u> </u>

City Approval Stamp

City Approval Stamp

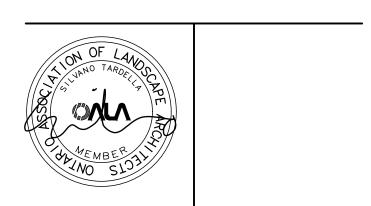



421 RONCESVALLES AVENUE, TORONTO, ON M6R 2N1 CANADA T 416.340.8700 F 416.340.7100 NAKDESIGNSTRATEGIES.COM

MARTILLAC DUC **BLOCK B** 1359 Dundas St W

LANDSCAPE DETAILS

Date April 2022 Scale As Noted L5.2 Drawn jg Checked tfg Job No. 22-048

