

| PARKING STATISTICS By-law 2014-14 | | | |
|---|--|--|--|
| Above Ground Parking (AB) (3 Levels) | AB Level 1 = 23 parking spaces AB Level 2 = 23 parking spaces AB Level 3 = 23 parking spaces | | |
| | UG Levels 1 to 3 = 85 parking spaces | | |
| Underground Parking (UG) | UG Levels 4 & 5 = 97 parking spaces | | |
| | UG Level 6 = 99 parking spaces | | |
| Street Level Parking | 5 spaces (including 2 barrier-free) | | |
| Loading Space Provided | 1 space | | |
| Required Parking: | | | |
| Commercial (Ground) | 1.0 per 18.0m ² net floor area. | | |
| Office (1 Floor) | 1.0 per 35.0m ² net floor area. | | |
| Residential | a) 1.0 per dwelling where the unit has less than 75.0m² net floor area. b) 1.25 per dwelling for all other units. Visitor Parking: Of the total number of parking spaces required, 0.25 of the parking spaces required per dwelling shall be designed as visitors parking spaces. | | |
| Barrier-Free | 3 to 25 spaces = 1 space 26 to 100 spaces = 4% 101 to 200 spaces = 1, plus 3% of the total no. of spaces 201 to 1000 spaces = 2, plus 2% of the total no. of spaces | | |
| TOTAL PARKING REQUIRED | 575 (including 14 barrier-free) | | |
| TOTAL PARKING PROPOSED | 622 Parking Spaces (including 14 barrier-free) | | |
| Min. No. of Bicycle Parking Sp | paces Required: | | |
| Retail Uses: Office Uses: Residential Uses: | The greater of 2 or 1.0 per 1,000m ² net floor area. The greater of 2 or 1.0 per 1,000m ² net floor area. Apartment Building - 1.0 per dwelling. Visitor Spaces: Of the total number of bicycle parking spaces required, 0.25 of the parking spaces required per dwelling shall be designed as visitors bicycle parking. | | |
| Total Bicycle Parking Required: | 392 bicycle parking spaces (racks) | | |
| Bicycle Parking Provided: | 400 bicycle parking spaces (racks) | | |

| ZONING STATISTICS By-law 2014-14 | | | | |
|---|--------------------------------------|-----------------------------|--|--|
| Zoned MTE - Midtown Transitional Employment | | | | |
| Proposed MU4 Mixed Use Zone - Urban Core | | | | |
| MTE REGULATIONS | REQUIRED | PROPOSED | | |
| Min. Lot Frontage | Shall be as legally | 53.90m (existing) | | |
| Min. Lot Area | existing as of the effective date of | 0.42 Ha (existing) | | |
| Max. Lot Coverage | this By-law. | 37.02% | | |
| MU4 REGULATIONS | | | | |
| Min. Front Yard | 1.0m | 5.0m (from 4.0m expr. line) | | |
| Max. Front Yard | 5.0m | 5.0m (from 4.0m expr. line) | | |
| Min. Interior Side Yard | 0.0m | 5.40m (W); 11.89m (E) | | |
| Min. Rear Yard | 0.0m | 32.23m | | |
| Min. No. of Storeys | 8 storeys | 58 storeys | | |
| Max. No. of Storeys | 12 storeys | 58 storeys | | |
| Min. First Storey Height | 4.5m | 4.5m | | |
| Min. Height | | 175.5m | | |
| Max. Height | | 175.5m | | |
| Max. Net Floor Area | 1,400m ² | 1,570.84m ² | | |

SITE STATISTICS Cont'd:

SITE AREA = 1.05 acre (0.42 ha) 4,243.25 m2 (45,673.96 sq.ft.)

PROPOSED BLDG. FOOTPRINT - (Mixed-Use)
AREA = 1,570.84 m2 (16,908.38 sq.ft.)

ABOVE GROUND PARKING FOOTPRINT - FLOOR LEVELS 2nd - 4th AREA = 1,570.84 m2 (16,908.38 sq.ft.)

OFFICE FOOTPRINT - 5th FLOOR LEVEL AREA = 1,470.41 m2 (15,827.36 sq.ft.)

<u>RESIDENTIAL FOOTPRINT 1</u> - FLOOR LEVELS 6th - 40th AREA = 725.19 m2 (7,805.88 sq.ft.)


RESIDENTIAL FOOTPRINT 2 - FLOOR LEVELS 41th - 58th AREA = 458.42 m2 (4,934.39 sq.ft.)

TOTAL BUILDING - 58 Storeys AREA = 41,386.98 m2 (445,485.74 sq.ft.)

LOT COVERAGE = 36.58 %

LANDSCAPED AREA = 853.74 m2 (9,189.58 sq.ft.) = 20.12 %

PAVED / CONCRETE AREA(S) = 1,818.67 m2 (19,576.0 sq.ft.)

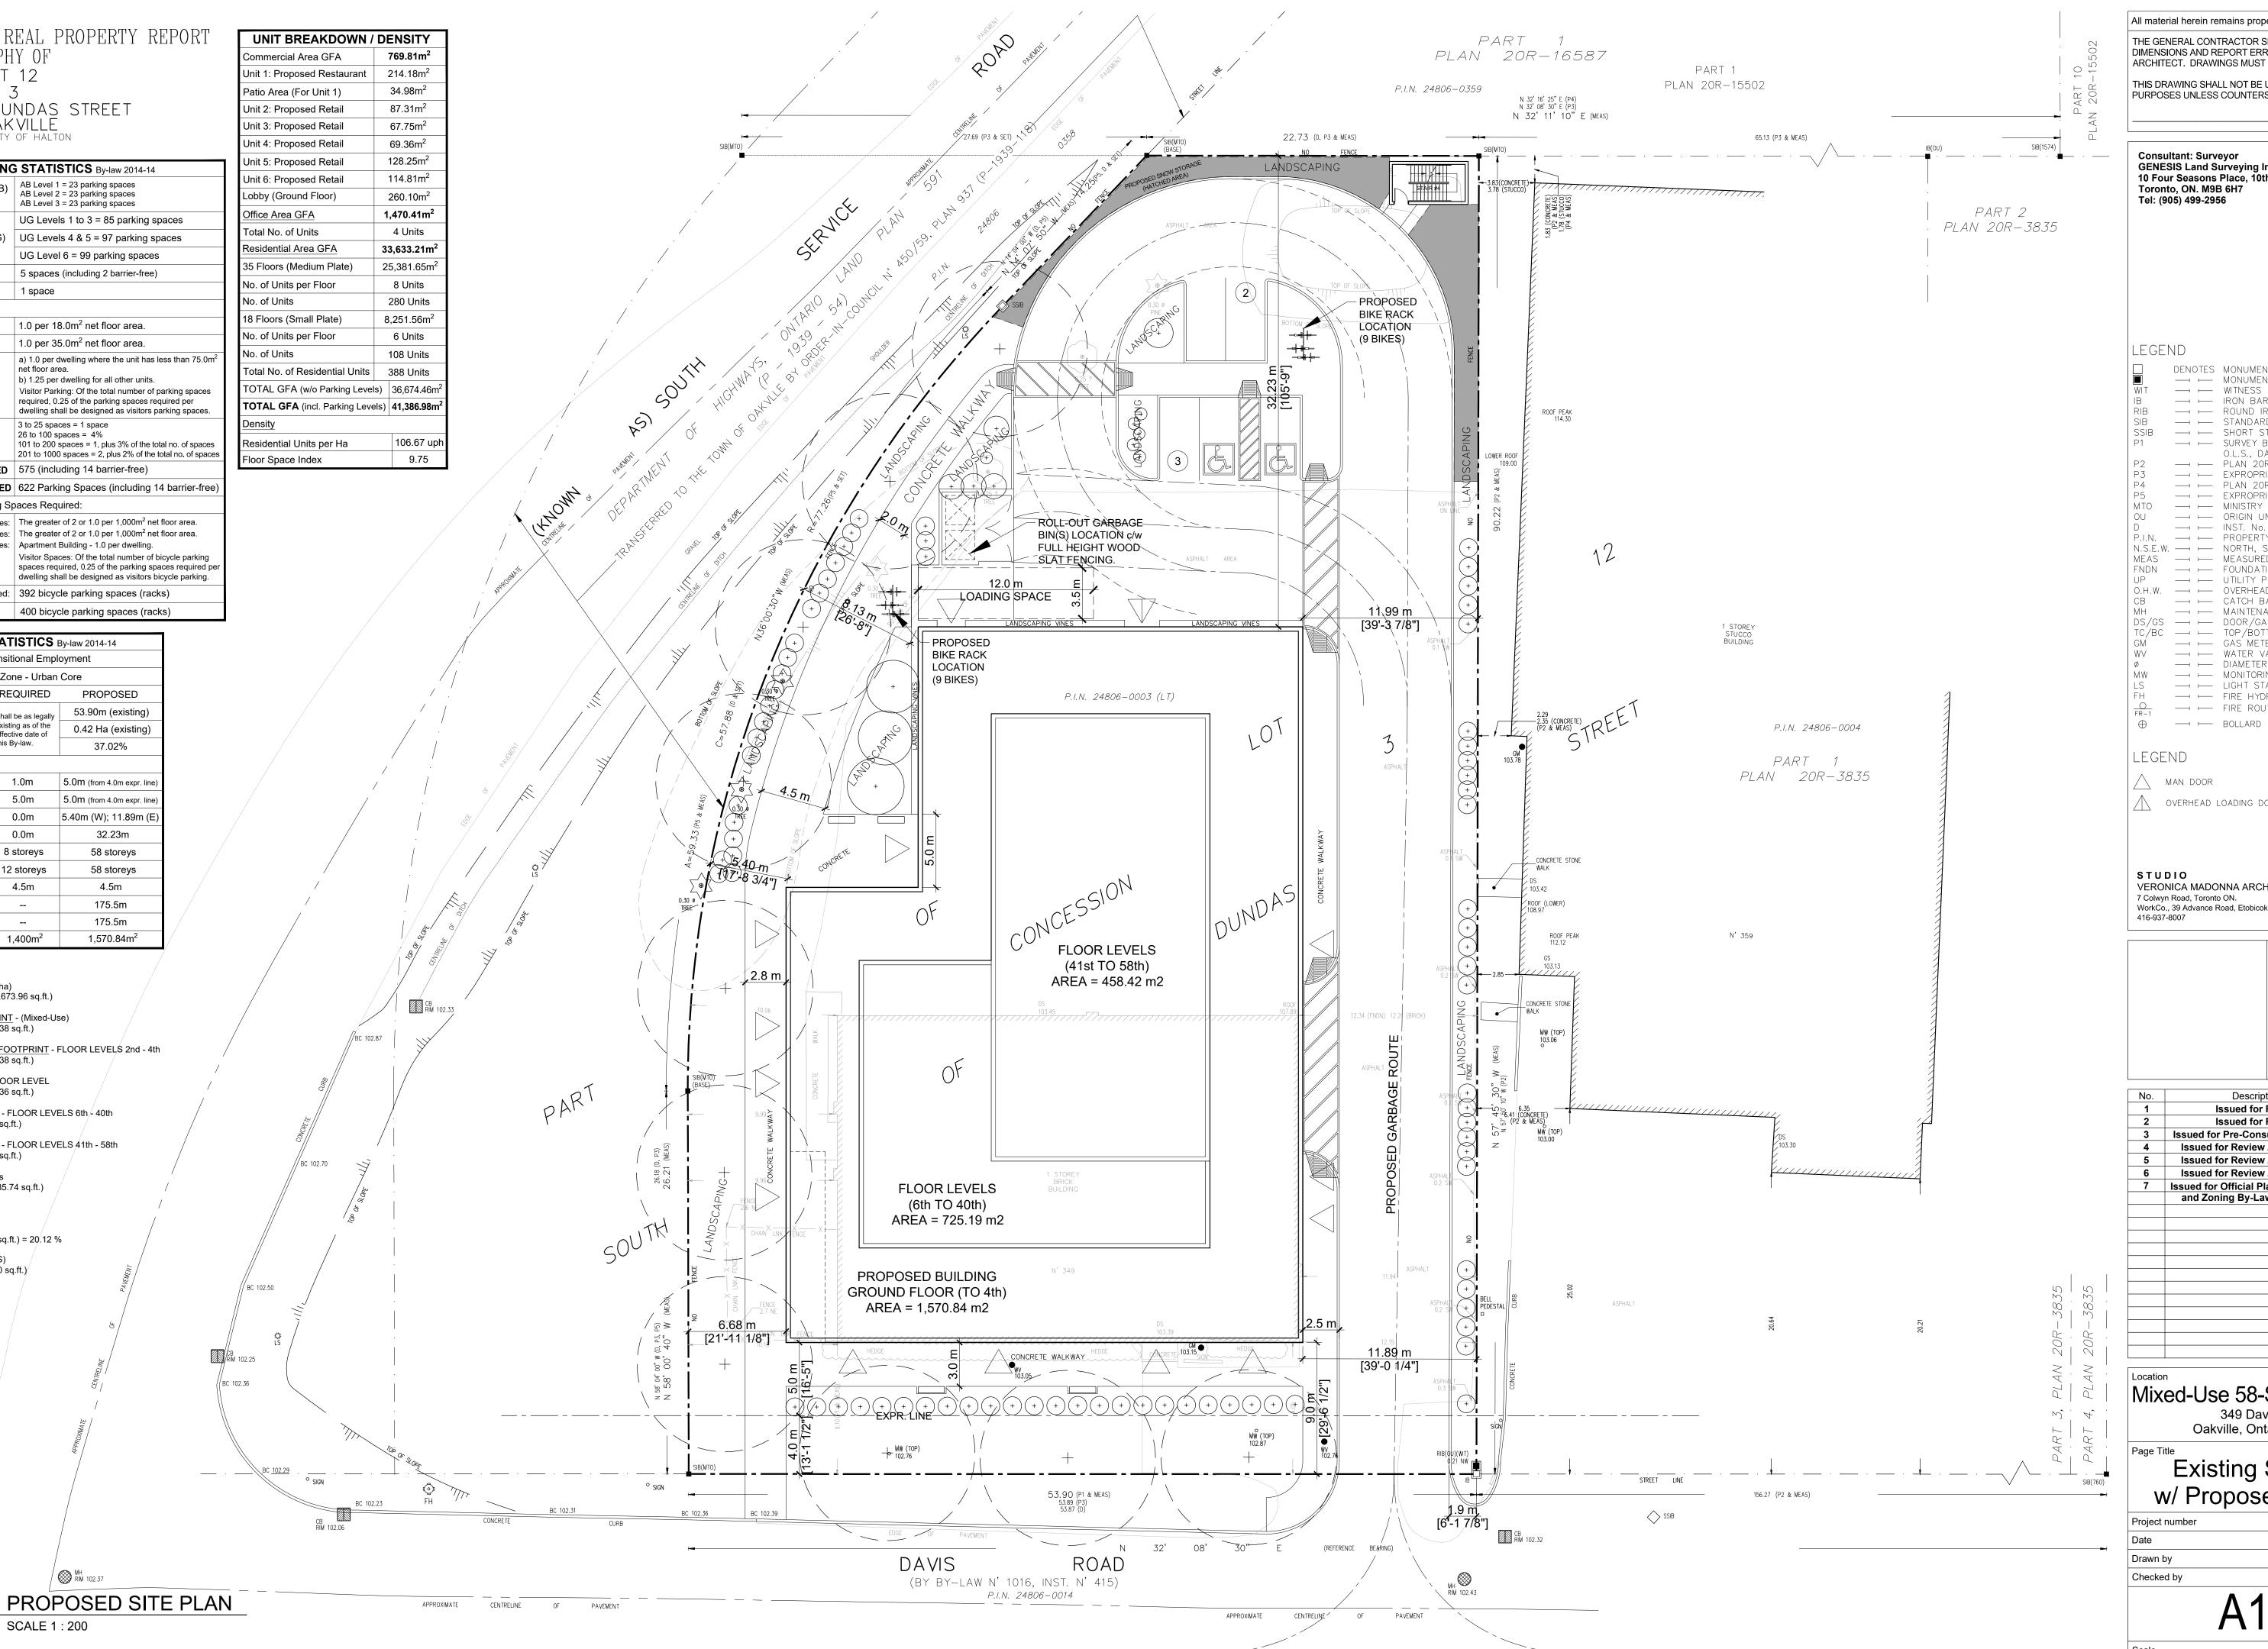

All material herein remains property of the architect noted below. THE GENERAL CONTRACTOR SHALL REPORT AND VERIFY ALL DIMENSIONS AND REPORT ERRORS AND OMISSIONS TO THE ARCHITECT. DRAWINGS MUST NOT BE SCALED.

THIS DRAWING SHALL NOT BE USED FOR CONSTRUCTION PURPOSES UNLESS COUNTERSIGNED BY:

Consultant: Surveyor GENESIS Land Surveying Inc. 10 Four Seasons Place, 10th floor Toronto, ON. M9B 6H7 Tel: (905) 499-2956 LEGEND

---- WITNESS

→ F IRON BAR → FOUND IRON BAR → F SHORT STANDARD IRON BAR ── SURVEY BY TARASICK & McMILLAN

O.L.S., DATED FEBRUARY 19TH, 2004 → FXPROPRIATION PLAN 1335 — → FLAN 20R-16587

→ F ORIGIN UNKNOWN P.I.N. — PROPERTY IDENTIFICATION NUMBER N.S.E.W. — HORTH, SOUTH, EAST, WEST MEAS → ← MEASURED FNDN ---- FOUNDATION UP → ← UTILITY POLE

O.H.W. — POVERHEAD UTILITY CABLES CB — ← CATCH BASIN MH — MAINTENANCE HOLE DS/GS → ← DOOR/GARAGE SILL ELEVATION TC/BC → ← TOP/BOTTOM OF CURB → ← GAS METER


---- WATER VALVE ---- DIAMETER ---- MONITORING WELL ─ ⊢ LIGHT STANDARD ── FIRE HYDRANT → FIRE ROUTE SIGNS

LEGEND

MAN DOOR OVERHEAD LOADING DOOR

STUDIO
VERONICA MADONNA ARCHITECT
7 Colwyn Road, Toronto ON.



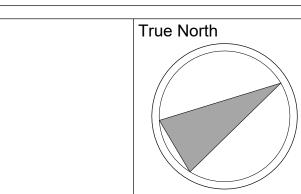

| No. | Description | Date | | |
|----------|-------------------------------------|-------------|--|--|
| 1 | Issued for Review | APR. 08/22 | | |
| 2 | Issued for Review | APR. 28/22 | | |
| 3 | Issued for Pre-Consultation Meeting | MAY 06/22 | | |
| 4 | Issued for Review / Coordination | MAY 30/22 | | |
| 5 | Issued for Review / Coordination | July 05/22 | | |
| 6 | Issued for Review / Coordination | Aug. 10/22 | | |
| 7 | Issued for Official Plan Admendment | | | |
| | and Zoning By-Law Amendment | Sept. 14/22 | | |
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Mixed-Use 58-Storey Building 349 Davis Road Oakville, Ontario L6J 2X2

Existing Site Plan w/ Proposed Building

JAN. D.D. Drawn by V.M. Checked by

as noted

\A100 SCALE 1:200